### DEPARTMENT OF PLANNING AND COMMUNITY DEVELOPMENT



1010 10<sup>TH</sup> Street, Suite 3400, Modesto, CA 95354 Planning Phone: (209) 525-6330 Fax: (209) 525-5911 Building Phone: (209) 525-6557 Fax: (209) 525-7759

# Referral Early Consultation

Date: January 12, 2024

To: Distribution List (See Attachment A)

From: Emily DeAnda, Assistant Planner

**Planning and Community Development** 

Subject: GENERAL PLAN AMENDMENT, REZONE, AND PARCEL MAP

APPLICATION NO. PLN2022-0085 - WESTLEY TRIANGLE TRUCK STOP

Respond By: January 29, 2024

### \*\*\*\*PLEASE REVIEW REFERRAL PROCESS POLICY\*\*\*\*

The Stanislaus County Department of Planning and Community Development is soliciting comments from responsible agencies under the Early Consultation process to determine: a) whether or not the project is subject to CEQA and b) if specific conditions should be placed upon project approval.

Therefore, please contact this office by the response date if you have any comments pertaining to the proposal. Comments made identifying potential impacts should be as specific as possible and should be based on supporting data (e.g., traffic counts, expected pollutant levels, etc.). Your comments should emphasize potential impacts in areas which your agency has expertise and/or jurisdictional responsibilities.

These comments will assist our Department in preparing a staff report to present to the Planning Commission. Those reports will contain our recommendations for approval or denial. They will also contain recommended conditions to be required should the project be approved. Therefore, please list any conditions that you wish to have included for presentation to the Commission as well as any other comments you may have. Please return all comments and/or conditions as soon as possible or no later than the response date referenced above.

Thank you for your cooperation. Please call (209) 525-6330 if you have any questions.

Applicant: Daniel Barnes, RMK Design, Inc.

Project Location: 7001 and 7003 South McCracken Road, between North Interstate-5 and the

California Aqueduct, in the Westley area.

APN: 016-036-028

Williamson Act

Contract: N/A

General Plan: Agriculture

Current Zoning: General Agriculture (A-2-40)

Project Description: Request to amend the General Plan and zoning designations of a 50± acre parcel from Agriculture and General Agriculture (A-2-40) to Planned Development (P-D), and to subdivide the parcel into three parcels (16.0±, 24.0±, and 10.1± acres in size), to allow for a cargo container storage yard, a truck stop and a church. The parcel is currently under an active code enforcement case as an unpermitted cargo container storage yard. An amendment to the General Plan designation and rezone is required to bring the project site into compliance.

The project site is currently developed with a 1,752± square-foot manufactured dwelling and 400± square-foot carport. Proposed Parcel 1 is 16.0± acres in size and contains the existing manufactured dwelling and carport which are proposed to be demolished to allow the development of a cargo container storage depot yard consisting of 764 asphalt stalls for the storage of cargo

containers for use by various transportation companies. The cargo containers will be stacked two-high by large forklift tractors for a total storage capacity of 1,528 cargo containers and will be stored on-site awaiting transportation to other facilities. Goods to be contained within the cargo containers will include general goods such as, dry goods, passenger vehicle batteries, or other similar commodities. Hours of operation for the cargo container storage yard will be 24 hours a day, seven days a week.

Proposed Parcel 2 is 24.0± acres in size and is proposed to be developed with a truck stop consisting of overnight parking and a single-story, 28±-foot-tall, 14,869± square-foot commercial building. The commercial building will be accessible by the traveling public and will contain: a semi-truck wash area; a repair shop for semi-truck repairs with a tire storage area; an office and employee breakroom area; restrooms; and convenience market. The applicant proposes to develop an asphalt lot containing 253± parking stalls for overnight parking of semi-trucks used for the hauling of a variety of products including commercial and agricultural commodities, and hazardous materials. Hours of operation for the truck parking, repair shop services and convenience market will be 24 hours a day, seven days a week. The applicant anticipates employing 15-20 employees for the repair shop and convenience market uses. Additionally, a 400± square-foot security booth will also be constructed adjacent to the eastern property line. Three security guards for the project site will be present 24 hours a day seven days a week. Total employee vehicle trips for the uses on Proposed Parcel 2 will be a maximum of 23 per-day.

Proposed Parcel 3 is 10.08± acres in size and is proposed to be developed with a future 10,000± square-foot church. The church is anticipated to have 75-100 daily attendees Monday through Saturday and a maximum of 300 attendees on Sunday. The church will operate seven days a week. Activities for the church will include worship services and prayer groups. The church will also function as an event center with a 3,500± square-foot social hall and 1,500± square-foot kitchen for food services, to be used primarily for weddings, and will be available for rent by both members of the church and the general public. While included in the rezone for a new Planned Development zoning district, the applicant has requested that the development of the church on proposed Parcel 3 be subject to the approval of a Conditional Use Permit by the Stanislaus County Planning Commission after the development of proposed Parcels 1 and 2. The use permit will evaluate site specific requirements for a church and potential impacts it may create.

As part of the proposed project, the applicant is proposing an agricultural buffer consisting of a six-foot-tall perimeter chain-link fence with privacy slats be placed along the north, west, and east property lines of the project site. In addition to the proposed fencing, evergreen trees are proposed to be installed along the north and west portions of the project site, adjacent to the surrounding agricultural-zoned parcels. Additionally, the applicant proposes to install shade trees and evergreen ground cover around the proposed building footprint, and palm trees along South McCracken Road frontage for Proposed Parcel 2. The applicant proposes to cover approximately 505,771 square feet of the southern portion of the project site across Proposed Parcels 2 and 3 with either gravel or crushed almond shells. Proposed signage for the project site consists of a 35-foot-tall pylon sign for the traveling public on State Route 33 and a six-foot-tall monument sign to be located on Proposed Parcel 2 for all uses on the project site.

Stormwater for the entire development will be managed via two stormwater retention basins. One basin will be developed on the northwest portion of Proposed Parcel 3, and the second basin will be developed on the northeast portion of Proposed Parcel 2. There are two existing PG&E easements that are located across the project site; the existing 15-foot-wide easement will be located on the northeastern portions of each proposed parcel; and a 50-foot-wide easement will run along the western property lines of Proposed Parcel 2 and 3, and the southern property line of Proposed Parcel 2. An existing drainage easement (which is for the purposes of maintaining stormwater coming off Interstate-5) is located on the southwestern property line of Proposed Parcel 2 and a telephone easement is located across the northeastern portions of Proposed Parcels 1 and 2, and the northeastern corner of Proposed Parcel 3. The truck stop on Proposed Parcel 2, and the church on Proposed Parcel 3 will each be served by private septic systems and wells; Proposed



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Parcel 1, which will be developed with the cargo container storage yard, will not be developed with or have any septic or water service connections for the site.

Proposed Parcel 2 will take direct access from County-maintained South McCracken Road via a 40-foot-wide driveway, while Proposed Parcels 1 and 3 will gain access to South McCracken Road via a proposed 26-foot-wide irrevocable reciprocal access easement from Proposed Parcel 2. The applicant anticipates the grading and construction to take place in two phases. The first phase will include the development of Proposed Parcels 1 and 2, to begin upon project approval. The second phase, for development of the church site on Proposed Parcel 3, will begin with submittal of land use entitlements, will occur prior to 2025.

Full document with attachments available for viewing at: http://www.stancounty.com/planning/pl/act-projects.shtm



## GENERAL PLAN AMENDMENT, REZONE, AND PARCEL MAP APPLICATION NO. PLN2022-0085 – WESTLEY TRIANGLE TRUCK STOP

Attachment A

Distribution List

Distri	bution List		
Х	CA DEPT OF CONSERVATION Land Resources		STAN CO ALUC
Х	CA DEPT OF FISH & WILDLIFE		STAN CO ANIMAL SERVICES
Х	CA DEPT OF FORESTRY & FIRE PROTECTION (CAL FIRE)	Х	STAN CO BUILDING PERMITS DIVISION
Х	CA DEPT OF TRANSPORTATION DIST 10	Χ	STAN CO CEO
Χ	CA OPR STATE CLEARINGHOUSE		STAN CO CSA
Х	CA RWQCB CENTRAL VALLEY REGION	Х	STAN CO DER
Χ	CA DEPT OF WATER RESOURCES		STAN CO ERC
Х	CEMETERY DISTRICT: PATTERSON	Х	STAN CO FARM BUREAU
Х	CENTRAL VALLEY FLOOD PROTECTION	Х	STAN CO HAZARDOUS MATERIALS
	CITY OF:		STAN CO PARKS & RECREATION
	COMMUNITY SERVICES DIST:	Х	STAN CO PUBLIC WORKS
Х	COOPERATIVE EXTENSION		STAN CO RISK MANAGEMENT
Х	COUNTY OF: SAN JOAQUIN	Х	STAN CO SHERIFF
X	DER GROUNDWATER RESOURCES DIVISION	Х	STAN CO SUPERVISOR DIST FIVE: C. CONDIT
Х	FIRE PROTECTION DIST: WEST STANISLAUS	Х	STAN COUNTY COUNSEL
Χ	GSA: DELTA-MENDOTA II	Χ	StanCOG
Х	HOSPITAL DIST: DEL PUERTO HEALTHCARE DISTRICT	Х	STANISLAUS FIRE PREVENTION BUREAU
Х	IRRIGATION DIST: DEL PUERTO WATER DISTRICT	Х	STANISLAUS LAFCO
Х	MOSQUITO DIST: TURLOCK	X	STATE OF CA SWRCB DIVISION OF DRINKING WATER DIST. 10
Х	STANISLAUS COUNTY EMERGENCY MEDICAL SERVICES		SURROUNDING LANDOWNERS
	MUNICIPAL ADVISORY COUNCIL:		INTERESTED PARTIES
Χ	PACIFIC GAS & ELECTRIC	Χ	TELEPHONE COMPANY: AT&T
	POSTMASTER:	Х	TRIBAL CONTACTS (CA Government Code §65352.3)
	RAILROAD:	Х	US ARMY CORPS OF ENGINEERS
Х	SAN JOAQUIN VALLEY APCD	Х	US FISH & WILDLIFE
Х	SCHOOL DIST 1: PATTERSON JOINT UNIFIED		US MILITARY (SB 1462) (7 agencies)
	SCHOOL DIST 2:	Х	USDA NRCS
Х	WORKFORCE DEVELOPMENT	Х	SAN LUIS & DELTA-MENDOTA WATER AUTHORITY
Х	STAN CO AG COMMISSIONER		
	· · · · · · · · · · · · · · · · · · ·		

### STANISLAUS COUNTY CEQA REFERRAL RESPONSE FORM

TO:	Stanislaus County Planning & Community Development 1010 10 <sup>th</sup> Street, Suite 3400 Modesto, CA 95354				
FROM:					
SUBJECT:		AMENDMENT, REZONE, AND 85 – WESTLEY TRIANGLE TRI			
Based on this project:	s agency's particul	lar field(s) of expertise, it is ou	r position the above described		
		gnificant effect on the environme ficant effect on the environment.			
		s which support our determination tc.) – (attach additional sheet if r			
Listed below a	E WHEN THE MIT	tion measures for the above-list TIGATION OR CONDITION NI P, PRIOR TO ISSUANCE OF A	EEDS TO BE IMPLEMENTED		
= =	ır agency has the fo	ollowing comments (attach addit	ional sheets if necessary).		
Response pre	pared by:				
Name		Title	Date		

# WESTLEY TRIANGLE TRUCK STOP

GPA/REZ/PM PLN2022-0085

### AREA MAP

### LEGEND


Project Site

Sphere of Influence

City


—— Road

River

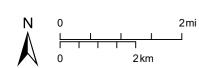

Source: Planning Department GIS


Date: 8/30/2023

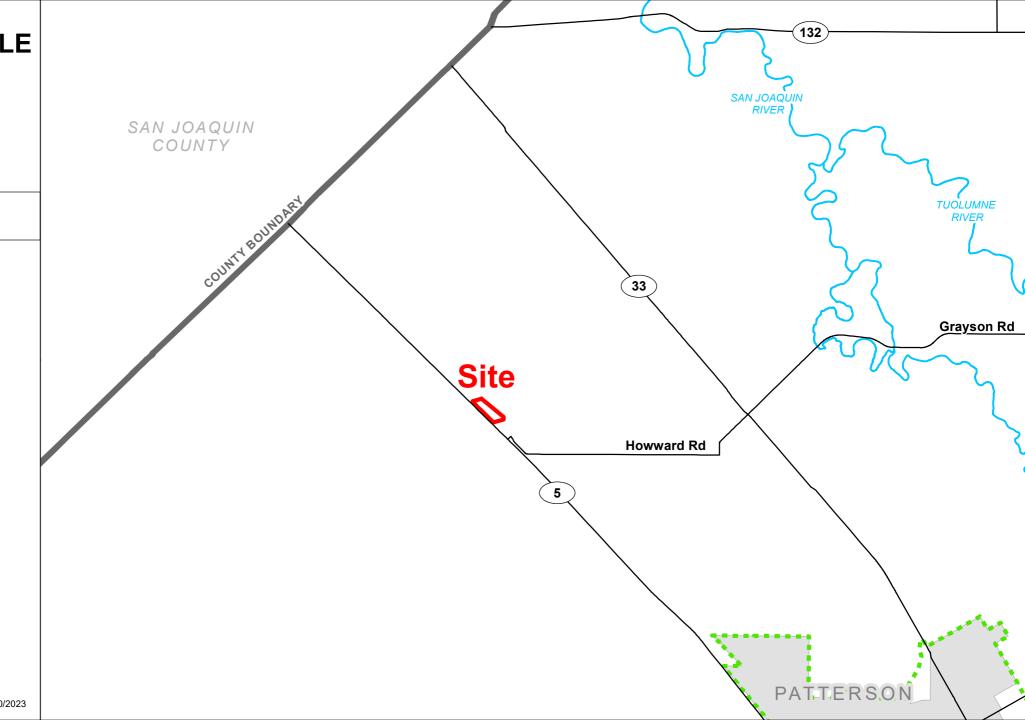


# WESTLEY TRIANGLE TRUCK STOP

GPA/REZ/PM PLN2022-0085



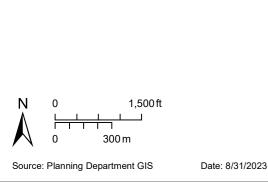

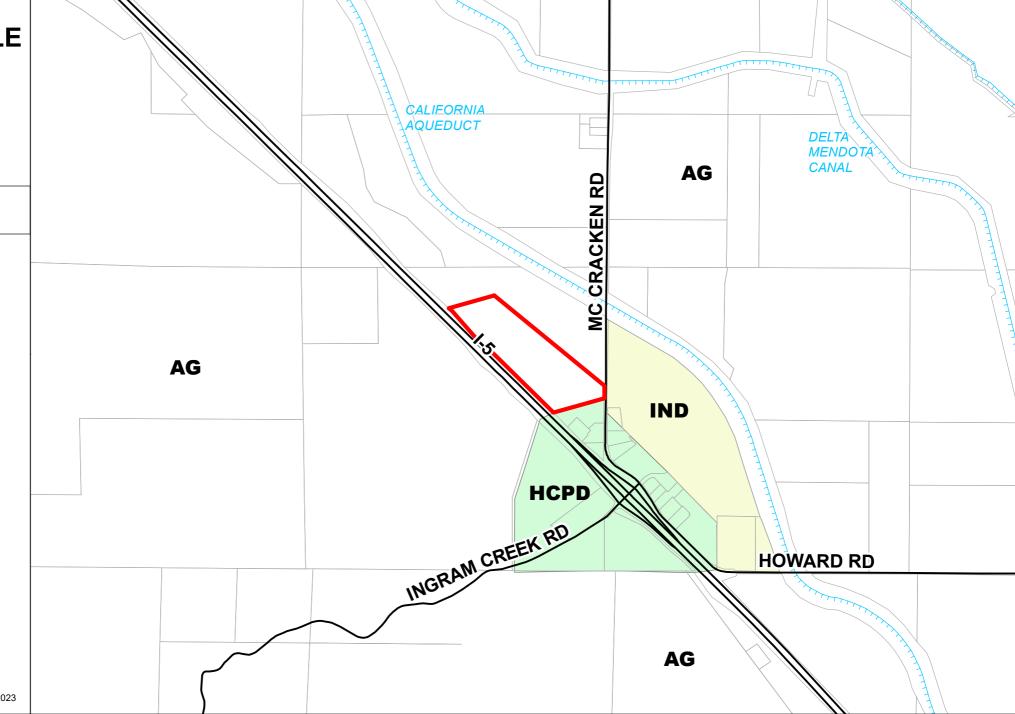

## **WESTLEY TRIANGLE TRUCK STOP**

**GPA/REZ/PM** PLN2022-0085

**ZONING MAP** 

## LEGEND

Project Site

Parcel

Road Canal

### **Zoning Designation**

Source: Planning Department GIS

General Agriculture 10 Acre


General Agriculture 40 Acre

General Agriculture 160 Acre

1,500 ft

Planned Development



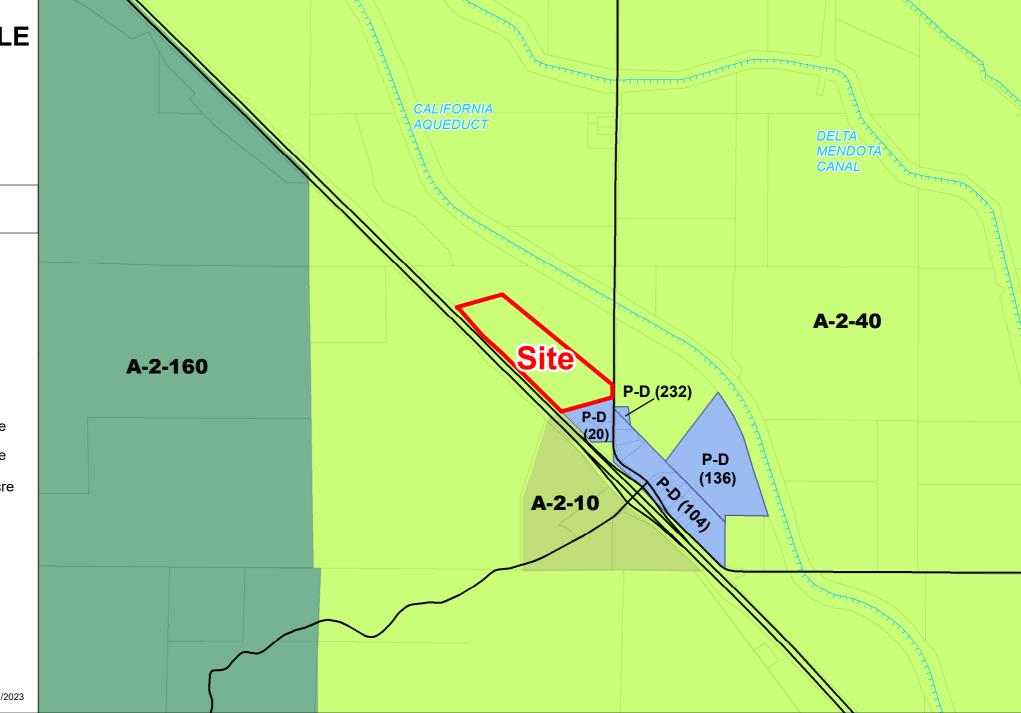

## **WESTLEY TRIANGLE TRUCK STOP**

**GPA/REZ/PM** PLN2022-0085

2023 AERIAL AREA MAP

LEGEND

Project Site

Road

Canal



1,500 ft

Source: Planning Department GIS

Date: 8/30/2023

# WESTLEY TRIANGLE TRUCK STOP

GPA/REZ/PM PLN2022-0085

2023 AERIAL SITE MAP

LEGEND

Project Site

—— Road

······ Canal





Source: Planning Department GIS

Date: 8/30/202

## WESTLEY TRIANGLE TRUCK STOP GPA/REZ/PM PLN2022-0085

## ACREAGE MAP

**Project Site** 

Parcel/Acres


1,500 ft

Road

Canal

Source: Planning Department GIS

LEGEND

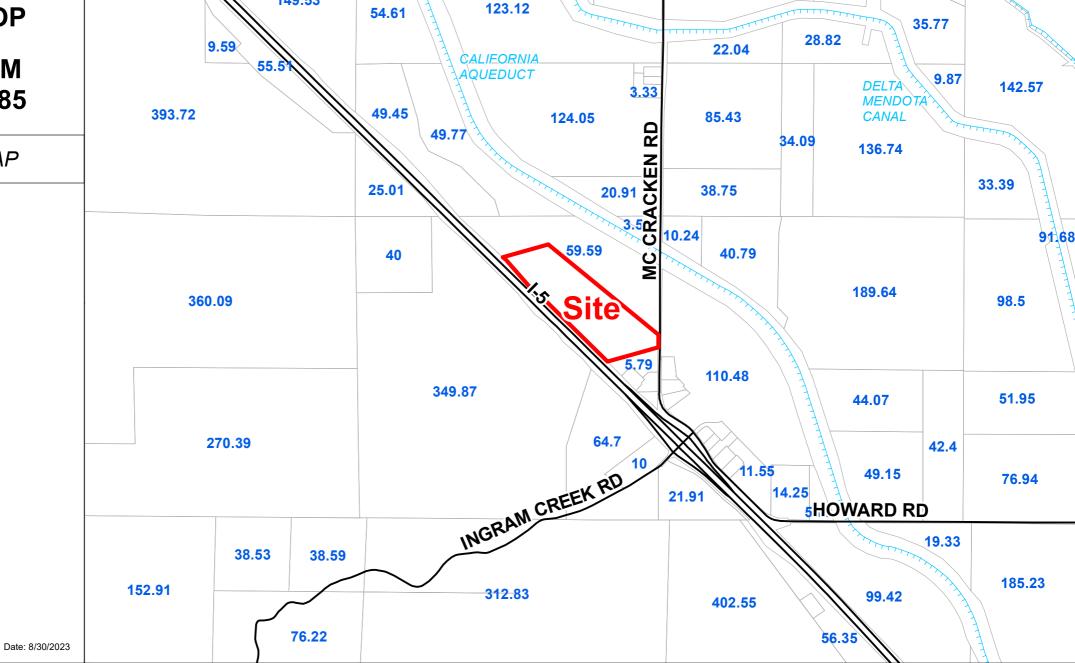

28.94

149.53

47.16

103.43

30.17

252.36

38.75

## BASIS OF BEARINGS

THE BASIS OF BEARINGS FOR THIS SURVEY IS BASED ON THE EAST SECTION LINE OF SECTION 35 BEARING NORTH 0° 22' 28" WEST, AS SHOWN ON PARCEL MAP NO. 54-31

## LEGAL DESCRIPTION

FOR RECORD FEBRUARY 9, 2006, IN BOOK 54, PAGE 31 OF PARCEL MAPS, STANISLAUS COUNTY RECORDS.

EXCEPT THEREFROM: ALL OIL, GAS, PETROLEUM AND OTHER HYDROCARBON SUBSTANCES AND MINERALS WITHIN OR UNDERLYING SAID LAND. AS RESERVED IN DEEDS OF RECORD.

# **TENTATIVE PARCEL MAP FOR:** WESTLEY 50-ACRE TRUCK STOP

## **SHEET INDEX**

## SHEET TITLE

C1.0 **COVER SHEET** 

TOPOGRAPHIC SURVEY & BOUNDARY PLAN C2.0

C3.0 CIVIL SITE PLAN

TENTATIVE PARCEL MAP C4.0

A101 TRUCK REPAIR BUILDING FLOOR PLAN

TRUCK REPAIR BUILDING EXT. ELEVATIONS PRELIMINARY LANDSCAPE PLAN OVERALL SITE

PRELIMINARY LANDSCAPE PLAN SERVICE AREA L1

PRELIMINARY LANDSCAPE PLAN L3 PRELIMINARY LANDSCAPE PLAN

PRELIMINARY LANDSCAPE PLAN

PRELIMINARY LANDSCAPE PLAN

## **BENCHMARK**

**ELEVATION: 247.80 (NAVD 88)** 

DESCRIPTION / LOCATION: M-31.5 (PID HS0835) NAVD88 LOCATED 28.4 MILES SE ALONG THE CA AQUDUCT FROM DELTA PUMP PLANT, IN THE TOP AND 1 FT EAST OF THE WEST END OF THE NORTH CONCRETE ABUTMENT OF McCRACKEN RD BRIDGE OVER THE AQUADUCT, 18 FT SOUTH OF THE CL NORTH LEVEE RD, AND 1 FT HIGHER THAN THE ROAD.

	EXISTING	PROPOSE
CENTERLINE		
SECTION LINE		
RIGHT OF WAY		
PROPERTY LINE		
EASEMENT		
CHAIN LINK FENCE		<b></b>
WOOD FENCE		<del></del>
WIRE FENCE MASONRY WALL	_xxx	_xx
RETAINING WALL		
DRAINAGE SWALE	N/A	
GRADE BREAK	<u> </u>	***
RIDGE	<del></del>	4 + 4 -
SAWCUT	N/A	
EDGE OF PAVEMENT	<del>//////////////</del>	<del>////////</del>
ASPHALT DIKE		
CURB, GUTTER, & SIDEWALK		
TRUNCATED DOMES	N/A	: 0 0 0 0 0 0 0 0 0 0 0 0 0 0 0 0 0 0 0
INLINE CURB RAMP		
CURB RAMP (TYPES VARY)		
WATER	EX W	X"W
SANITARY SEWER	EX SS	X"SS
STORM DRAIN	EX SD	XX"SD
FORCE MAIN	EX FM	XX
UTILITY STUB	EX SS	
GAS	<b>——=</b> •——	N/A
ELECTRICAL	ех є	N/A
TELECOMMUNICATION	<b>V</b> — — ех т — —	N/A
POWER POLE & OVERHEAD UTILITY	— ех он — —	– N/A
STREET LIGHT W/ ARM	5-3	
	4	1

POST TOP LIGHT

PARKING LOT LIGHT

**ELECTRICAL BOX** 

BENCHMARK

MONUMENT

**BOLLARD** 


CONTOURS

TREE

WHEEL STOP

MONUMENT SIGN

## SITE PLAN

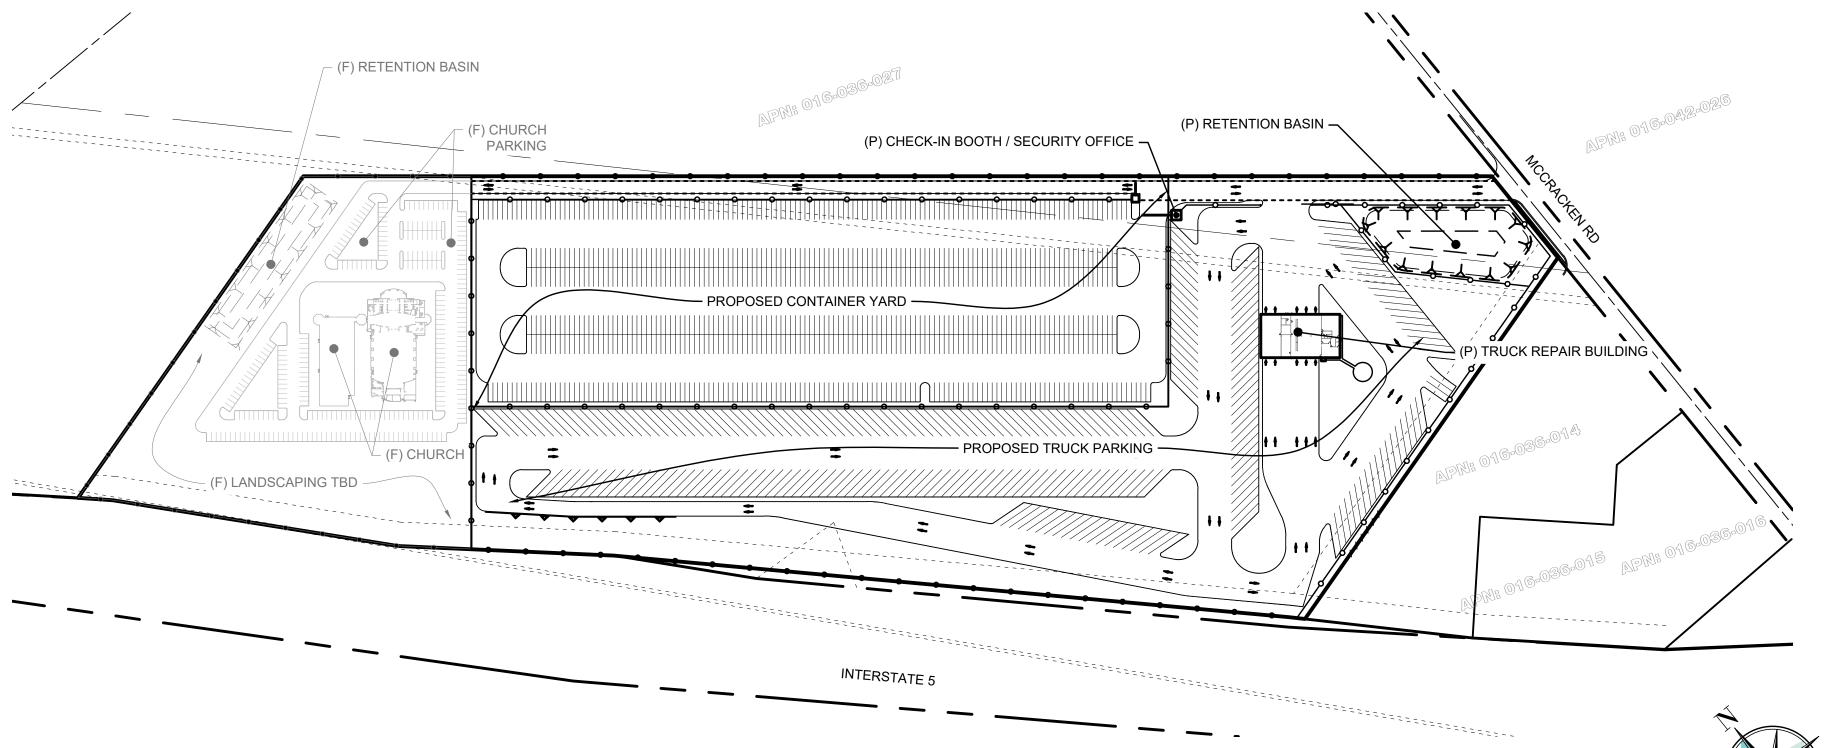

### **ABBREVIATION LIST** FIRE DEPARTMENT CONNECTION AGGREGATE BASE FG **FINISH GRADE** ASPHALT CONCRETE FIRE HYDRANT AMERICAN DISABILITIES ACT FLOW LINE BEGINNING OF CURVE PROJECT FLOWLINE LOWPOINT ELEV. BOUNDARY FIRE SERVICE BEGIN VERTICAL CURVE GROUND **GRADE BREAK BOTTOM WALL CURB AND GUTTER GREASE WASTE CATCH BASIN** HYDRAULIC GRADE LINE **HIGH POINT CURB INLET** CAST IN PLACE PIPE INV INVERT IRRIGATION CENTER LINE IRR LINEAL FEET OR LINEAR FEET **CLEAN OUT** CONCRETE **LOW POINT CURB RETURN** MAXIMUM MH MIN MAINTENANCE HOLE ROAD CROWN DOUBLE CHECK ASSEMBLY MINIMUM MUNICIPAL SEPARATE STORM SEWER DOUBLE CHECK DETECTOR ASSEMBLY MS4 SYSTEM DROP INLET **NOT TO SCALE** DIA / Ø DIAMETER **DUCTILE IRON PIPE** ON CENTER PROPOSED DRIVE OVER **PAVEMENT** DOMESTIC WATER POST INDICATOR VALVE DRIVEWAY PROPERTY LINE EACH **EASEMENT** POWER POLE POINT OF REVERSE CURVATURE END OF CURVE PT PUE PVC EXISTING GROUND PUBLIC UTILITY EASEMENT **ELEVATION** POLYVINYL CHLORIDE PIPE EDGE OF PAVEMENT ELECTRIC VEHICLE RCP

**RGRCP** 

ROW/RW

**EMERGENCY VEHICLE ACCESS** 

END OF VERTICAL CURVE

EACH WAY

**EXISTING** 

**FUTURE** 

CONC

CRN

DCA

DCDA

DWY

EASE

ELEV

EX, (EX), EXIST

<u>□ ₩</u>

(<del>C)</del>=<del>{\XX</del>

# **PROJECT TEAM**

REDUCED PRESSURE BACKFLOW

ASSEMBLY

STORM DRAIN

SECTION LINE

TOP OF CURB

**TEMPORARY** 

TRANSITION

TOP OF WALL

TYPICAL

TRAFFIC INDEX

WATER SERVICE

**UNLESS NOTED OTHERWISE** 

6" VERTICAL CURB 4" VERTICAL CURB (MODIFIED)

PLUS OR MINUS (NOT EXACT)

SLOPE

STATION

STANDARD

SIDEWALK

RPA

RPDA

STA

STD

TEMP

REINFORCED CONCRETE PIPE

RUBBER GASKET REINFORCED

CONCRETE PIPE

**RIGHT-OF-WAY** 

RMK Design, Inc. ASSEMBLY REDUCED PRESSURE DETECTOR 5 East Main St (Suite B) Turlock, CA 95380 RAIN WATER LEADER (209) 634-4832 RETAINING BOTTOM OF WALL Daniel Barnes RETAINING TOP OF WALL Dbarnes@RMKdesign.net

**CIVIL ENGINEER** STREET NAME SIGN Barnes Engineering, Inc. 4634 Whisper Pl Turlock, CA 95382 **(**) (209) 765-4222 SANITARY SEWER Daniel Barnes THRUST BLOCK

TOP OF CURB FLUSH **SURVEYOR** Van Ryn Engineering, Inc. 16766 Bernardo Center Dr., Suite 213 San Diego, CA 92128

**(**858) 521-8100 John Van Ryn john@vanryneng.com

Dbarnes@BarnesEng.com

### **DEVELOPER** PROJECT MANAGER RAJA CHANDI GROUP, INC. P.O. BOX 3820 Turlock, CA 95381

(209) 634-4832 Prabhjot Singh rj@rajachandi.net


TRIANGLE PROPERTY INC. P.O. BOX 3820 Turlock, CA 95381

ARCHITECT AGC Design Concept 28524 Constellation RD Valencia, CA 91355 (213) 448-3911 Alex Cuevas acuevas@agcdc.com

LANDSCAPE ARCHITECT P.O. Box 2275 Oakdale, CA 95361 **(**209) 380-7376 Sam Harned

sam@HarnedLA.com

## VICINITY MAP (CITY OF WESTLEY, STANISLAUS COUNTY, STATE OF CALIFORNIA)

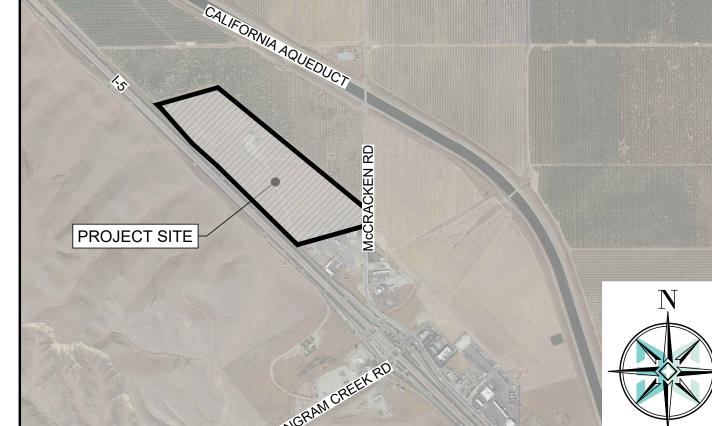

## PROJECT INFORMATION

### **EXISTING CONDITIONS**

SITE ADDRESS 7003 SOUTH MCCRACKEN RD CITY/STATE/ZIP: PATTERSON, CA 95363

**EXISTING PARCELS:** ±50.05 ACRES

**EXISTING ACREAGE:** FEMA FLOOD ZONE: ZONE X (AREA OF MINIMAL FLOOD HAZARD)

AG-40 AGRICULTURE **EXISTING ZONING:** VACANT CURRENT USE:

### PROPOSED PROJECT

PROPOSED PARCELS: PARCEL 1:

±16.00 ACRES PD "CONTAINER YARD" ±23.97 ACRES PD "TRUCK PARKING / SERVICE STATION" PARCEL 2: PARCEL 3: ±10.08 ACRES PD "CHURCH"

TOTAL ACREAGE: ±50.05 ACRES

COMMERCIAL TRUCK PARKING / SERVICE STATION. CONTAINER YARD. PROPOSED USE: CHURCH FUTURE USE:

SEWER: ONSITE LEACHFIELD (OWNER) WATER: **EXISTING ONSITE WELL (OWNER)** ONSITE RETENTION BASIN (OWNER) STORM: PG&E (IF NEEDED)

ELECTRIC: PG&E TBD TELEPHONE: CABLE TV:

### **SURVEYOR'S NOTES:**

TOPOGRAPHY SHOWN IS BASED ON A TOPOGRAPHIC SURVEY PERFORMED UNDER VAN RYN 2. IMPROVEMENTS SHOWN ON THIS VESTING TENTATIVE PARCEL MAP ARE SUBJECT TO REVISION IN

FINAL DESIGN.


THIS MAP IS FOR PLANNING PURPOSES ONLY. THE BEARINGS & DISTANCES SHOWN ON THE

PROJECT BOUNDARY IS PLOTTED PER A FIELD SURVEY & RECORD MAPS. A RECORD OF SURVEY WILL BE PERFORMED TO RE-ESTABLISH THE TRUE PROPERTY CORNER, PRIOR TO THE FINAL PARCEL MAP.

> NO./9342/ ★\ EXP. 03/31/23





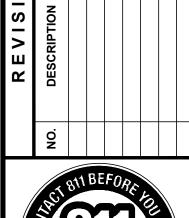





1.800.227.2600

JOB #: RMK-0027 DATE: 12/15/2023 **SCALE: AS SHOWN** DRAWN BY: DB

**CHECKED BY: DB** NUMBER

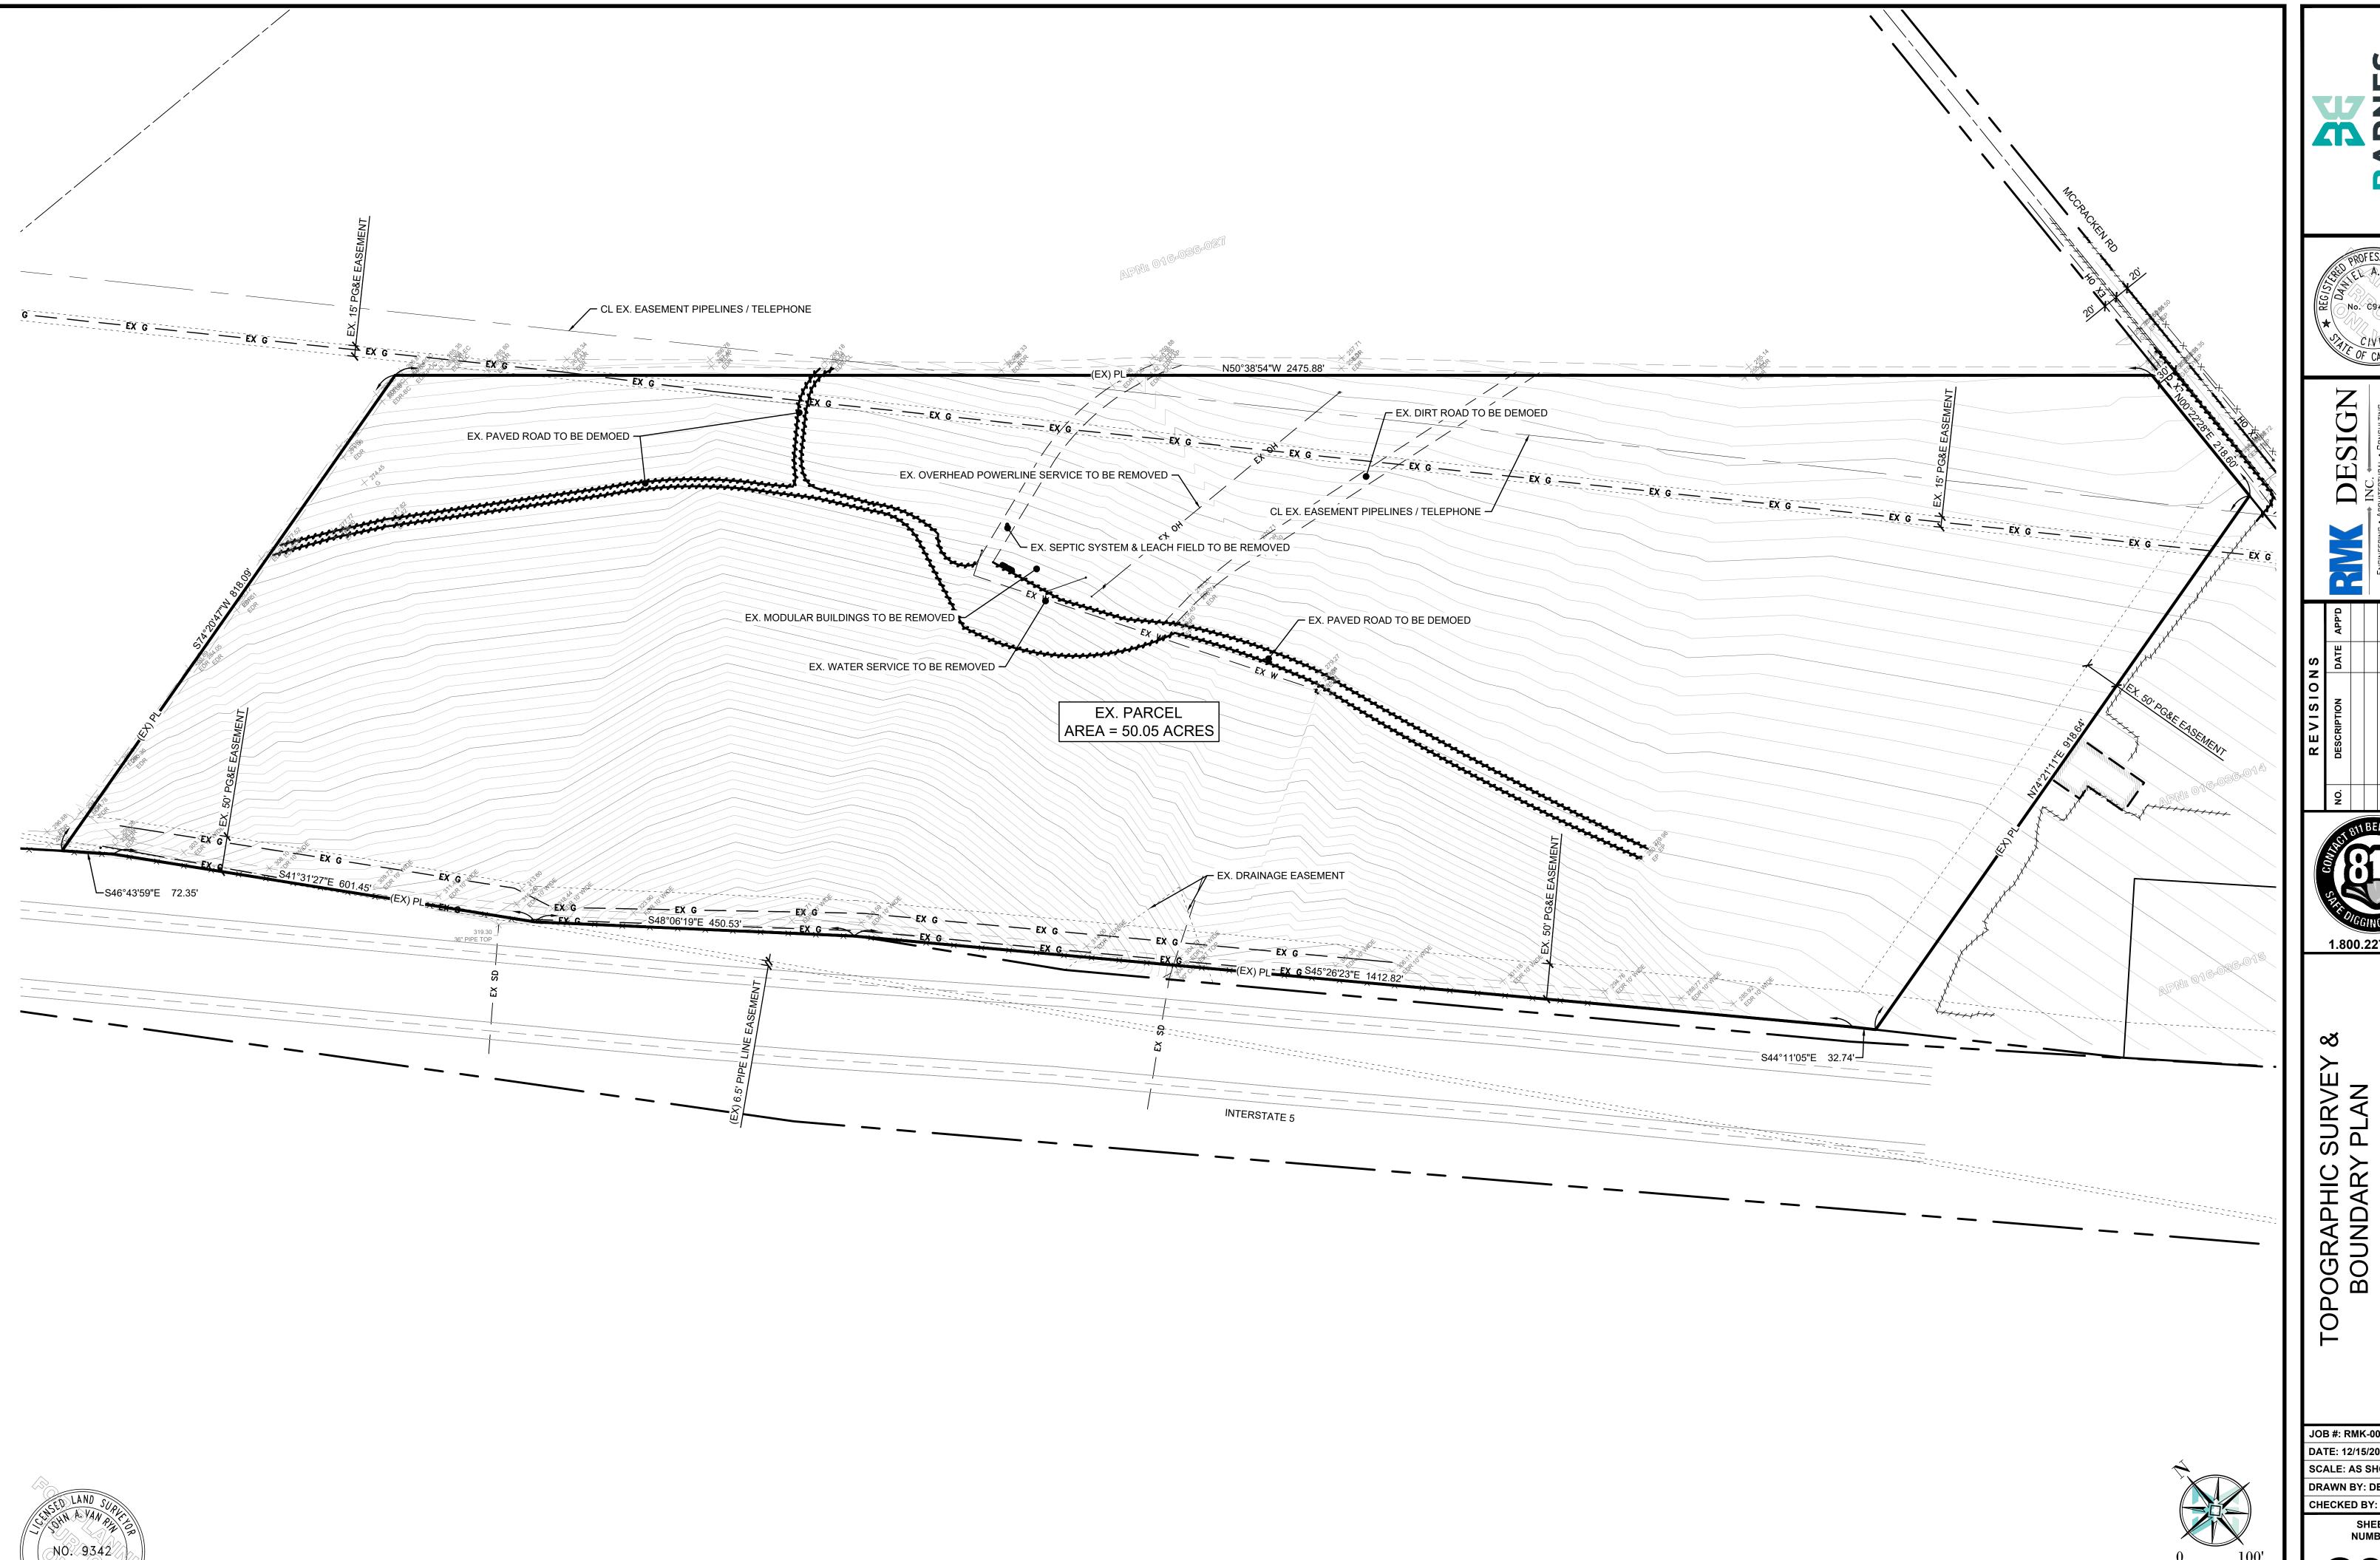

**★** EXP 03/31/23 ★

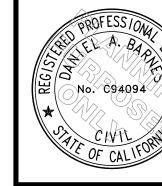



1.800.227.2600


STOP


WESTLEY 50-ACRE TRUCK

JOB #: RMK-0027 DATE: 12/15/2023 SCALE: AS SHOWN DRAWN BY: DB CHECKED BY: DB

SHEET NUMBER


OF L5

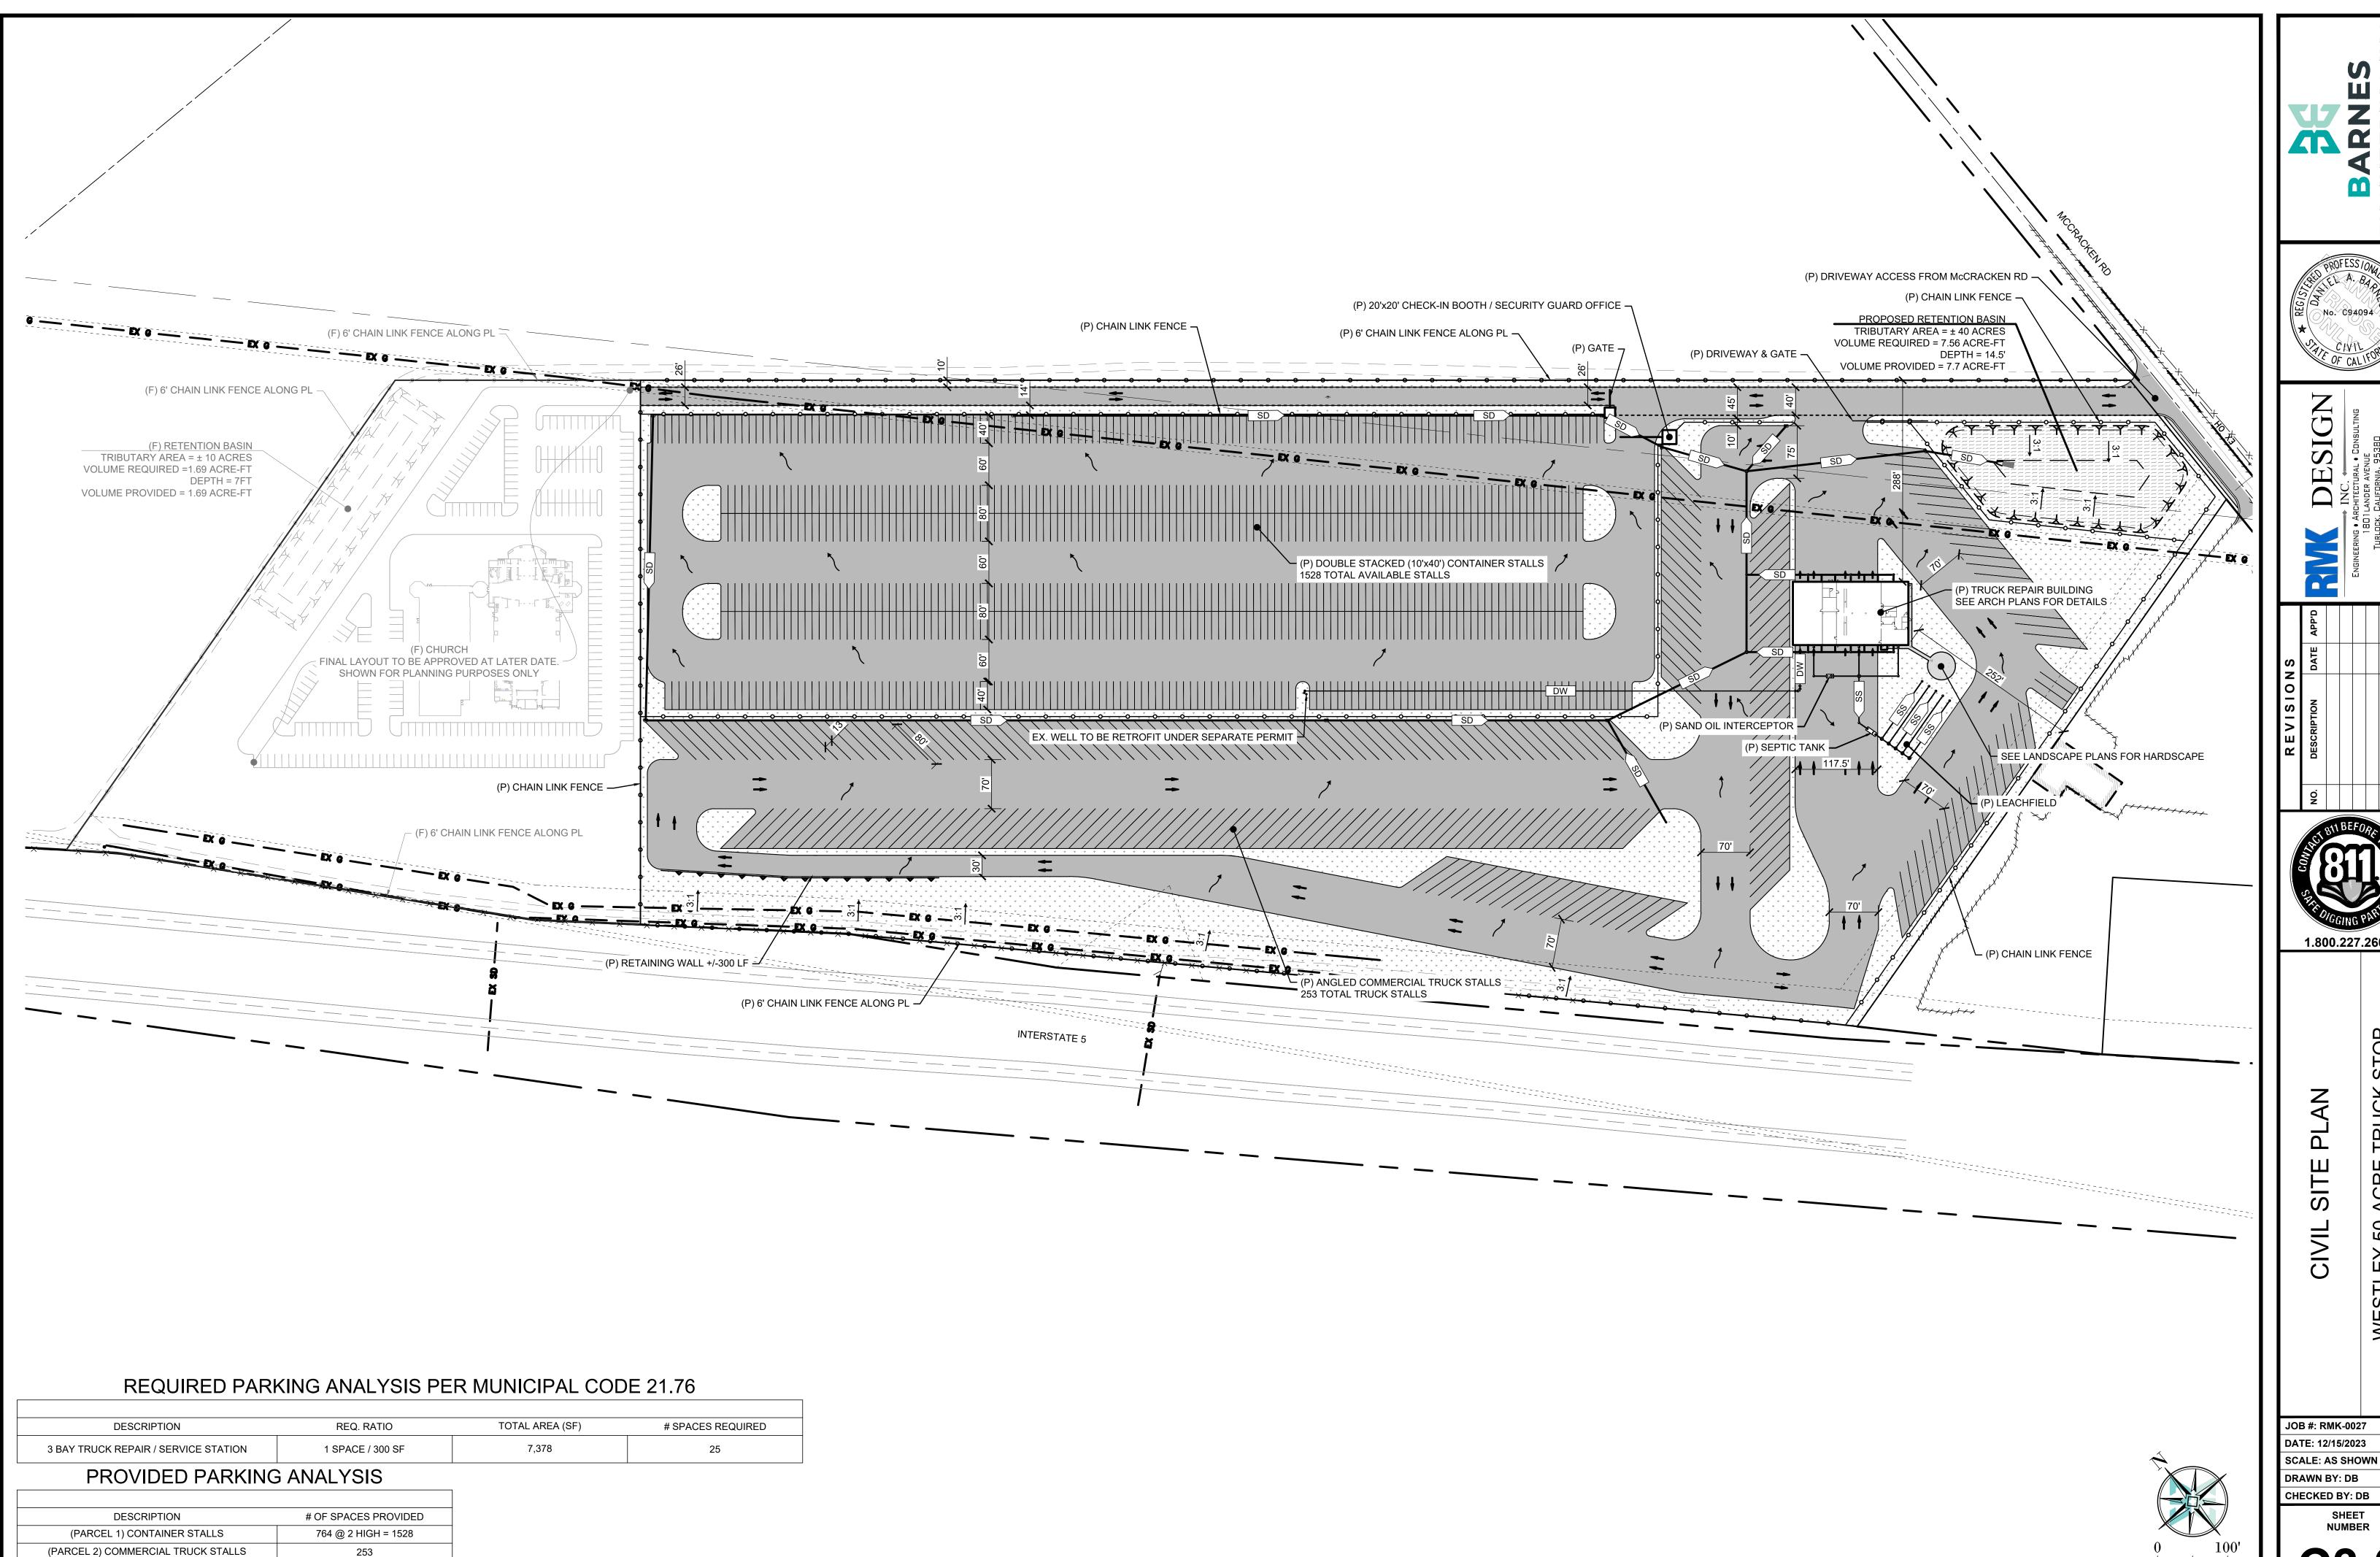


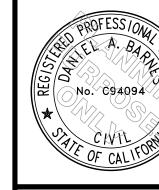



**CHECKED BY: DB** 

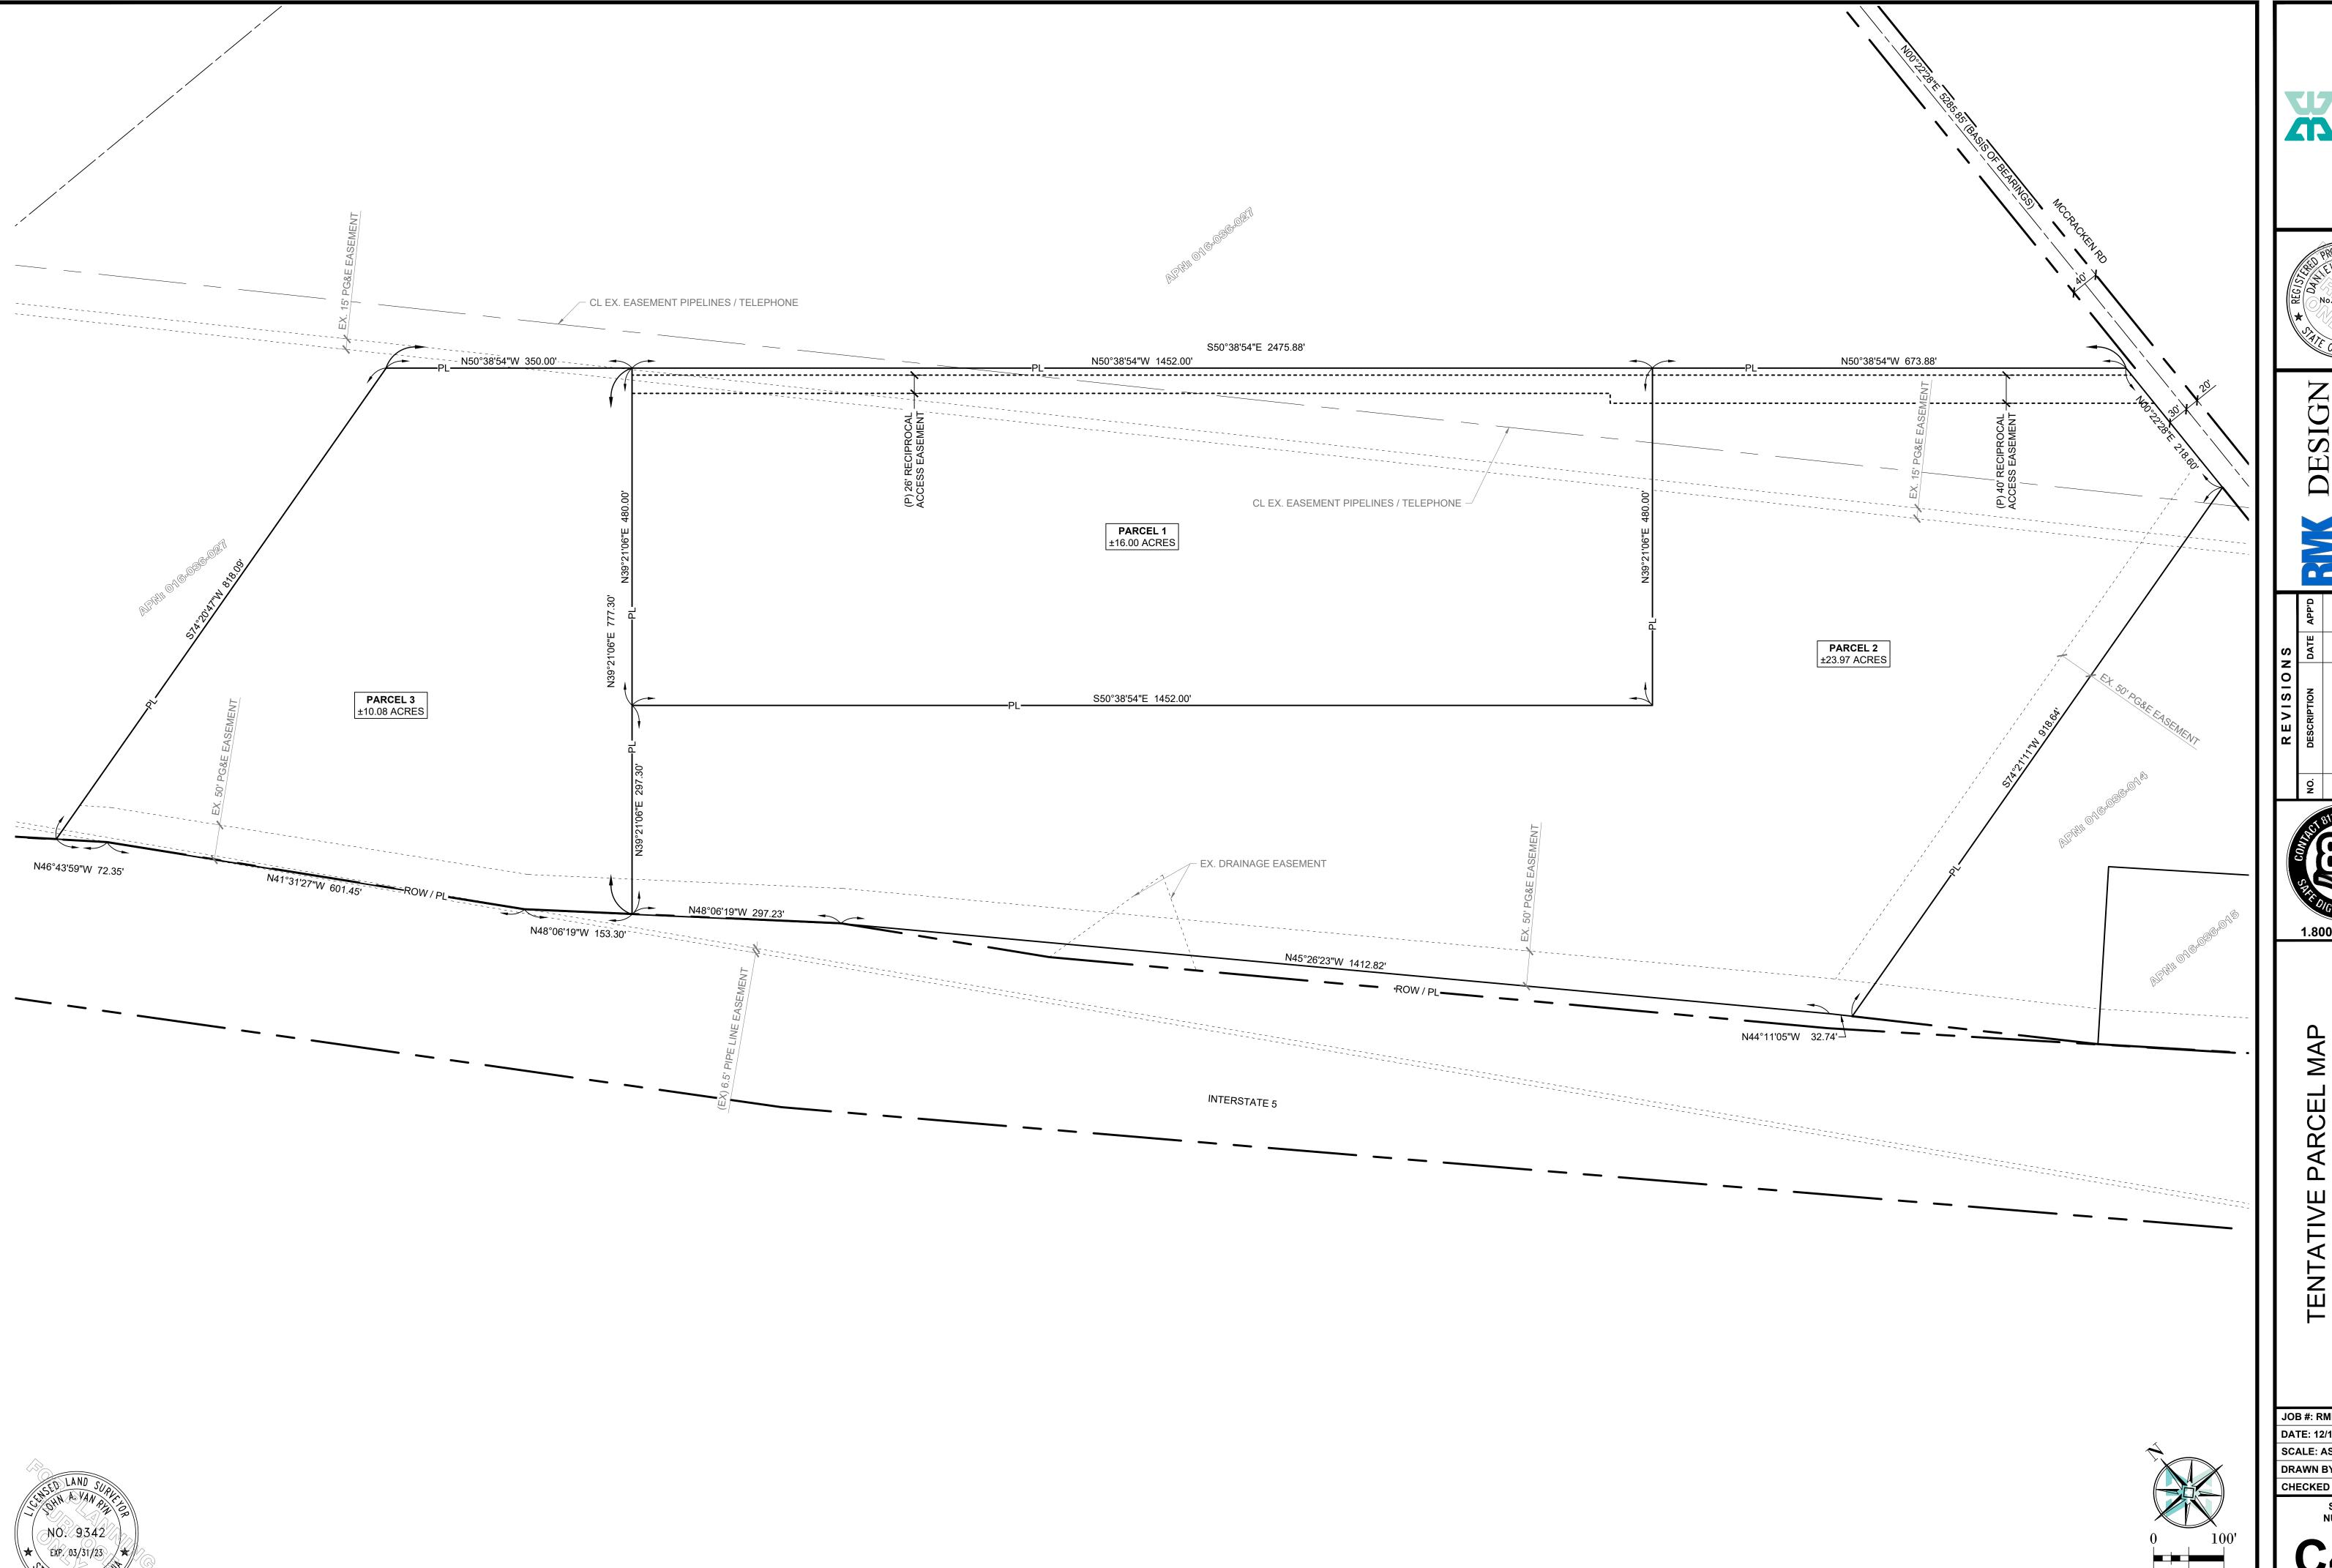

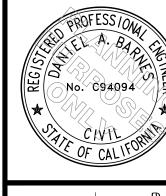




TRUCK STOP

50-ACRE

JOB #: RMK-0027 DATE: 12/15/2023 SCALE: AS SHOWN

DRAWN BY: DB CHECKED BY: DB

SHEET NUMBER

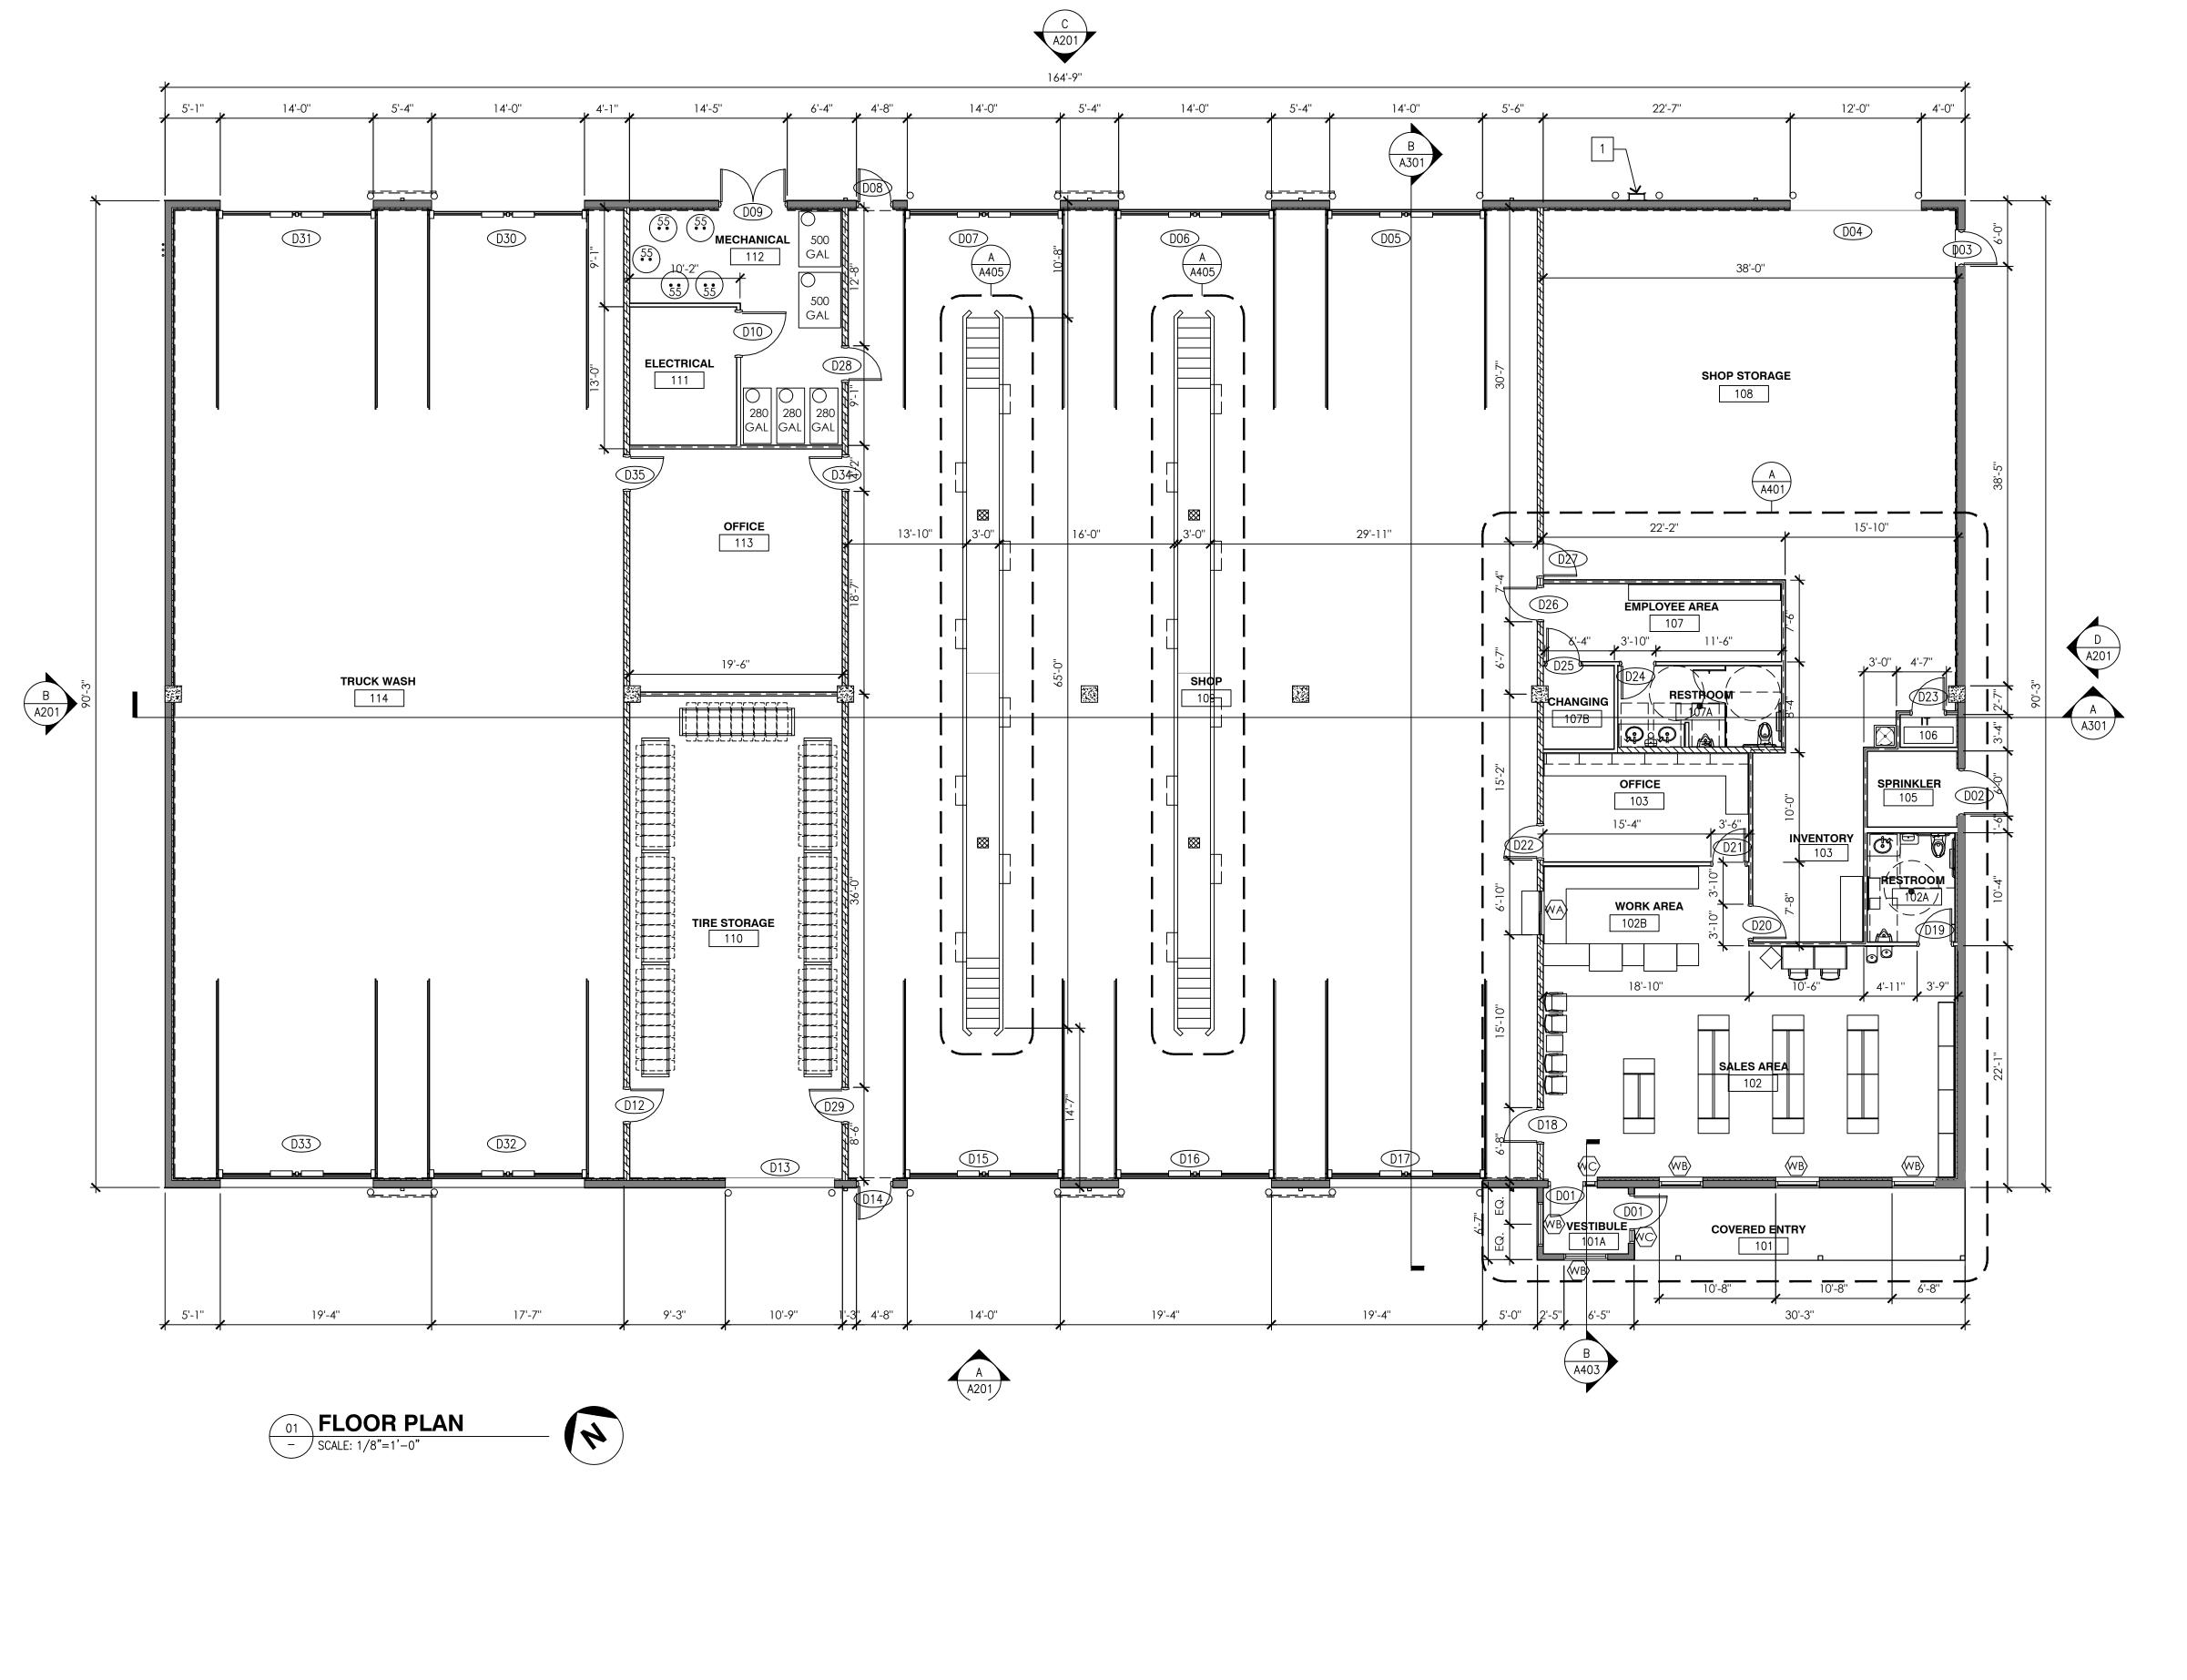

### **GENERAL NOTES**

- A. FOR ALL STRUCTURAL ELEMENTS AND INFORMATION, SEE STRUCTURAL DRAWINGS PREPARED BY SELECT STRUCTURAL ENGINEERING.
- B. FOR ALL MECHANICAL (HVAC), PLUMBING, ELECTRICAL & FIRE ALARM SYSTEM ELEMENTS AND INFORMATION, SEE DRAWINGS PREPARED BY WHS ENGINEERS.
- C. SEE ELECTRICAL DRAWINGS AND LIFE SAFETY PLAN FOR EXIT SIGN LOCATIONS AND PANIC HARDWARE LOCATIONS.
- D. SEE SHEET A002 FOR COMPLETE ACCESSIBILITY DIMENSION AND INFORMATION.
- GEORGIA STATE MINIMUM FIRE PREVENTION CODE: SECTION 3409 OF INDOOR STORAGE ARRANGEMENT, AS FOLLOWS: 3409.1 PILE DIMENSIONS. WHERE TIRES ARE STORED ON TREAD, THE DIMENSION OF THE PILE IN THE DIRECTION OF THE WHEEL HOLE SHALL NOT BE MORE THAN 50 FEET (15 240 MM). TIRES STORED ADJACENT TO OR ALONG ONE WALL SHALL NOT EXTEND

E. TIRE RACK STORAGE MUST COMPLY WITH

NOTE: TIRE RACK SYSTEM TO BE DESIGNED BY THE TIRE RACK SUPPLIER AND COORDINATED WITH THE OWNER.

MORE THAN 25 FEET (7620 MM) FROM WALL. OTHER PILES SHALL NOT BE MORE THAN 50

FEET (15 240 MM) IN WIDTH.

### SYMBOLS

D?? DOOR TAG, SEE SCHEDULE ON SHEET

WINDOW TAG, SEE SCHEDULE ON SHEET A601

## WALL LEGEND

- 8" CMU BLOCK WALL (SEE STRUCTURAL DRAWING FOR REINFORCING) WITH BRICK VENEER AND STUCCO FINISH TO EXTERIOR FACE (SEE EXTERIOR ELEVATIONS FOR LOCATION). ON INTERIOR FACE 5/8" GYPSUM WALL BOARD OVER 1-5/8" METAL STUDS PLACED AT 16" OC OVER 1-1/2" RIGID INSULATION.
- 8" CMU BLOCK WALL (SEE STRUCTURAL DRAWING FOR REINFORCING) WITH 5/8" GYPSUM WALL BOARD OVER 1-5/8" METAL STUDS PLACED AT 16" TO EXTERIOR FACE. ON INTERIOR FACE 5/8" GYPSUM WALL BOARD OVER 1-5/8" METAL STUDS PLACED AT 16" OC OVER 1-1/2" RIGID INSULATION.
- 8" CMU BLOCK WALL (SEE STRUCTURAL DRAWING FOR REINFORCING) WITH BRICK VENEER AND STUCCO FINISH TO EXTERIOR FACE (SEE EXTERIOR ELEVATIONS FOR LOCATION). ON INTERIOR FACE 5/8" FIRE-RETARDANT PLYWOOD OVER 1-1/2" RIGID INSULATION.
- STRUCTURAL COLUMN (SEE STRUCTURAL DRAWINGS FOR TYPE).
- 6" METAL STUD WALL (PLUMBING) WITH 5/8" GYPSUM WALL BOARD ON EACH SIDE. STUDS PLACED AT 16" OC.
- 3-5/8" METAL STUD WALL (TYPICAL) WITH 5/8" GYPSUM WALL BOARD ON EACH SIDE. STUDS PLACED AT 16" OC.
- INDICATES WALL TO BE RAN TO UNDERSIDE OF STRUCTURE ABOVE. INSULATE WALL FLOOR TO STRUCTURE ABOVE. FULL BATT OR 3-1/2" MINIMUM IF INSULATION IS LESS THAN FULL DEPTH PROVIDE ANCHORAGE.

NOTE: WALLS NOT EXTENDED TO STRUCTURE TO BE LATERALLY BRACED AT 12'-0" OC MAX, SEE DETAIL A/A501.

### # KEY NOTES

1 FIXED ROOF ACCESS LADDER W/ CAGE AND WALK-THRU BY BC SITE SERVICE OR EQUAL.

DESI

BUILDING . MCCRACKEN / -EY, CA :K REPAIR BU

><u>~</u>

ACILITY

STOP

TRUCK


7003 S. M WESTLEY TRUCK


consultant job# master release date

project exe date drawn by Filename AGC

Facility/Project

sheet name A101

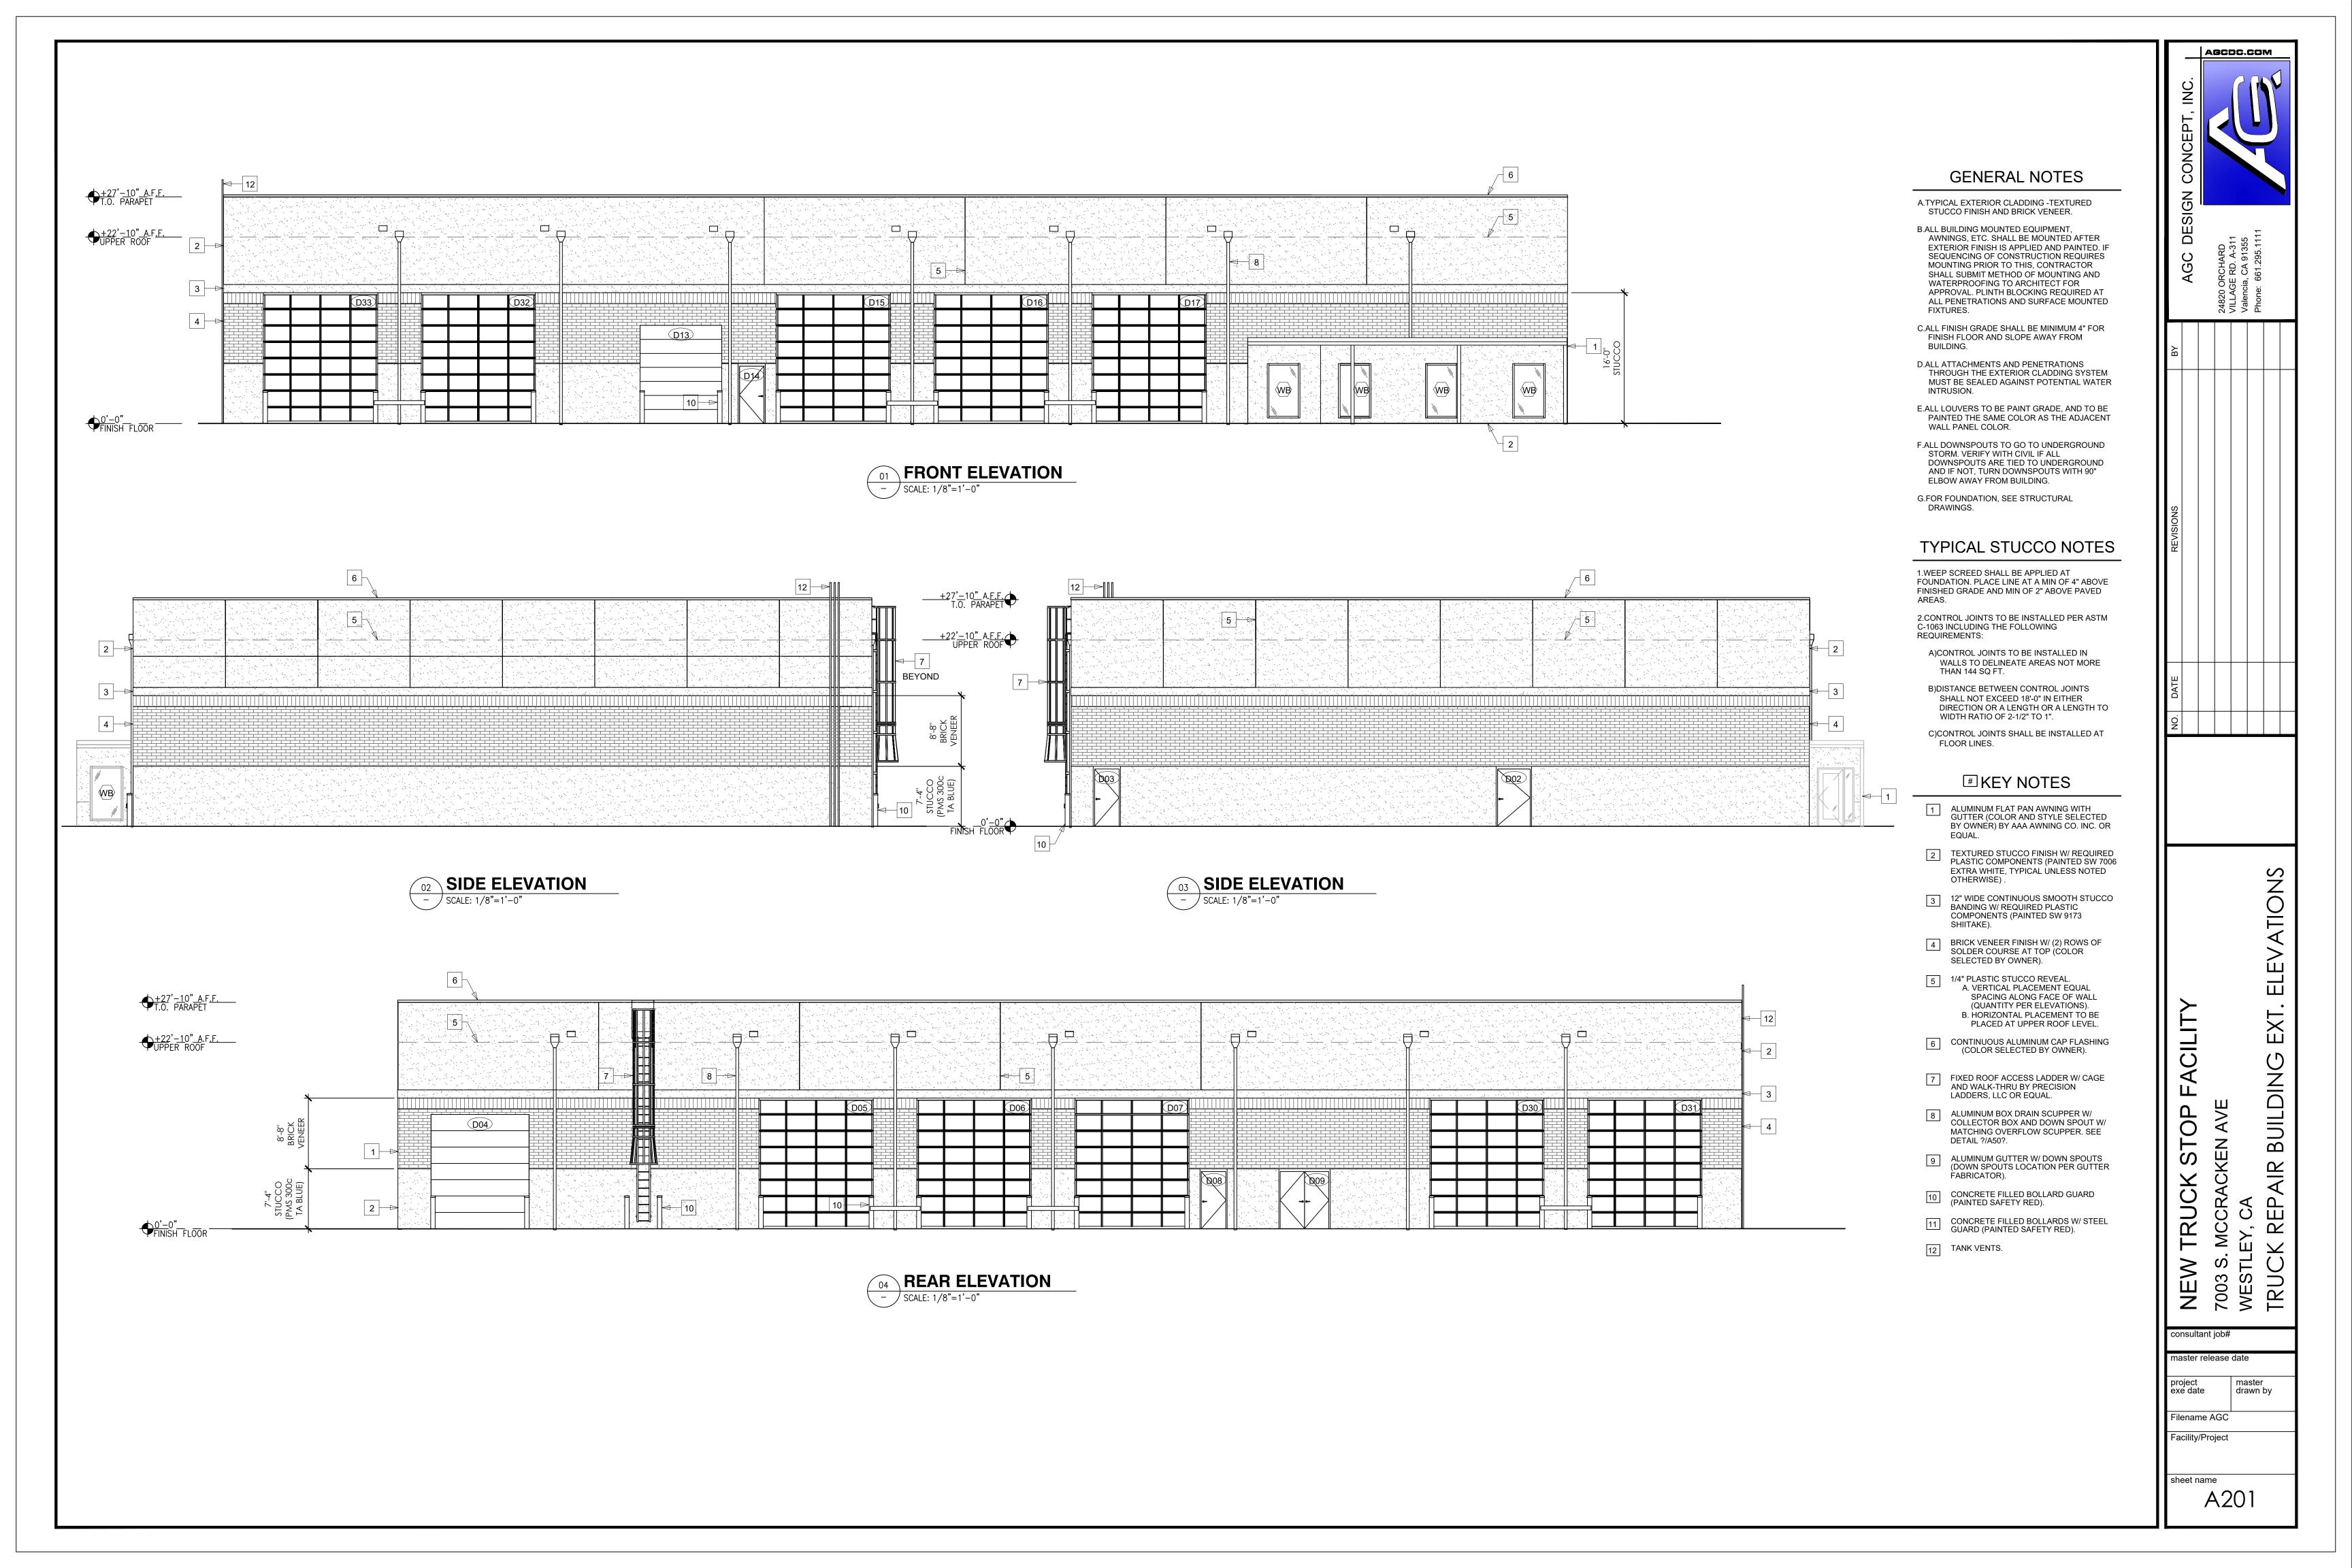

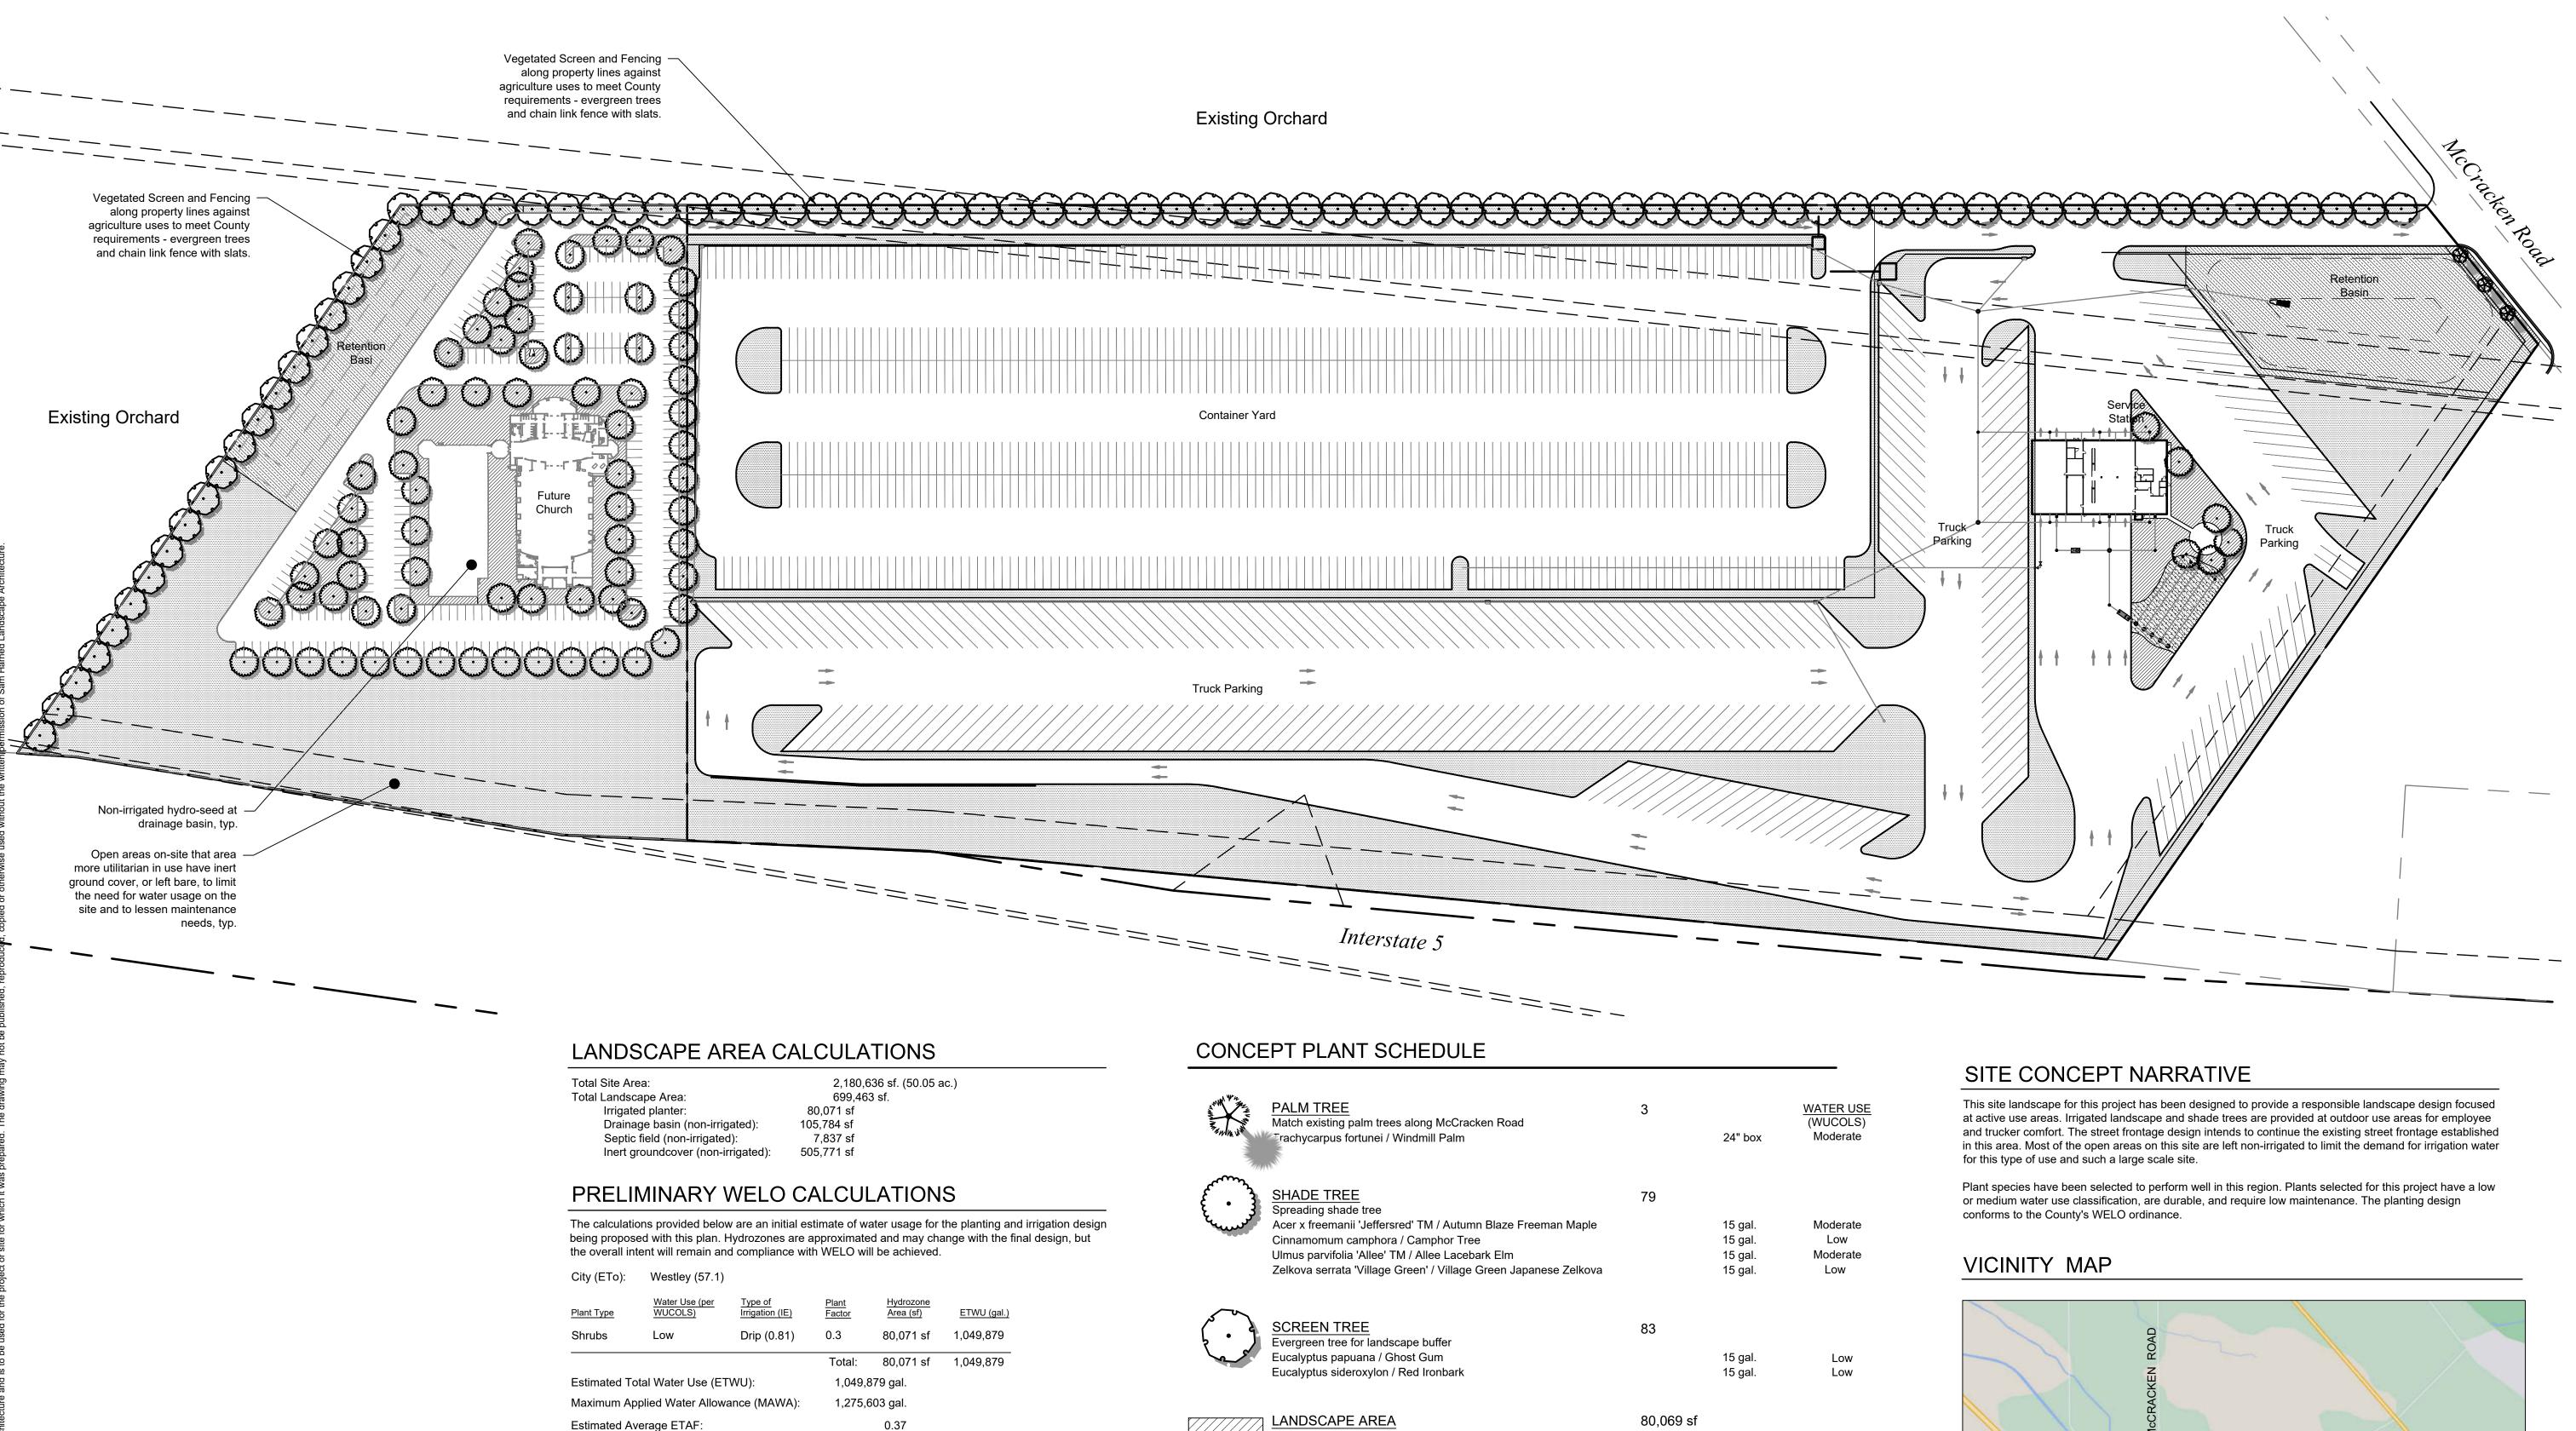

Irrigated landscape areas around building and guest use areas. Some

of these areas may include pedestrian paving and pedestrian use spaces which will be defined with the future design phases specific to

Landscape areas will include a mix of shrubs, grasses and ground

maitnenance demands. The list provided is a sampling of the types of species that will be selected as part of the final design, with County

5,211

1,702

5,212

3,337

3,336

3,336

5 gal.

1 gal.

5 gal.

1 gal.

5 gal.

5 gal.

48" oc Low

84" oc Low

48" oc Low

60" oc Low

84" oc Low

60" oc Very Low

60" oc Moderate

cover of speceis that will be primarily low water using and low

Baccharis pilularis 'Twin Peaks#2' / Twin Peaks #2 Coyote Brush

Cotoneaster dammeri 'Lowfast' / Lowfast Bearberry Cotoneaster

Ligustrum japonicum 'Texanum' / Texanum Privet

Muhlenbergia capillaris / Pink Muhly Grass

Olea europaea 'Montra' / Little Ollie® Olive


Rhaphiolepis indica / Indian Hawthorn


Callistemon viminalis 'Little John' / Little John Weeping Bottlebrush

Myoporum parvifolium 'Putah Creek' / Putah Creek Trailing Myoporum 1,702


each development, with County approval.

approval.

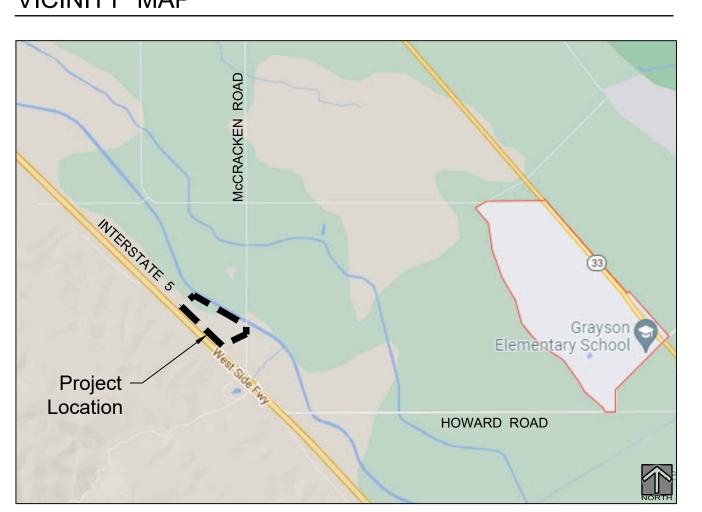

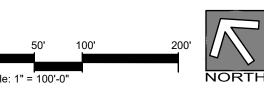



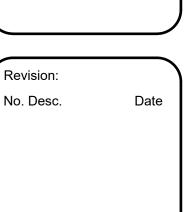

Sam Harned Landscape Architecture

PO Box 2275 Oakdale, CA 95361 209-380-7376 www.harnedla.com

Prepared for:

PO Box 3820 Turlock, CA 95381

Project:

0-ACRE TOP

S.

WESTLEY TRUC

Triangle Property Inc.

Date:	20 Dec 2023
Drawn:	RSH
Checked:	RSH
Project No.:	22-032
Scale:	1" = 100'-0"

Preliminary
Landscape
Plan
Overall Site

L0

Maximum Allowable ETAF:

INERT GROUND COVER / BARE GROUND

as gravel or crushed almond shells.

Non-irrigated areas for ease of maintenance and limiting need for

water use. Either bare ground or some type of inert ground cover such

DRAINAGE BASIN

Non-irrigated hyrdro-seed


0.45

105,784 sf

7,837 sf

507,719 sf

None

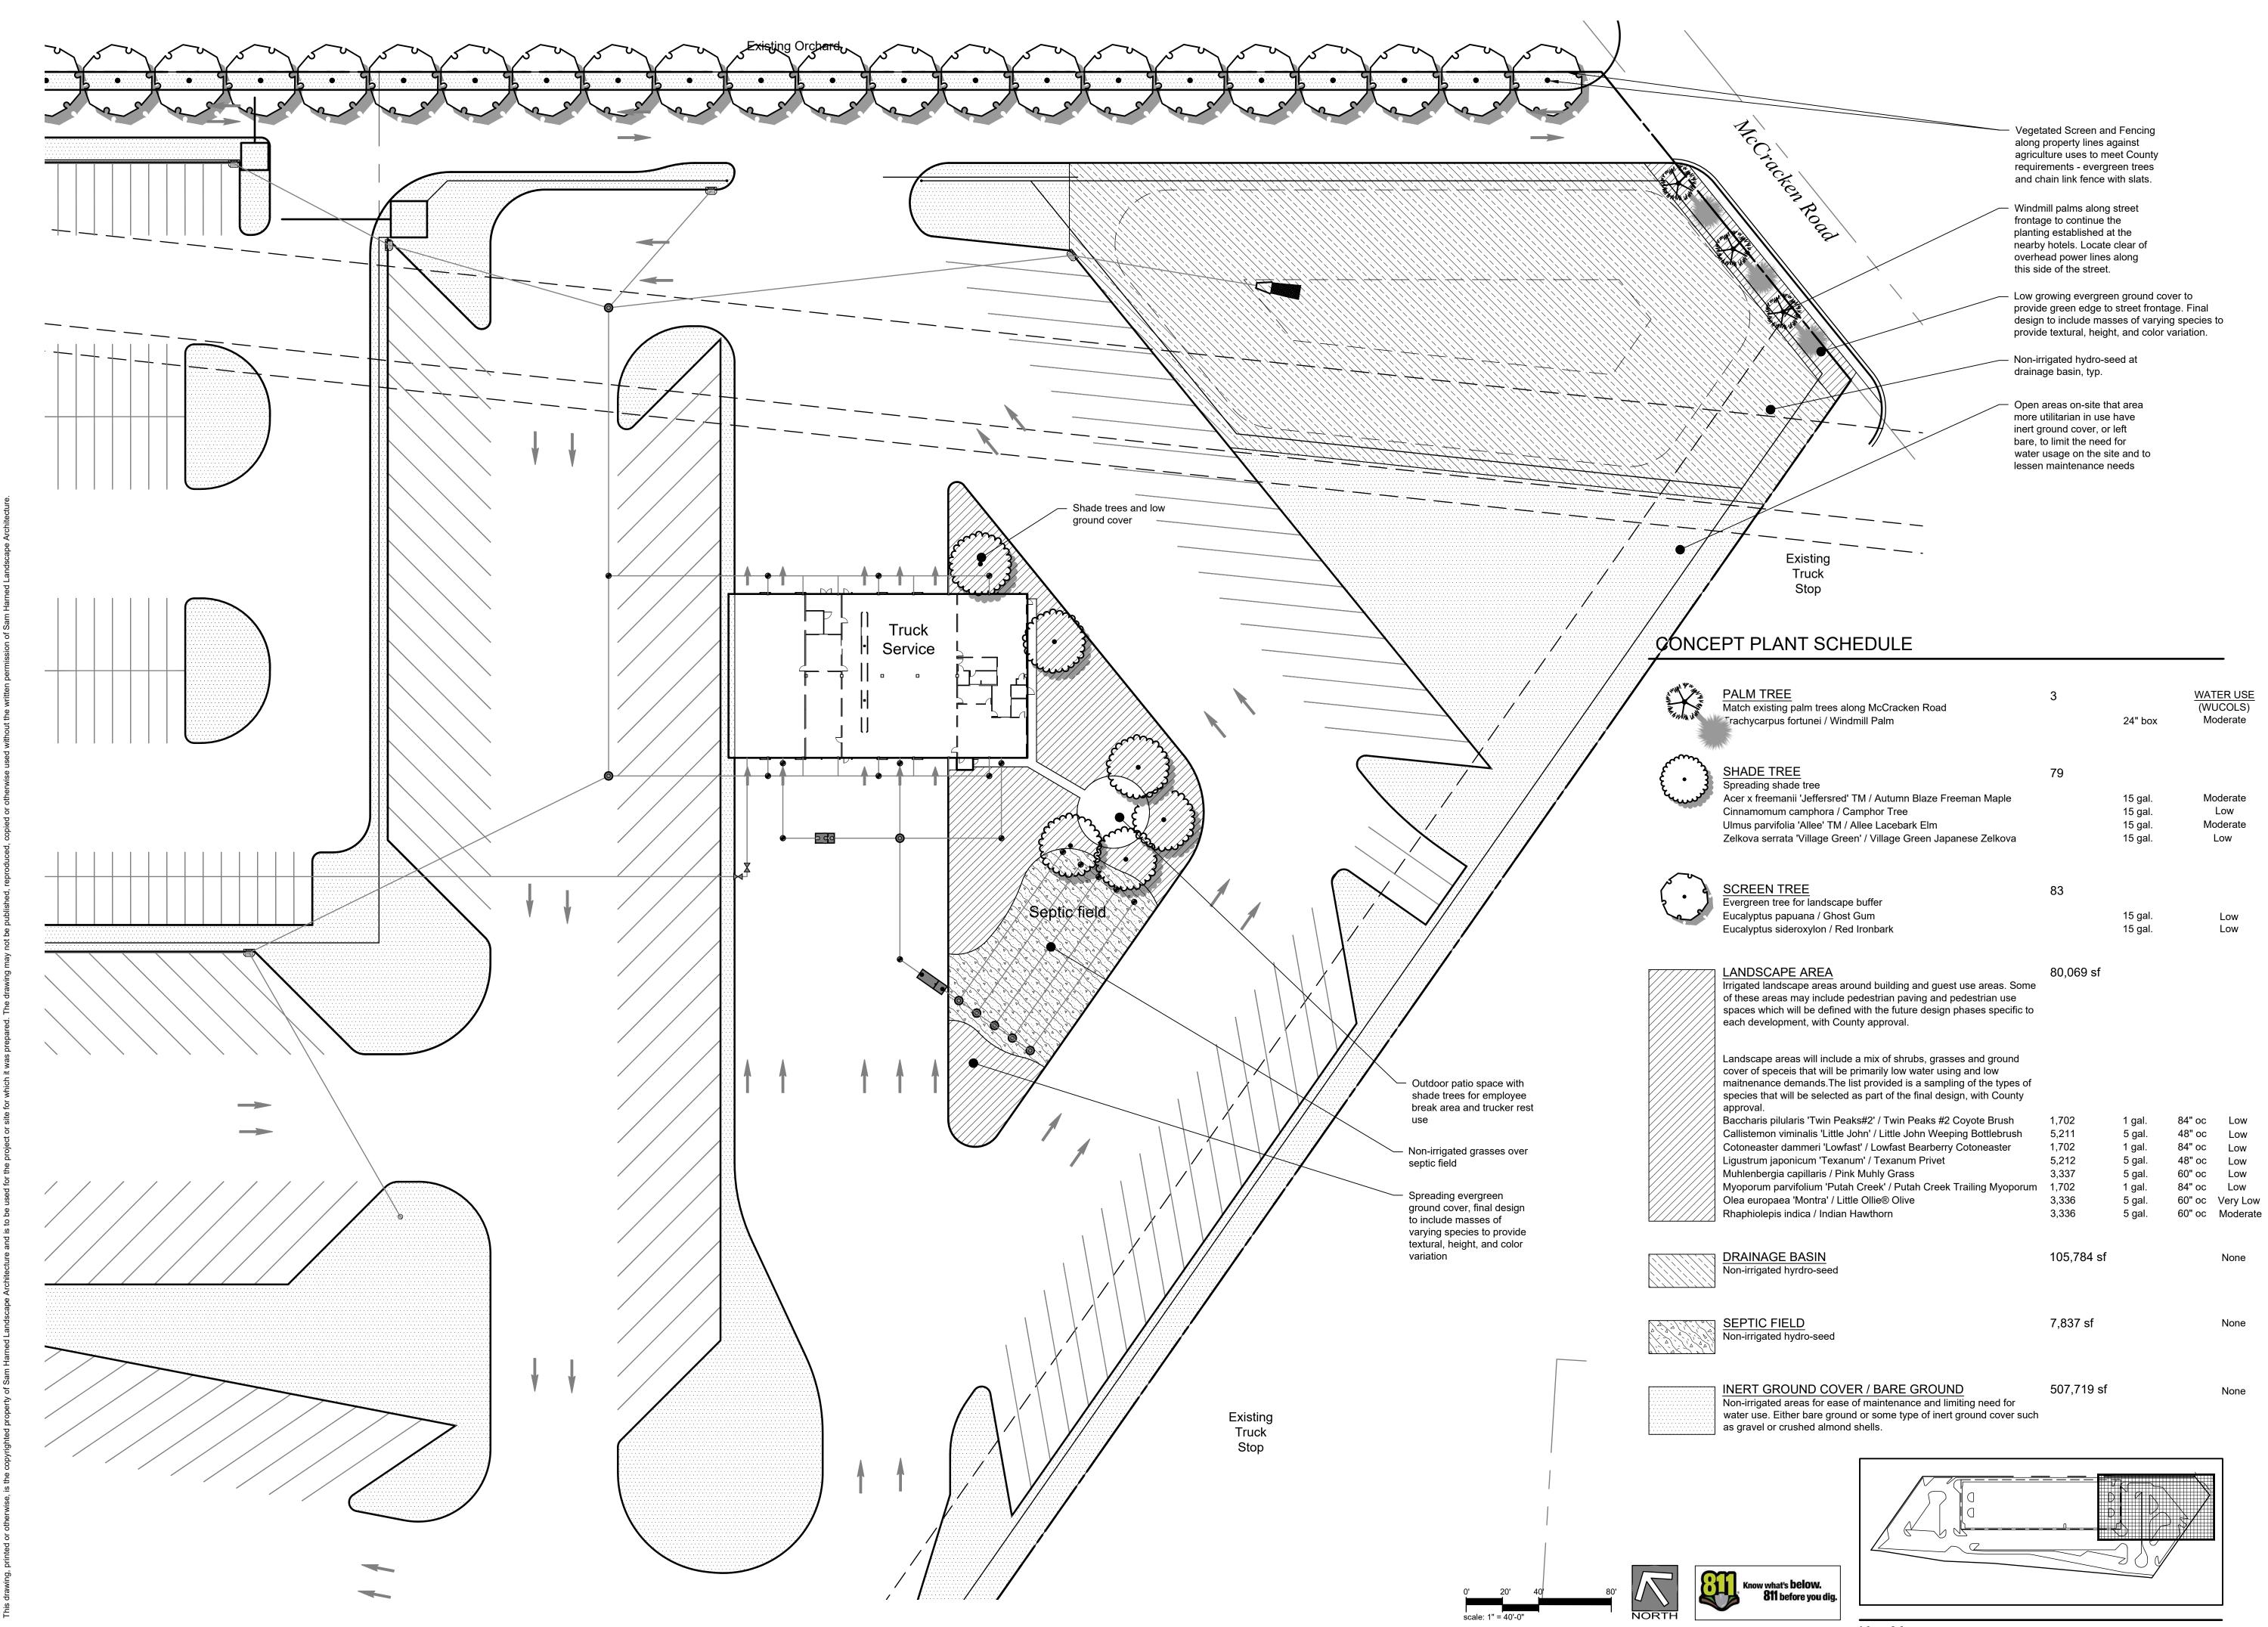



Sam Harned Landscape Architecture PO Box 2275 Oakdale, CA 95361 209-380-7376 www.harnedla.com



Prepared for:

Triangle Property Inc.
PO Box 3820

Turlock, CA 95381

Project:

WESTLEY 50-ACRE TRUCK STOP

Revision:
No. Desc.

Date

 Date:
 20 Dec 2023

 Drawn:
 RSH


 Checked:
 RSH


 Project No.:
 22-032

 Scale:
 1" = 40'-0"

Preliminary
Landscape
Plan
Service Area


Key Map

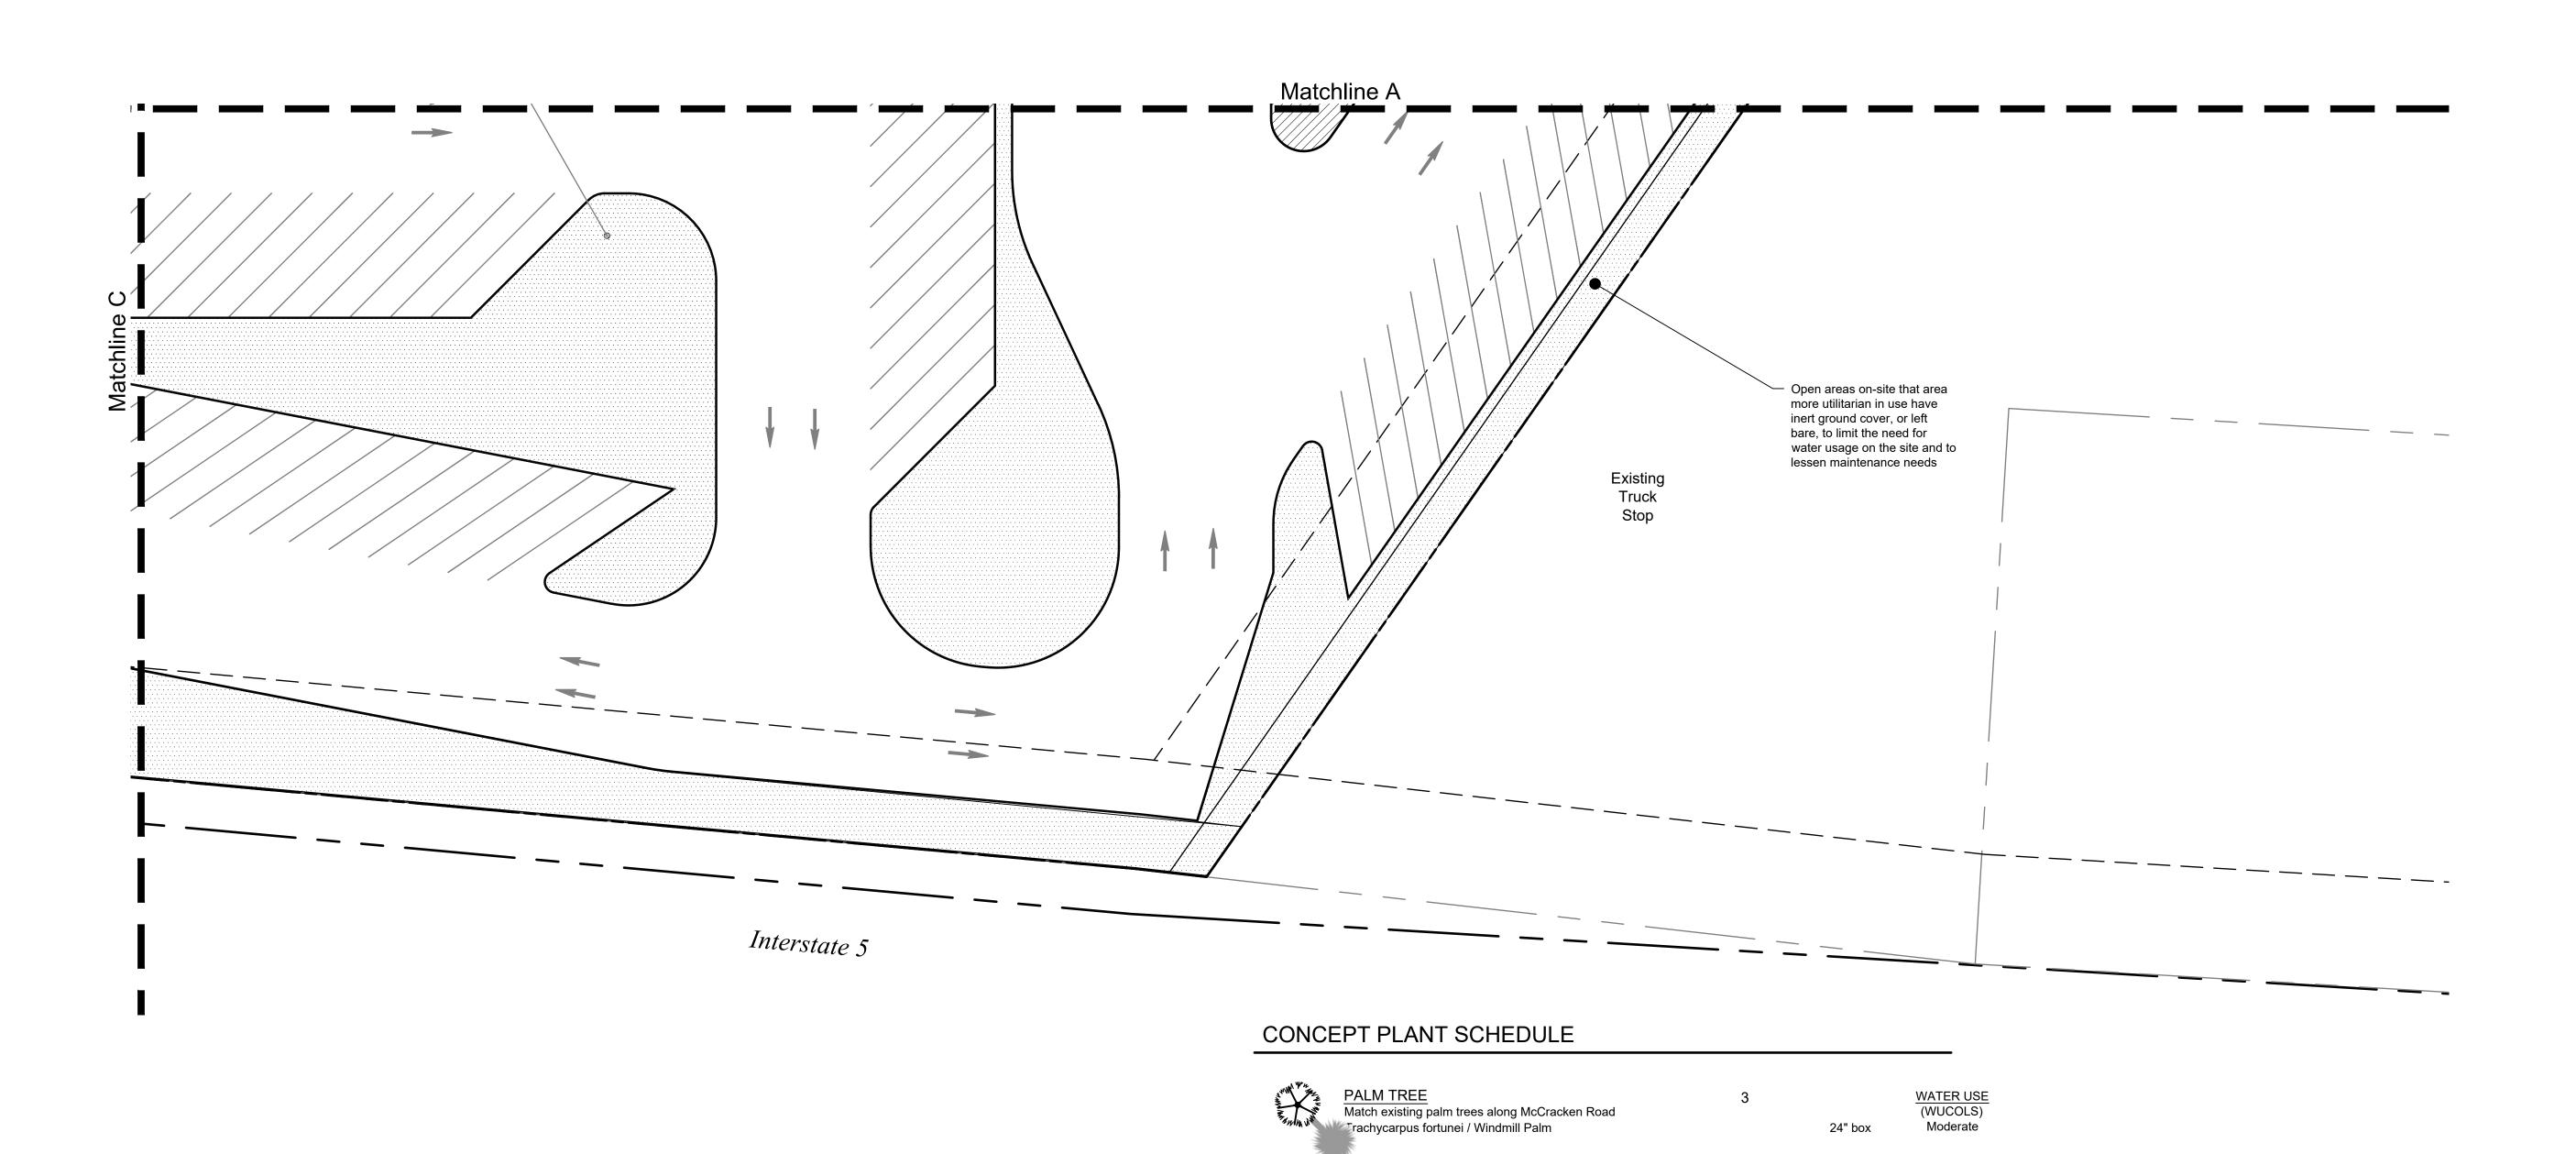

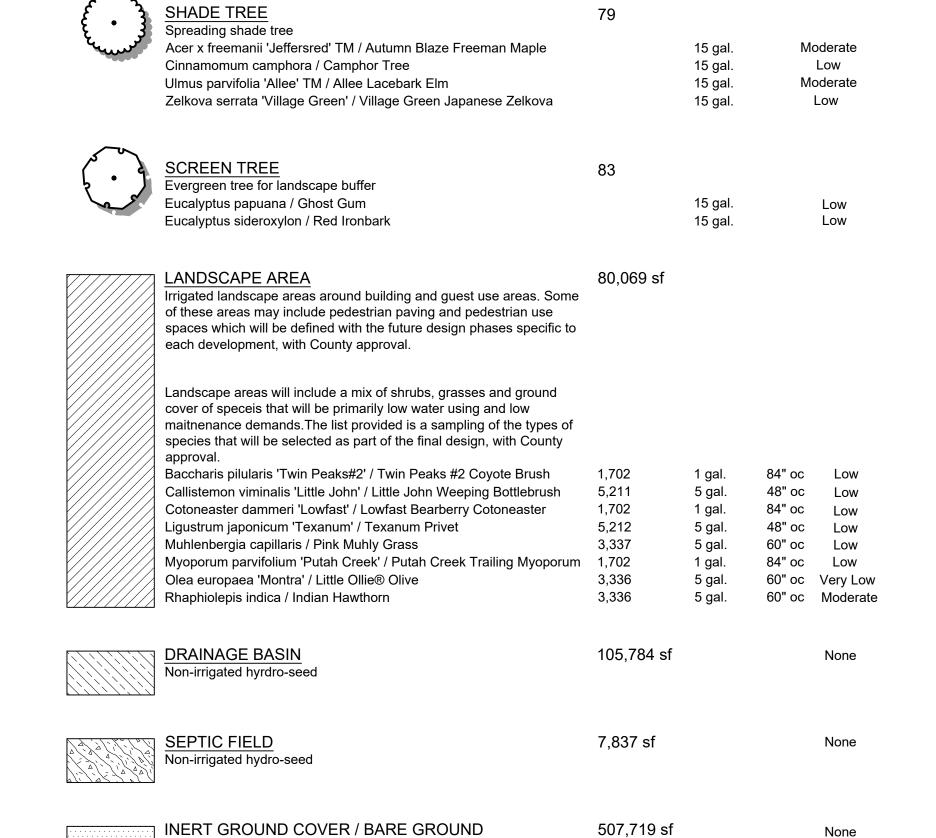

Non-irrigated areas for ease of maintenance and limiting need for water use. Either bare ground or some type of inert ground cover such

as gravel or crushed almond shells.

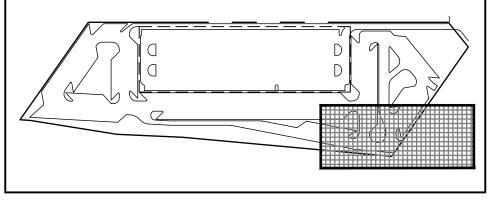



None









Prepared for: Triangle Property Inc. PO Box 3820 Turlock, CA 95381


Project:

50-ACRE STOP WESTLEY TRUCK


Revision: No. Desc.

Date: 20 Dec 2023 RSH Drawn: Checked: 22-032 Project No.: 1" = 40'-0"

Sheet: Preliminary Landscape Plan

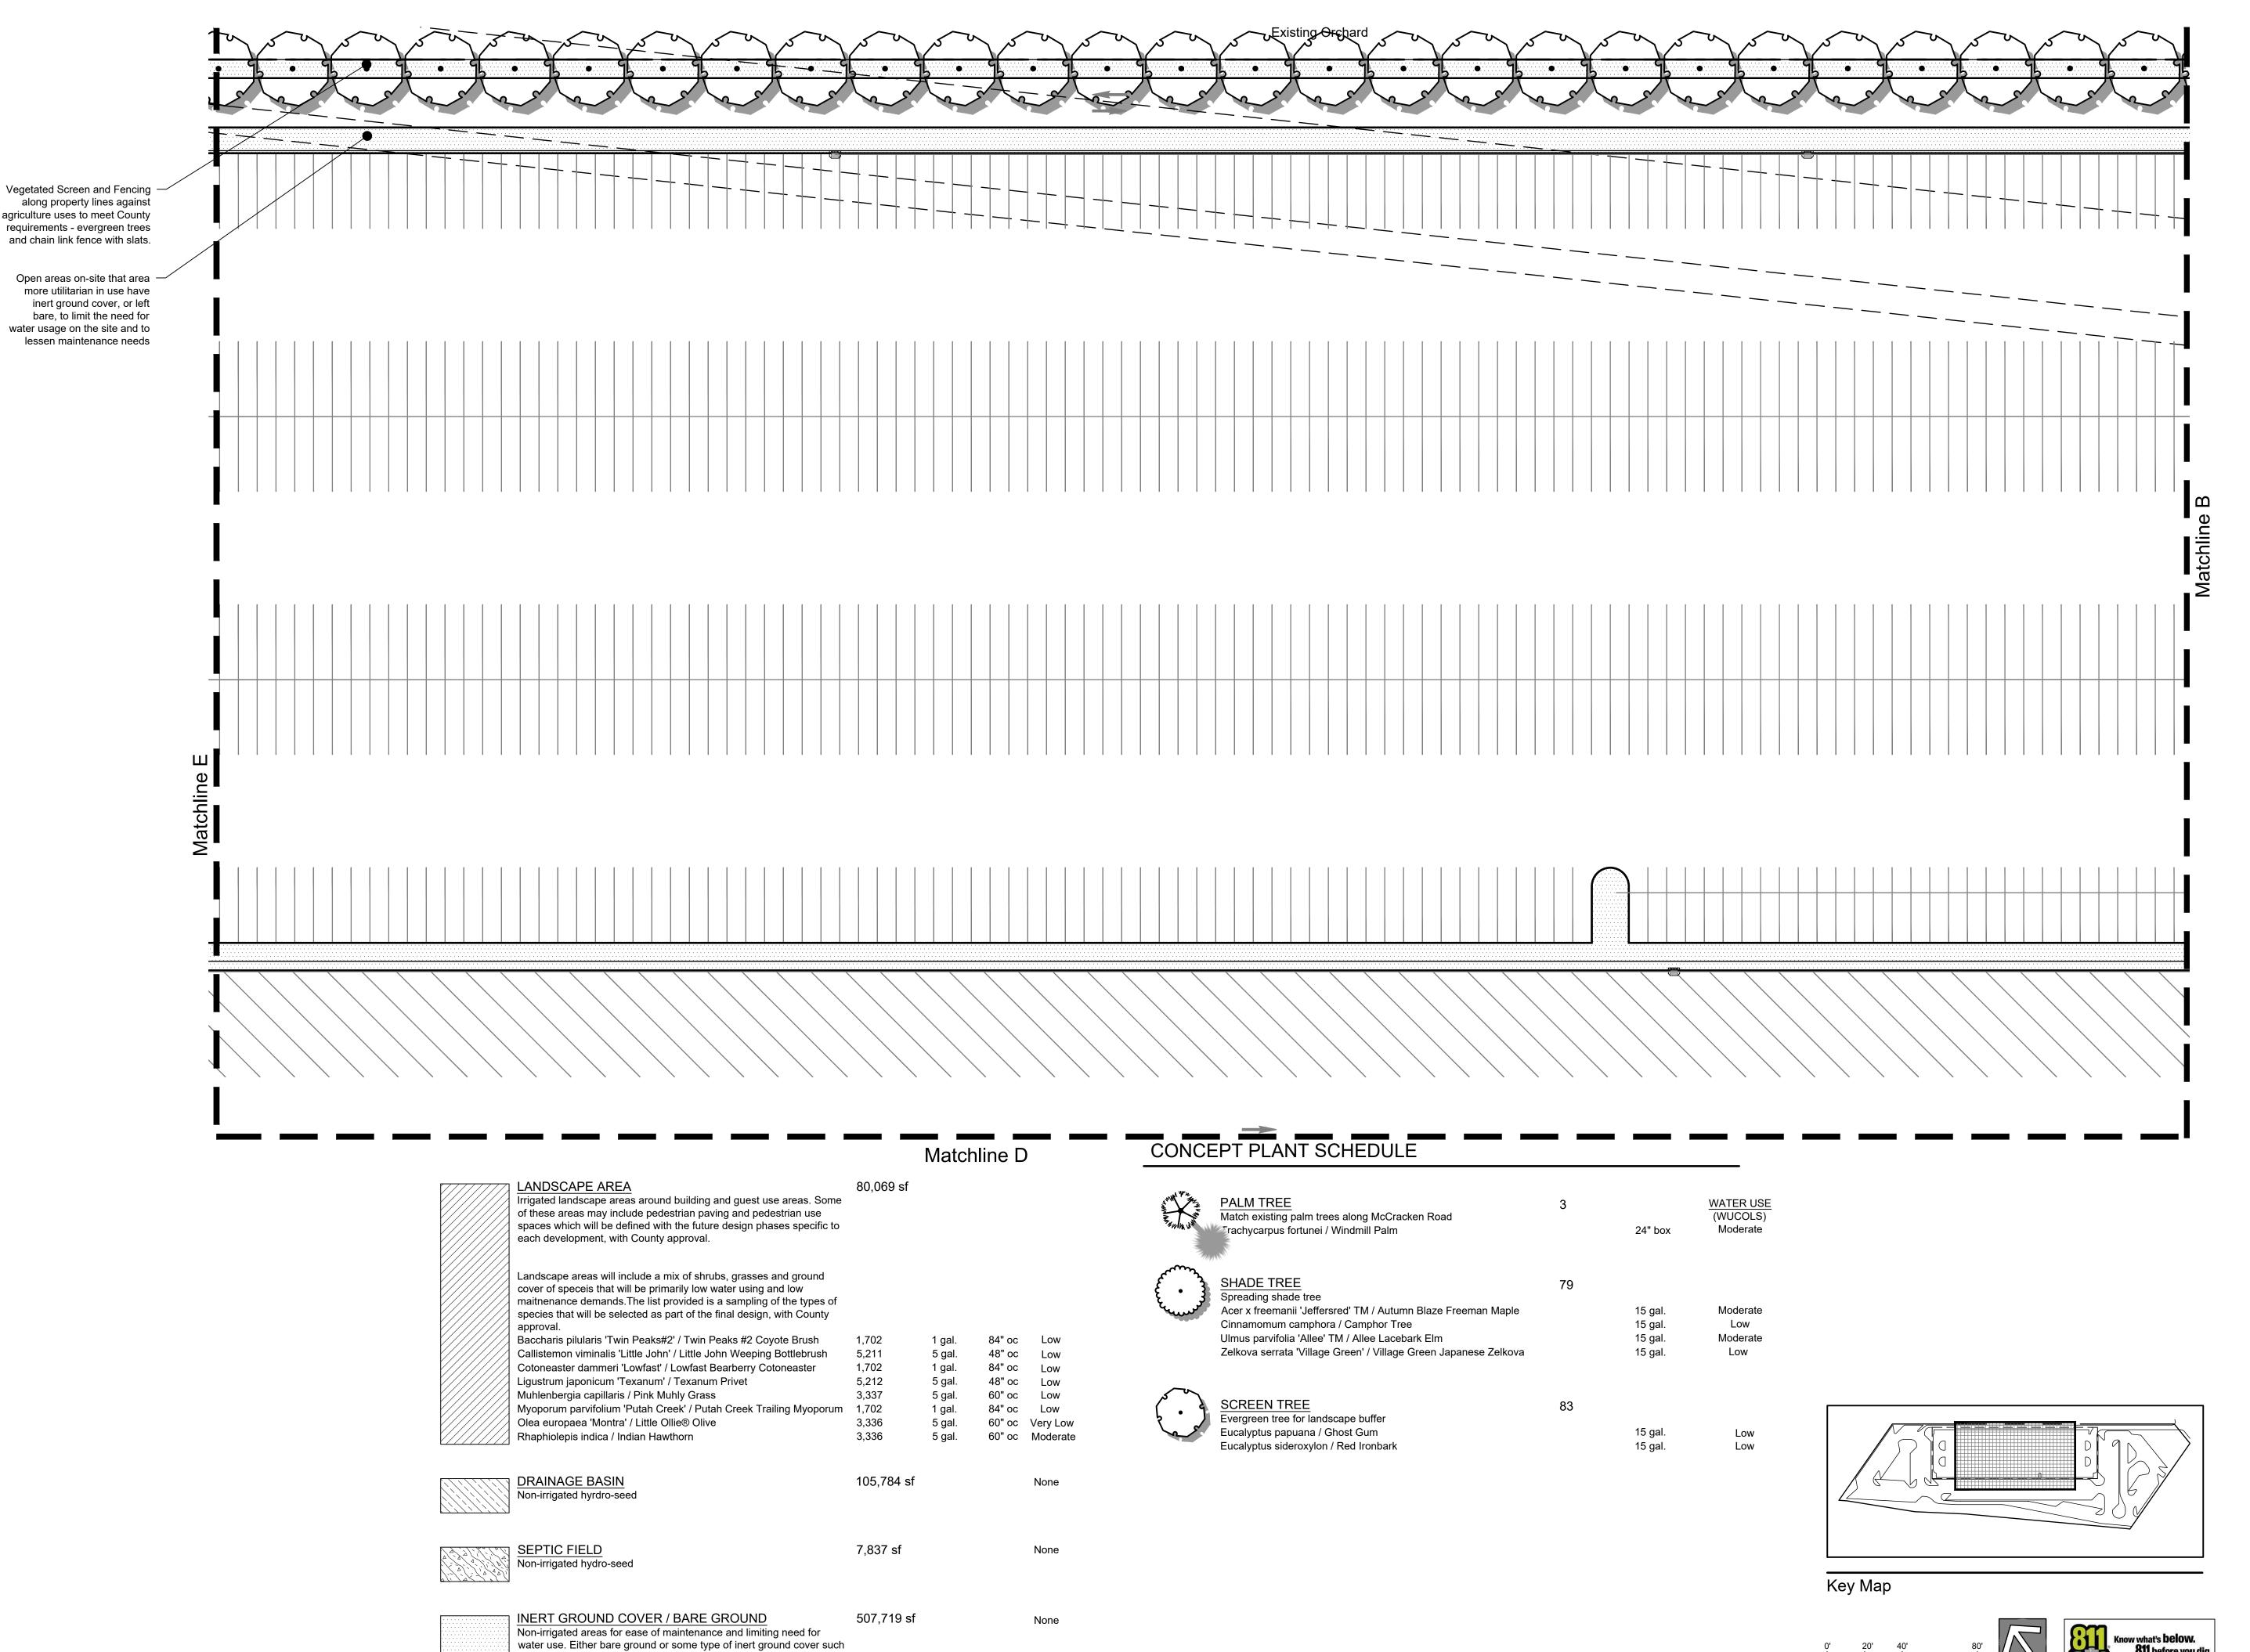



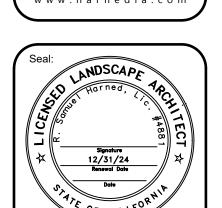

Prepared for:

PO Box 3820 Turlock, CA 95381

Triangle Property Inc.

Project:

50-ACRE STOP WESTLEY TRUCK

Revision: No. Desc.

Date: 20 Dec 2023 RSH Drawn: RSH Checked: 22-032 Project No.: 1" = 40'-0"


Sheet: Preliminary Landscape

Plan

as gravel or crushed almond shells.


along property lines against agriculture uses to meet County requirements - evergreen trees and chain link fence with slats.

more utilitarian in use have inert ground cover, or left bare, to limit the need for water usage on the site and to lessen maintenance needs

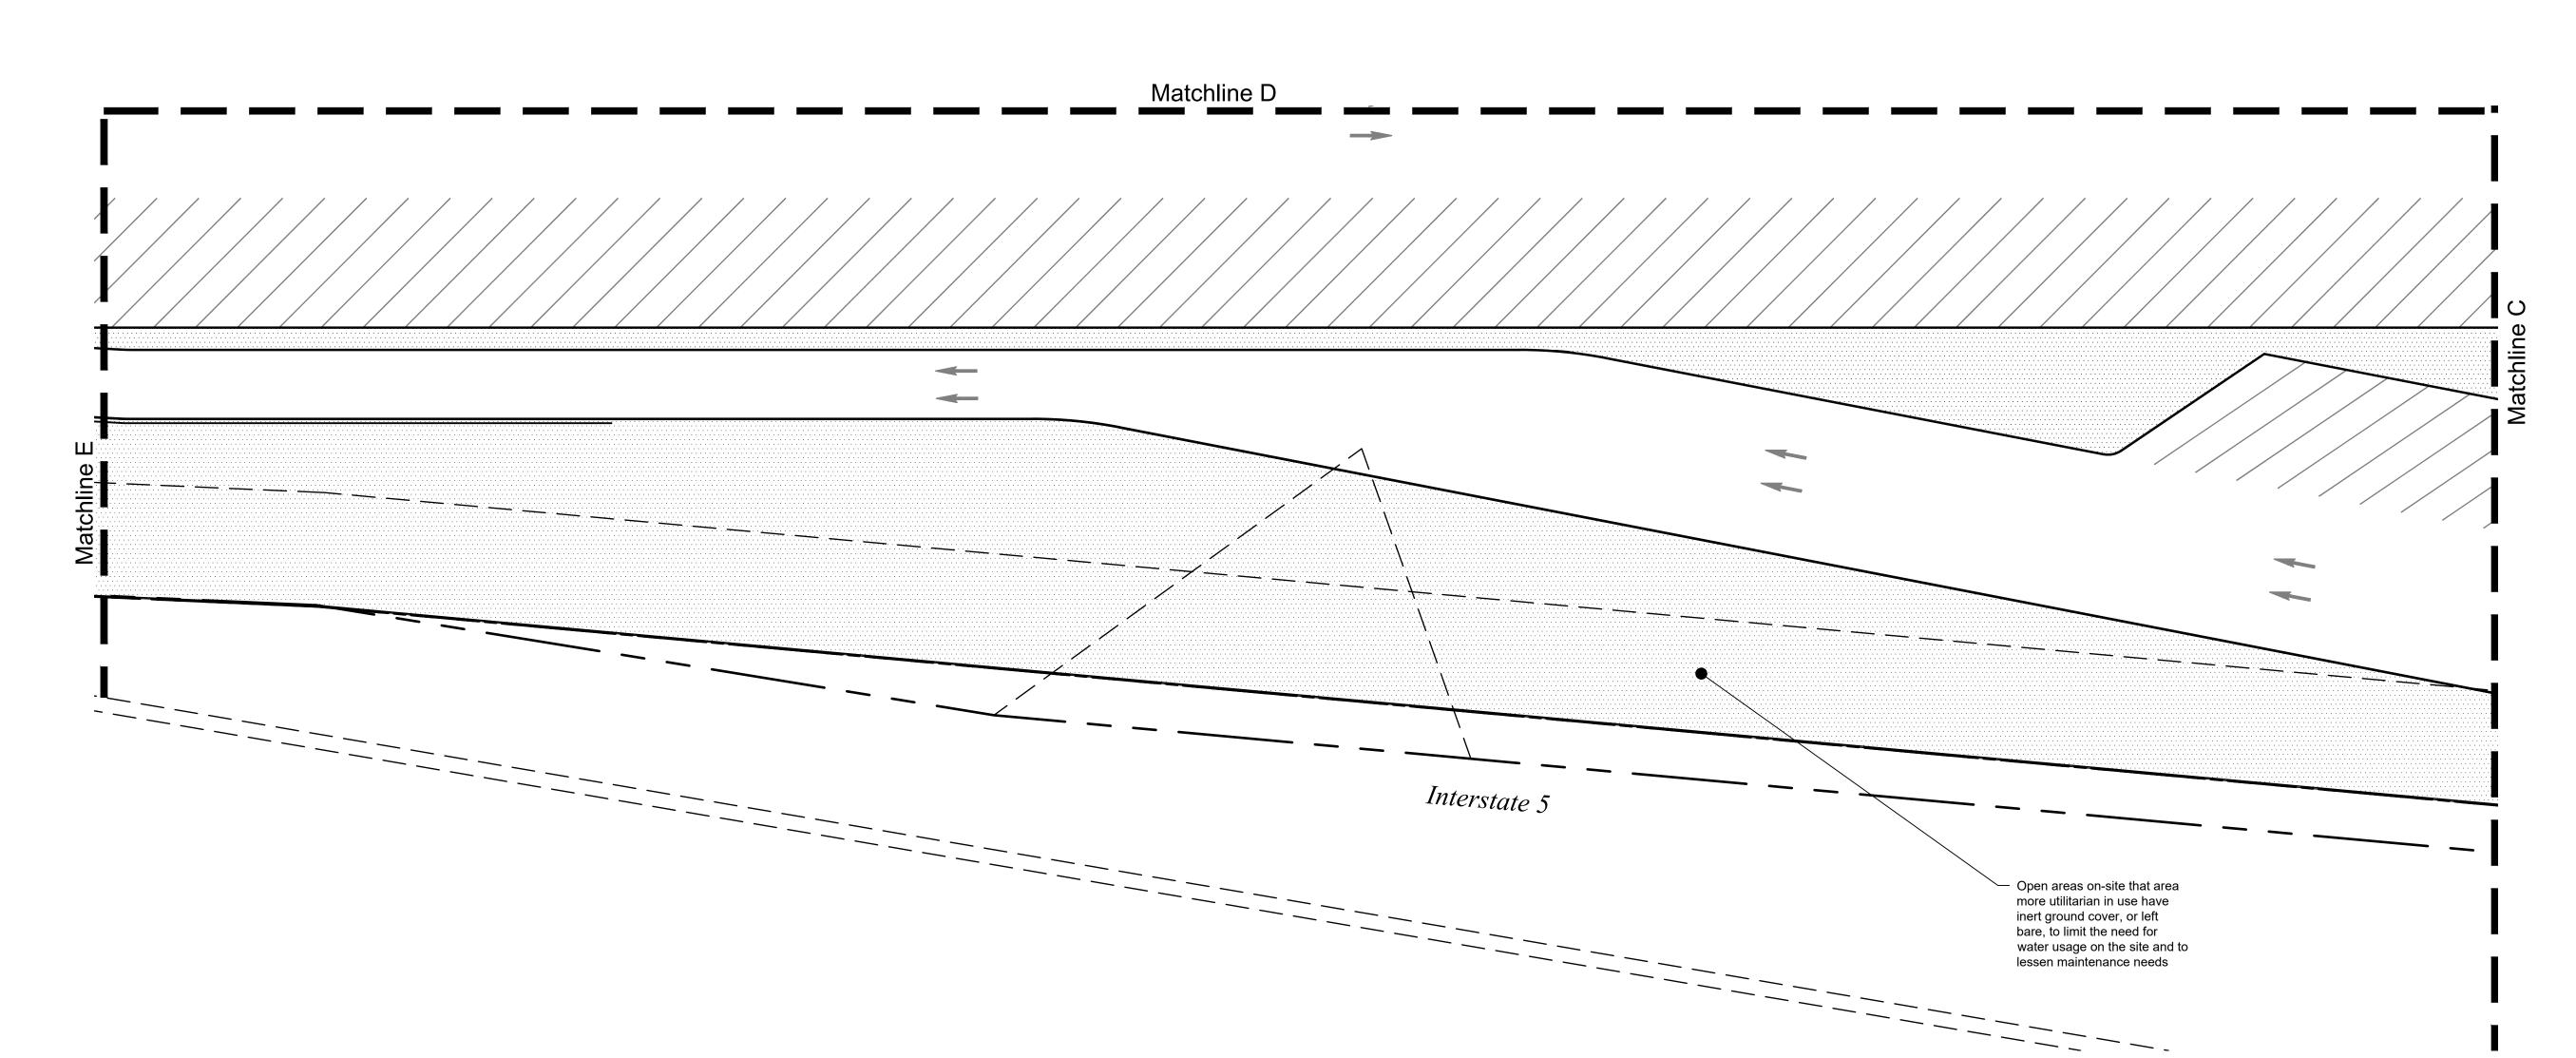

## CONCEPT PLANT SCHEDULE

THE WALL OF THE PARTY OF THE PA	PALM TREE  Match existing palm trees along McCracken Road  Trachycarpus fortunei / Windmill Palm	3	24" box	(WI	TER USE UCOLS) oderate
	SHADE TREE Spreading shade tree Acer x freemanii 'Jeffersred' TM / Autumn Blaze Freeman Maple Cinnamomum camphora / Camphor Tree Ulmus parvifolia 'Allee' TM / Allee Lacebark Elm Zelkova serrata 'Village Green' / Village Green Japanese Zelkova	79	15 gal. 15 gal. 15 gal. 15 gal.	Me	oderate Low oderate Low
	SCREEN TREE  Evergreen tree for landscape buffer  Eucalyptus papuana / Ghost Gum  Eucalyptus sideroxylon / Red Ironbark	83	15 gal. 15 gal.		Low Low
	LANDSCAPE AREA Irrigated landscape areas around building and guest use areas. Some of these areas may include pedestrian paving and pedestrian use spaces which will be defined with the future design phases specific to each development, with County approval.	80,069 sf			
	Landscape areas will include a mix of shrubs, grasses and ground cover of speceis that will be primarily low water using and low maitnenance demands. The list provided is a sampling of the types of species that will be selected as part of the final design, with County approval.	1 702	1 gal	94" 00	Low
	Baccharis pilularis 'Twin Peaks#2' / Twin Peaks #2 Coyote Brush Callistemon viminalis 'Little John' / Little John Weeping Bottlebrush Cotoneaster dammeri 'Lowfast' / Lowfast Bearberry Cotoneaster Ligustrum japonicum 'Texanum' / Texanum Privet Muhlenbergia capillaris / Pink Muhly Grass Myoporum parvifolium 'Putah Creek' / Putah Creek Trailing Myoporum Olea europaea 'Montra' / Little Ollie® Olive Rhaphiolepis indica / Indian Hawthorn	1,702 5,211 1,702 5,212 3,337 1,702 3,336 3,336	1 gal. 5 gal. 1 gal. 5 gal. 5 gal. 1 gal. 1 gal. 5 gal. 5 gal.	84" oc 48" oc 84" oc 48" oc 60" oc 60" oc 60" oc	Low Low Low Low Low Very Low Moderate
	DRAINAGE BASIN Non-irrigated hyrdro-seed	105,784 sf			None
	SEPTIC FIELD Non-irrigated hydro-seed	7,837 sf			None
	INERT GROUND COVER / BARE GROUND  Non-irrigated areas for ease of maintenance and limiting need for water use. Either bare ground or some type of inert ground cover such as gravel or crushed almond shells.	507,719 sf			None

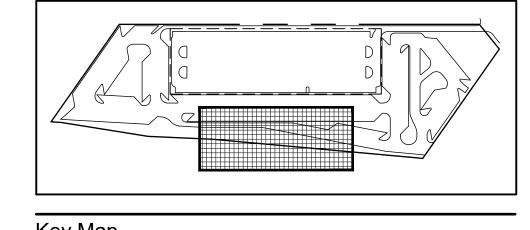

20' 40' 80'









Prepared for:

Triangle Property Inc.
PO Box 3820
Turlock, CA 95381

Project:

WESTLEY 50-ACRE TRUCK STOP

Revision:
No. Desc. Date

 Date:
 20 Dec 2023


 Drawn:
 RSH

 Checked:
 RSH

 Project No.:
 22-032

 Scale:
 1" = 40'-0"

Preliminary Landscape Plan

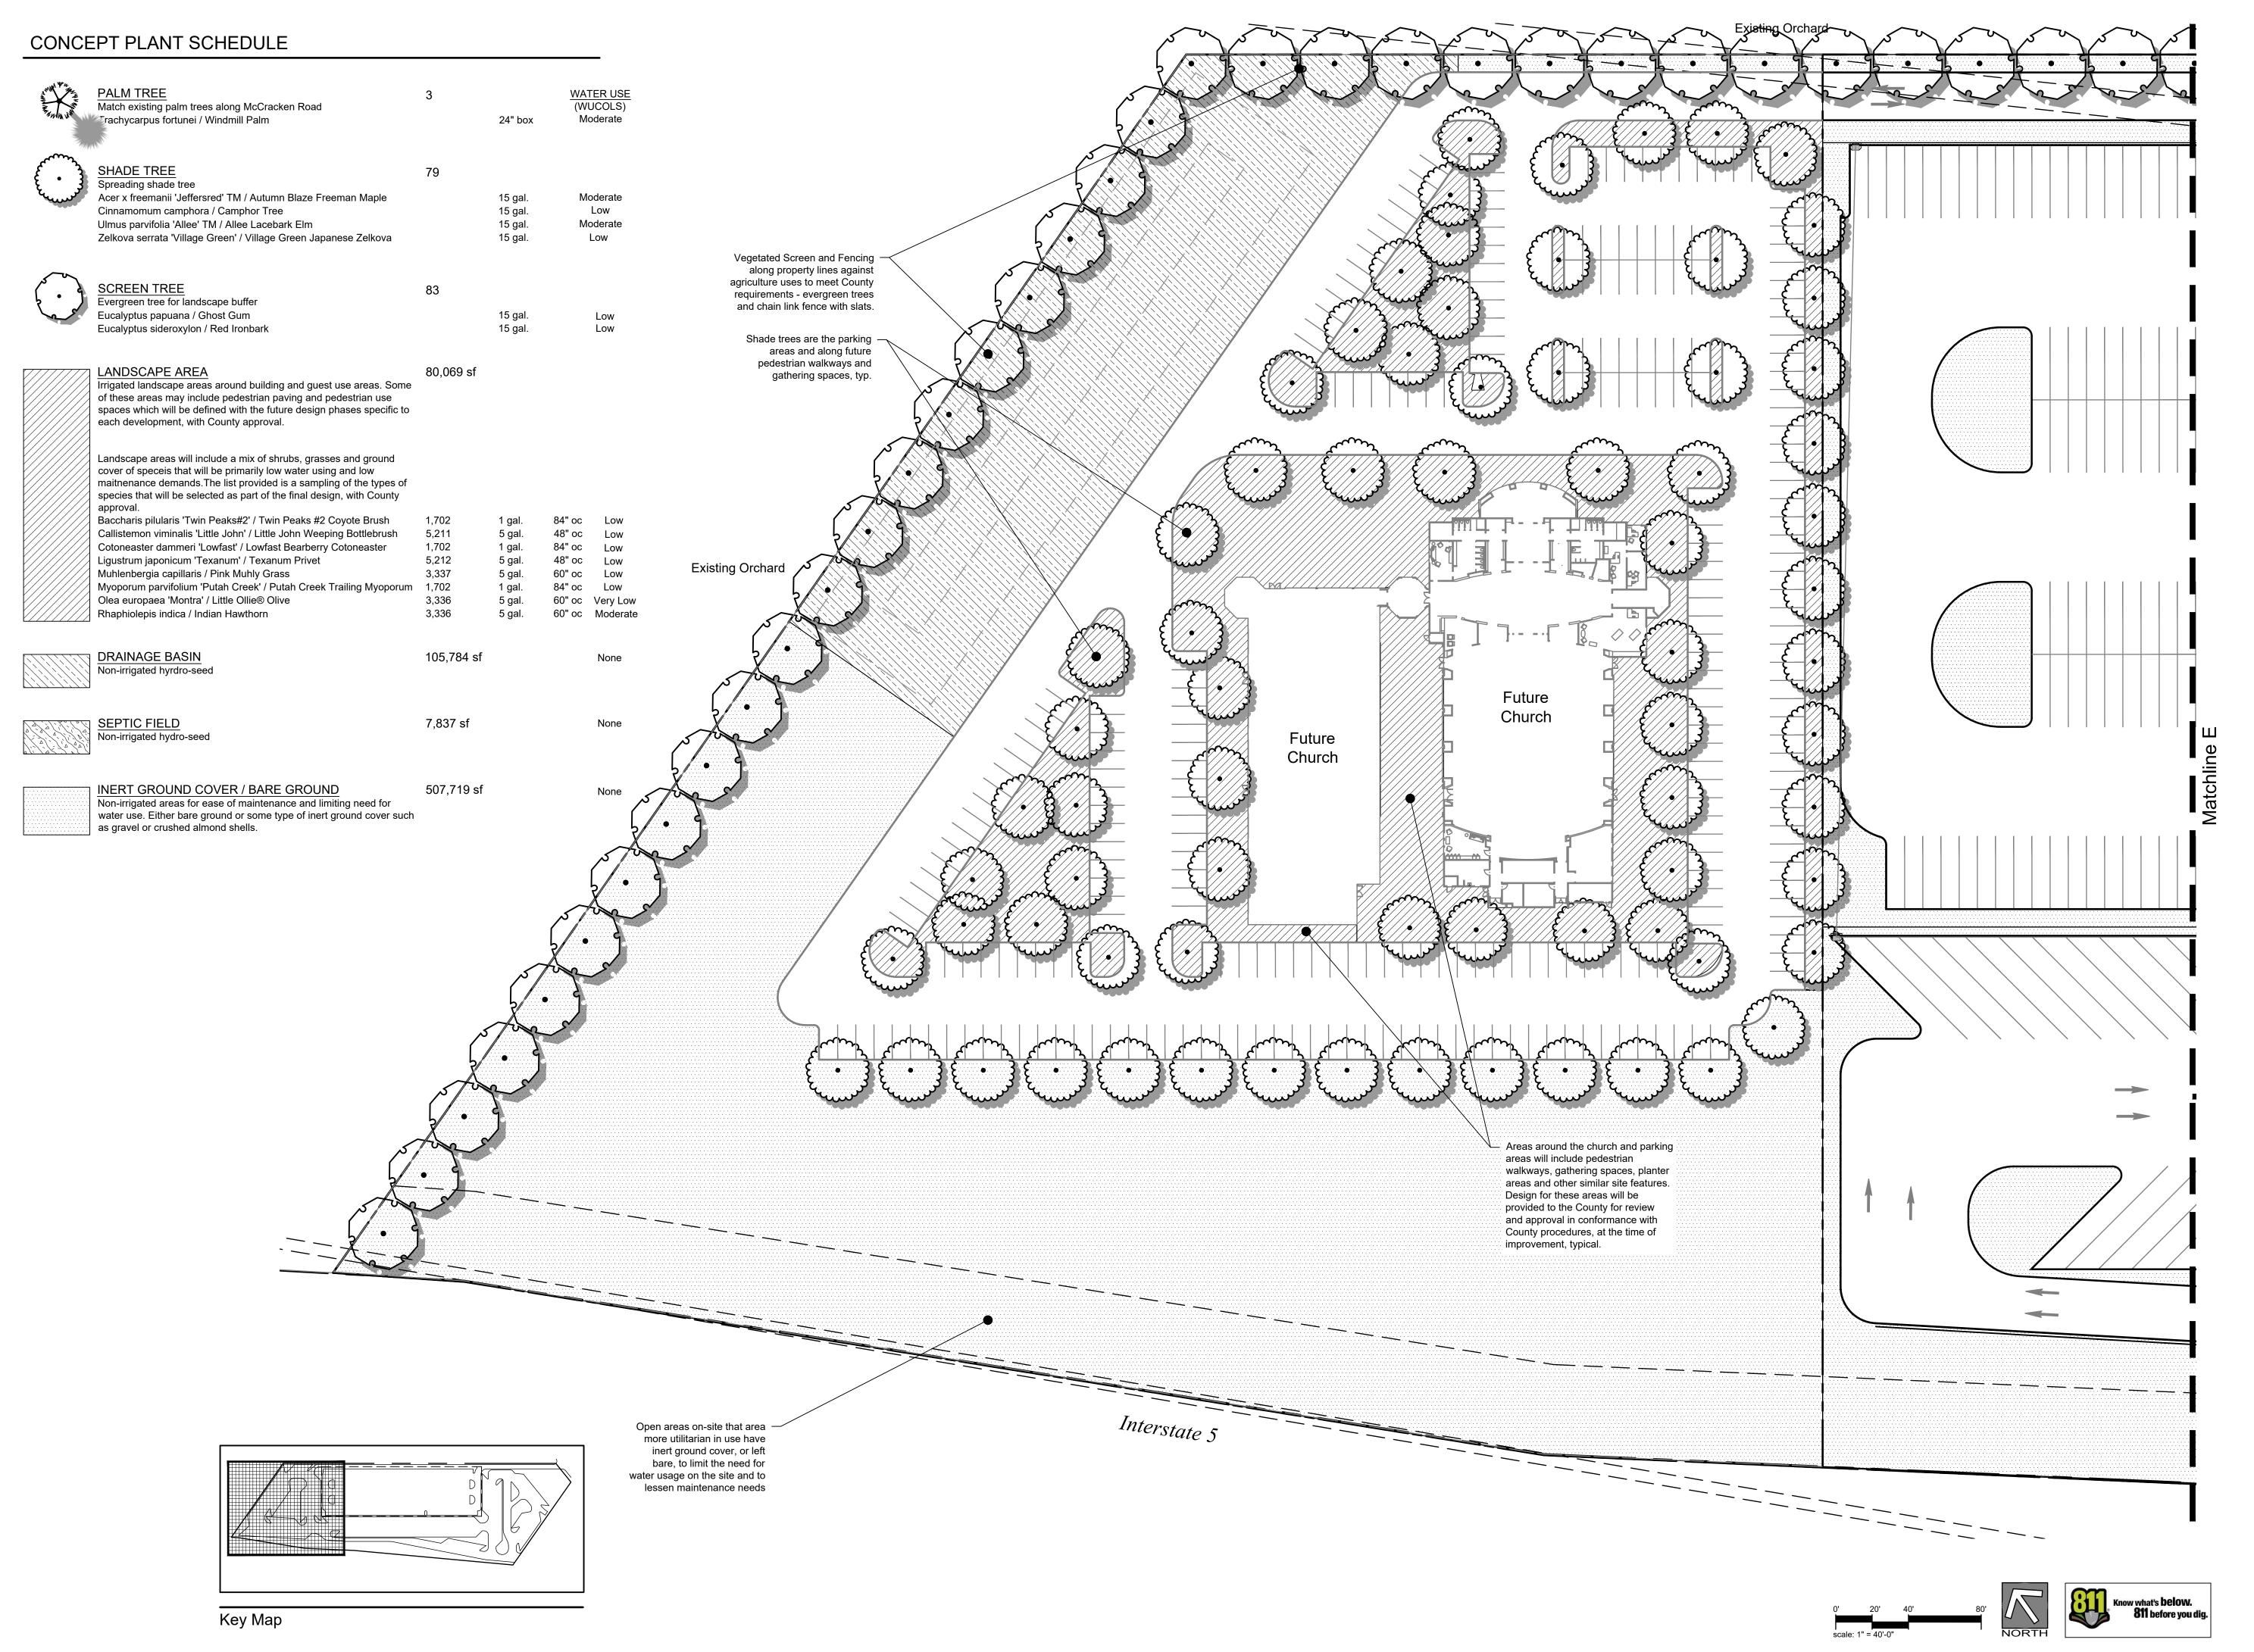





Prepared for:

Triangle Property Inc. PO Box 3820 Turlock, CA 95381

Project:

0-ACRI TOP 50 S WESTLEY TRUCK

Revision: No. Desc.

Date: 20 Dec 2023

Checked: 22-032 Project No.: 1" = 40'-0"

Preliminary Landscape Plan



### DEPARTMENT OF PLANNING AND COMMUNITY DEVELOPMENT

1010 10<sup>TH</sup> Street, Suite 3400, Modesto, CA 95354 Planning Phone: (209) 525-6330 Fax: (209) 525-5911

Building Phone: (209) 525-6557 Fax: (209) 525-7759

Form Available Online: http://www.stancounty.com/planning/applications.shtm

## APPLICATION QUESTIONNAIRE

	e Check all applicable boxes LICATION FOR:	PLANNING STAFF USE ONLY:		
				Application No(s): PLND-0085
Staff	is available to assist you with determ	Date: 7137133		
×	General Plan Amendment		Subdivision Map	S 35 T 4 R 6
×	Rezone	×	Parcel Map	Zoning: A-2-4D
	Use Permit		Exception	Fee: 11985
	Variance		Williamson Act Cancellation	Receipt No. 56742-5  Received By:
	Historic Site Permit		Other	Notes: GPA/PEZ /PM

In order for your application to be considered COMPLETE, please answer all applicable questions on the following pages, and provide all applicable information listed on the checklist on pages i – v. Under State law, upon receipt of this application, staff has 30 days to determine if the application is complete. We typically do not take the full 30 days. It may be necessary for you to provide additional information and/or meet with staff to discuss the application. Pre-application meetings are not required, but are highly recommended. An incomplete application will be placed on hold until all the necessary information is provided to the satisfaction of the requesting agency. An application will not be accepted without all the information identified on the checklist.

Please contact staff at (209) 525-6330 to discuss any questions you may have. Staff will attempt to help you in any way we can.

### PROJECT INFORMATION

**PROJECT DESCRIPTION:** (Describe the project in detail, including physical features of the site, proposed improvements, proposed uses or business, operating hours, number of employees, anticipated customers, etc. – Attach additional sheets as necessary)

\*Please note: A detailed project description is essential to the reviewing process of this request. In order to approve a project, the Planning Commission or the Board of Supervisors must decide whether there is enough information available to be able to make very specific statements about the project. These statements are called "Findings". It is your responsibility as an applicant to provide enough information about the proposed project, so that staff can recommend that the Commission or the Board make the required Findings. Specific project Findings are shown on pages 17 – 19 and can be used as a guide for preparing your project description. (If you are applying for a Variance or Exception, please contact staff to discuss special requirements).

This 50-acre parcel is located at 7003 S McCracken Road in Westley, CA and is directly adjacent to Highway 5 at Howard

Road exit. This project is proposing three newly created parcels and will contain primarily truck parking stalls along with

a container storage yard. The truck parking will be placed on two adjacent parcels directly north of the existing truck stop

to the south. These parcels will be 24-acres and 10-acres, respectively. The container storage yard will be 16-acres.

## PROJECT SITE INFORMATION

Complete and accurate information saves time and is vital to project review and assessment. Please complete each section entirely. If a question is not applicable to your project, please indicated this to show that each question has been carefully considered. Contact the Planning & Community Development Department Staff, 1010 10<sup>th</sup> Street – 3<sup>rd</sup> Floor, (209) 525-6330, if you have any questions. Pre-application meetings are highly recommended.

ASSESSOR'S PARCEL I	NUMBER(S):	Book	016	Page	036	Parcel	028
Additional parcel numbers: Project Site Address or Physical Location:	7003 S McCra	cken Road	l, Westley, CA	95387			
Property Area:	Acres:	50	or Square	e feet:			
Current and Previous Land Use	e: (Explain existi	ng and pre	evious land us	e(s) of site f	or the last te	en years)	
Ag-40, but the property has no	ot been used for	agricultur	re, but instead	d for illegal r	esidential (	mobile home	) use.
List any known previous propect name, type of project, and		for this s	site, such as	a Use Perr	nit, Parcel	Map, etc.: (	Please identify
Only projects we are aware of	being approved	l is the exis	sting planned	developme	nt site dire	ctly south of t	his property
which is owned by the same e	entity. The existir	ng site sou	th is a truck st	top with tru	ck wash, ga	s station, and	diesel fuel.
Existing General Plan & Zoni	ng: <u>Ag-40</u>						
Proposed General Plan & Zor (if applicable)	ning: Planned D	evelopme	ent - Commerc	cial			
ADJACENT LAND USE: direction of the project site)	(Describe adja	acent land	uses within	1,320 feet (	1/4 mile) a	nd/or two par	cels in each
East: Ag-40							
West: Highway 5 & Ag-40							
North: Ag-40							
South: Planned Development	t - Commercial						
WILLIAMSON ACT CONT	TRACT:						
Yes 🗆 No 🗆	Is the property Contract Numb						
	If yes, has a No	otice of Nor	n-Renewal be	en filed?			
	B ( E'' )						

Yes L	No		Do you propose to cancel any portion of the Contract?
Yes 🗆	No		Are there any agriculture, conservation, open space or similar easements affecting the use of the project site. (Such easements do not include Williamson Act Contracts)
			If yes, please list and provide a recorded copy:
SITE CH	IAR	ACTER	RISTICS: (Check one or more) Flat  Rolling  Steep
VEGET	ATIC	ON: Wh	at kind of plants are growing on your property? (Check one or more)
Field crop	s C	]	Orchard
Shrubs			Woodland ☐ River/Riparian ☐ Other ☑
Explain O	ther:	The exi	sting site has a few dirt roads and mostly low lying, dead weeds
Yes 🗵	No		Do you plan to remove any trees? (If yes, please show location of trees planned for removal on plot plan and provide information regarding transplanting or replanting.)
GRADIN	IG:		
Yes 🗵	No		Do you plan to do any grading? (If yes, please indicate how many cubic yards and acres to be disturbed. Please show areas to be graded on plot plan.) <u>+/- 200,000 cy</u>
STREAM	MS,	LAKES	S, & PONDS:
Yes 🗵	No	X	Are there any streams, lakes, ponds or other watercourses on the property? (If yes, please show on plot plan)
Yes 🗵	No		Will the project change any drainage patterns? (If yes, please explain – provide additional sheet if needed) The site will retain the existing grade along the highway-5 frontage and then will
			slope down at a maximum 3:1 slope. The remainder of the site will be graded at +/- 3% N-S
Yes 🛚	No	X	Are there any gullies or areas of soil erosion? (If yes, please show on plot plan)
Yes	No	X	Do you plan to grade, disturb, or in any way change swales, drainages, ditches, gullies, ponds, low lying areas, seeps, springs, streams, creeks, river banks, or other area on the site that carries or holds water for any amount of time during the year? (If yes, please show areas to be graded on plot plan)
			Please note: If the answer above is yes, you may be required to obtain authorization from other agencies such as the Corps of Engineers or California Department of Fish and Game.

STRUC	TUR	ES:				
Yes 🗵	No		Are there structures on the site? (I property lines and other features of the		show on plot plan.	Show a relationship to
Yes 🗵	No		Will structures be moved or demolished	ed? (If yes, indi	cate on plot plan.)	
Yes 🗵	No		Do you plan to build new structures?	(If yes, show loo	cation and size on plot <sub>l</sub>	plan.)
Yes 🗆	No	X	Are there buildings of possible Histor size on plot plan.)	rical significand	ce? (If yes, please exp	olain and show location and
PROJE	CT S	SITE CC	VERAGE:			
Existing B	uildir	ig Covera	age: <u>+/- 5,500</u> Sq. Ft.	Lar	ndscaped Area:	0 (dirt&weeds) Sq. Ft.
Proposed	Build	ling Cove	erage:+/- 7,600Sq. Ft.	Pa	ved Surface Area:	<u>+/- 185,000</u> Sq. Ft.
Size of ne at approx Number o	w str	ucture(s) ely 7,600 rs for eac	or building addition(s) in gross sq. ft.:  sf which includes three (3) lube bays th building: 1-story neasured from ground to highest point)	and storage fo	or diesel truck maint	enance. ary) 24.5'
Height of equipmen	other t, ligh	appurte t poles, e	nances, excluding buildings, measured btc.): (Provide additional sheets if necessa	d from ground ary)_N?A	to highest point (i.e	., antennas, mechanical
Proposed material to	surfa be us	ace mate ed) Parki	erial for parking area: (Provide informa ng areas will be pavement and walkw	ation addressing ays around bù	g dust control measur iilding and near outo	es if non-asphalt/concrete door grass areas will be
concrete.						
UTILITIE	ES A	ND IRF	RIGATION FACILITIES:			
Yes 🗵	No		Are there existing public or private utili yes, show location and size on plot plan)	ities on the site	e? Includes telephor	ne, power, water, etc. (If
Who provi	des,	or will pro	ovide the following services to the prope	erty?		
Electrical:			PG&E	Sewer*:	Private se	eptic system
Telephone	):			Gas/Propan	e:	PG&E
Mator**			Private on-site well	Irrigation:	Private o	n-site well

\*Please Note: A "will serve" letter is required if the sewer service will be provided by City, Sanitary District, Community Services District, etc.

\*\*Please Note: A "will serve" letter is required if the water source is a City, Irrigation District, Water District, etc., and the water purveyor may be required to provide verification through an Urban Water Management Plan that an adequate water supply exists to service your proposed development.

Will any special or unique sewage wastes be generated by this development other than that normally associated with resident or employee restrooms? Industrial, chemical, manufacturing, animal wastes? (Please describe:)

No, sewage waste will be directyl from one restroom and multiple faucet/sinks inside building. Wastewater will be minimal and will be accounted for via septic tank and leach lines. Please Note: Should any waste be generated by the proposed project other than that normally associated with a single family residence, it is likely that Waste Discharge Requirements will be required by the Regional Water Quality Control Board. Detailed descriptions of quantities, quality, treatment, and disposal may be required. Yes 🗵 Are there existing irrigation, telephone, or power company easements on the property? (If yes, show location and size on plot plan.) Yes No 🗵 Do the existing utilities, including irrigation facilities, need to be moved? (If yes, show location and size on plot plan.) Yes X Does the project require extension of utilities? (If yes, show location and size on plot plan.) AFFORDABLE HOUSING/SENIOR: Yes D No 🗵 Will the project include affordable or senior housing provisions? (If yes, please explain) **RESIDENTIAL PROJECTS:** (Please complete if applicable – Attach additional sheets if necessary) Total Dwelling Units:\_\_\_\_\_ Total Acreage:\_\_\_\_\_ Total No. Lots:\_\_\_\_\_ Gross Density per Acre: \_\_\_\_\_ Net Density per Acre: Two Family Single Multi-Family Multi-Family (complete if applicable) Family Duplex Apartments Condominium/ Townhouse Number of Units: Acreage: COMMERCIAL, INDUSTRIAL, MANUFACTURING, RETAIL, USE PERMIT, OR OTHER **PROJECTS:** (Please complete if applicable – Attach additional sheets if necessary) Square footage of each existing or proposed building(s): +/-7,600 sf Type of use(s): Three (3) bay lube and tire repair shop for existing and proposed truck stop facility.

Days and hours of operation	n: Truck parking will be 24/7,	lube bay(s) and repair shop building will be 7 days a week						
7am-7pm, and the container storage yard will be open 7 days a week from 7am-7pm.								
Seasonal operation (i.e., packing shed, huller, etc.) months and hours of operation: N/A								
Occupancy/capacity of buil	ding: N/A							
Number of employees: (Ma	aximum Shift): _5 (repair shop)	7 (container) (Minimum Shift): 2 (repair shop) 3 (container)						
Estimated number of daily	customers/visitors on site at pea	sk time:10 trucks at peak time (repair shop) 10 (containers)						
Other occupants: N/A								
Estimated number of truck	deliveries/loadings per day:	Twice per week (repair shop) about 20 per day (container)						
Estimated hours of truck de	eliveries/loadings per day:	7am-7pm (repair shop) 7am-7pm (container)						
Estimated percentage of tra	affic to be generated by trucks:	TBD						
Estimated number of railroad deliveries/loadings per day:N/A								
Square footage of:								
Office area:		Warehouse area:						
Sales area:		Storage area:						
Loading area:		Manufacturing area:						
Other: (explain typ	e of area)							
Yes No D Wil	I the proposed use involve toxic	or hazardous materials or waste? (Please explain)						
Th	e lube bay/repair shop will han	dle different types of hazardous materials/waste including						
oil	s, gasoline, etc. All hazardous m	naterials and waste will be handled and disposed of per						
loc	cal laws/standards.							
-								
ROAD AND ACCESS	INFORMATION:							
What County road(s) will pro	ovide the project's main access?	? (Please show all existing and proposed driveways on the plot plan)						
S McCracken Road current	y provides access to the existin	g Triangle Truck stop. The proposed truck parking and						
repair shop will be accesse	d directly through the existing	Triangle Truck Stop to the South (same owners with						
reciprocal access easements). S McCracken Road will provide direct access for the container storage yard.								

Yes 🗆	No	X	Are there private or public road or access easements on the property now? (If yes, show location and size on plot plan)				
Yes 🗵	No		Do you require a private road or easement to access the property? (If yes, show location and size on plot plan)				
Yes 🗵	No		Do you require security gates and fencing on the access? (If yes, show location and size on plot plan)				
approval	of ar	n Except	that do not front on a County-maintained road or require special access may require tion to the Subdivision Ordinance. Please contact staff to determine if an exception is s the necessary Findings.				
STORM	DR	AINAG	E:				
How will y	our p	oroject ha	andle storm water runoff? (Check one) 🗷 Drainage Basin 🔲 Direct Discharge 🔲 Overland				
Other:	(ple	ase expl	ain)				
If direct dis	schai	rge is pro	pposed, what specific waterway are you proposing to discharge to?				
Please Note: If direct discharge is proposed, you will be required to obtain a NPDES permit from the Regional Water Quality Control Board, and must provide evidence that you have contacted them regarding this proposal with your application.							
mplement		grading a	ny portion of the site, please provide a description of erosion control measures you propose to				
Construct	ion e	entrance,	, fiber rolls, silt fencing, inlet filter bags with gravel bags, wind/dust and erosion control via				
constructi	ion v	vater. etc					
			be required to obtain an NPDES Storm Water Permit from the Regional Water Quality pare a Storm Water Pollution Prevention Plan.				
ADDITIC	NA	L INFO	RMATION:				
			o provide any other information you feel is appropriate for the County to consider during review of h extra sheets if necessary)				

### CENTRAL CALIFORNIA INFORMATION CENTER

California Historical Resources Information System Department of Anthropology - California State University, Stanislaus One University Circle, Turlock, California 95382 (209) 667-3307

Alpine, Calaveras, Mariposa, Merced, San Joaquin, Stanislaus & Tuolumne Counties

Date: 7/26/2022

Records Search File #: 12249N Project: Proposed Truck Stop Development, 7003 S. McCracken Rd., Westley, CA 95363

Prabhjot Singh, Owner 5 E. Main Street, Suite B Turlock, CA 95380

Invoice to: c/o Daniel Barnes/RMK Design, Inc. 1801 Lander Ave, Turlock, CA 95380 (209) 634-4832 dbarnes@rmkdesign.net

Dear Mr. Singh:

We have conducted a Priority Response/non-confidential extended records search as per the request of Mr. Daniel Barnes, PE, RMK Design, Inc. for the above-referenced project area located on the Solyo USGS 7.5-minute quadrangle map in Stanislaus County.

Search of our files includes review of our maps for the specific project area and the immediate vicinity of the project area, and review of the following:

National Register of Historic Places (NRHP)

California Register of Historical Resources (CRHR)

California Inventory of Historic Resources (1976)

California Historical Landmarks

California Points of Historical Interest listing

Office of Historic Preservation Built Environment Resource Directory (BERD) and the

Archaeological Determinations of Eligibility (ADOE)

Survey of Surveys (1989)

Caltrans State and Local Bridges Inventory

General Land Office Plats

Other pertinent historic data available at the CCaIC for each specific county

The following details the results of the records search:

### Prehistoric or historic resources within the project area:

- There are no formally recorded prehistoric or historic archaeological resources or historic buildings or structures within the project area.
- The General Land Office Survey Plats for T4S R6E (dated 1855 and 1871) do not show any historic features within the NE ¼ of Section 35.

• The 1953 edition of the Solyo 7.5' USGS quadrangle shows "Pipelines" adjacent to the northeast portion of the project area in the NE ¼ of Section 35, T4S R6E. We have no further information on file regarding these possible historical resources.

**Prehistoric or historic resources within the immediate vicinity of the project area:** None formally reported to the Information Center, but we caution that both prehistoric and historic archaeological resources as well as historic structures have been recorded within the general environs of the Solyo USGS map.

Resources that are known to have value to local cultural groups: None has been formally reported to the Information Center.

**Previous investigations within the project area:** Three investigations have been conducted that included the general project area (see references below), but no project-specific investigations have been conducted:

Moratto, M. et al. (INFOTECH Research, Inc. and BioSystems Analysis, Inc.)

1990 Cultural Resources Assessment Report PGT-PG&E Pipeline Expansion
Project in Idaho, Washington, Oregon and California; Phase 1: Survey,
Inventory, and Preliminary Evaluation of Cultural Resources [ CCIC has
only a partial copy of report].

CCaIC Report ST-00621

Maniery, M. L. (Public Anthropological Research)

1985 Cultural Resource Inventory and Evaluation of Stanpac #2 Gasoline Project, Stanislaus and San Joaquin Counties, California.

CCaIC Report ST-00749

Canaday, T., M. Ostrogorsky, and M. Hess (Infotec Research, Inc.)

1992 Archaeological Survey of Right-of-Way Corridor and Extra Work Spaces

Construction Spread 5B, California; PGT-PG&E Pipeline Expansion

Project, California.

CCaIC Report ST-01846

### **Recommendations/Comments:**

Please be advised that a historical resource is defined as a building, structure, object, prehistoric or historic archaeological site, or district possessing physical evidence of human activities over 45 years old. Since the property has not been subject to project-specific investigations, there may be unidentified features involved in your project that are 45 years or older and considered as historical resources requiring further study and evaluation by a qualified professional of the appropriate discipline.

If the current project does not include ground disturbance, further study for archaeological resources is not recommended at this time. If ground disturbance is considered a part of the current project, we recommend further review for the possibility of identifying prehistoric or historic-era archaeological resources.

If the proposed project contains buildings or structures that meet the minimum age requirement (45 years in age or older) it is recommended that the resource/s be assessed by a professional familiar with architecture and history of the county. Review of the available historic building/structure data has included only those sources listed above and should not be considered comprehensive.

If at any time you might require the services of a qualified professional the Statewide Referral List for Historical Resources Consultants is posted for your use on the internet at <a href="http://chrisinfo.org">http://chrisinfo.org</a>

If archaeological resources are encountered during project-related activities, work should be temporarily halted in the vicinity of the discovered materials and workers should avoid altering the materials and their context until a qualified professional archaeologist has evaluated the situation and provided appropriate recommendations. Project personnel should not collect cultural resources.

If human remains are discovered, California Health and Safety Code Section 7050.5 requires you to protect the discovery and notify the county coroner, who will determine if the find is Native American. If the remains are recognized as Native American, the coroner shall then notify the Native American Heritage Commission (NAHC). California Public Resources Code Section 5097.98 authorizes the NAHC to appoint a Most Likely Descendant (MLD) who will make recommendations for the treatment of the discovery.

Due to processing delays and other factors, not all of the historical resource reports and resource records that have been submitted to the State Office of Historic Preservation are available via this records search. Additional information may be available through the federal, state, and local agencies that produced or paid for historical resource management work in the search area. Additionally, Native American tribes have historical resource information not in the CHRIS Inventory, and you should contact the California Native American Heritage Commission for information on local/regional tribal contacts.

The California Office of Historic Preservation (OHP) contracts with the California Historical Resources Information System's (CHRIS) regional Information Centers (ICs) to maintain information in the CHRIS inventory and make it available to local, state, and federal agencies, cultural resource professionals, Native American tribes, researchers, and the public. Recommendations made by IC coordinators or their staff regarding the interpretation and application of this information are advisory only. Such recommendations do not necessarily represent the evaluation or opinion of the State Historic Preservation Officer in carrying out the OHP's regulatory authority under federal and state law.

We thank you for contacting this office regarding historical resource preservation. Please let us know when we can be of further service. Thank you for submitting the signed **Access Agreement Short Form.** 

**Note:** Billing will be transmitted separately via email from the Financial Services office\* (\$225.00), payable within 60 days of receipt of the invoice.

If you wish to include payment by Credit Card, you must wait to receive the official invoice from Financial Services so that you can reference the CMP # (Invoice Number), and then contact the link below:

https://commerce.cashnet.com/ANTHROPOLOGY

Sincerely,

E. H. Greathouse

E. A. Greathouse, Coordinator Central California Information Center California Historical Resources Information System

<sup>\*</sup> Invoice Request sent to: ARBilling@csustan.edu, CSU Stanislaus Financial Services