

DEPARTMENT OF PLANNING AND COMMUNITY DEVELOPMENT

1010 10TH Street, Suite 3400, Modesto, CA 95354 Planning Phone: (209) 525-6330 Fax: (209) 525-5911 Building Phone: (209) 525-6557 Fax: (209) 525-7759

Referral Early Consultation

Date: May 20, 2022

To: Distribution List (See Attachment A)

From: Avleen K. Aujla, Assistant Planner. Planning and Community Development

Subject: STAFF APPROVAL APPLICATION NO. PLN2022-0054 – COMPLETE

WIRELESS CONSULTING - BYSTRUM ROAD

Respond By: June 6, 2022

****PLEASE REVIEW REFERRAL PROCESS POLICY****

The Stanislaus County Department of Planning and Community Development is soliciting comments from responsible agencies under the Early Consultation process to determine: a) whether or not the project is subject to CEQA and b) if specific conditions should be placed upon project approval.

Therefore, please contact this office by the response date if you have any comments pertaining to the proposal. Comments made identifying potential impacts should be as specific as possible and should be based on supporting data (e.g., traffic counts, expected pollutant levels, etc.). Your comments should emphasize potential impacts in areas which your agency has expertise and/or jurisdictional responsibilities.

These comments will assist our Department in preparing the conditions for a Staff Approval. Therefore, please list any conditions that you wish to have included as well as any other comments you may have. Please return all comments and/or conditions as soon as possible or no later than the response date referenced above.

Thank you for your cooperation. Please call (209) 525-6330 if you have any questions.

Applicant: New Cingular Wireless PCS, LLC dba AT&T Mobility c/o Complete Wireless

Consulting

Project Location: 6342 Bystrum Road, between East Keyes Road and East Taylor Road, in the

Ceres area.

APN: 041-046-022

Williamson Act

Contract: N/A

General Plan: Agriculture

Current Zoning: Planned Development (PD-355)

Project Description: Request to establish a wireless communications facility on a 119.4± acre parcel in the Planned Development (P-D) (355) zoning district. This proposal includes the installation of a 130-foot-tall monopole and supporting ground equipment on a 576± square-foot fenced compound towards the southern portion of the property. The proposal includes three sectors of five antennas, for a total of 15 antennas, to be mounted at a 126-foot centerline. Proposed ground equipment includes: one 64± foot walk-in equipment cabinet and a 30kw diesel generator with a 190-gallon backup fuel tank on a 50± foot concrete slab. The project lease area will be 576± square feet in size and will be enclosed by a chain link fence to prevent interference with existing operations. The facility will be generally unmanned; however, one technician is anticipated to access the site one day a month for routine maintenance. The site is currently improved with a large commercial wine business, Bronco Wine Company, which was approved by the Board of Supervisors under Rezone and Williamson Act Cancellation Application No. PLN2019-0061 –

Bronco Wine Company, on July 13, 2021. The proposed monopole will meet all applicable siting standards as outlined under County Code Section 21.91.030 – *Siting standards*.

Attachments

A - Maps

B – Project Description

Full document with attachments available for viewing at: http://www.stancounty.com/planning/pl/act-projects.shtm



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STAFF APPROVAL APPLICATION NO. PLN2022-0054 - COMPLETE WIRELESS CONSULTING - BYSTRUM ROAD

Attachment A

Distribution List

Х	CROP DUSTERS		STAN CO ALUC
Х	FIRE PROTECTION DIST: KEYES FIRE	Х	STAN CO BUILDING PERMITS DIVISION
Х	IRRIGATION DIST: TURLOCK IRRIGATION DISTRICT		STAN CO ERC
Х	STAN CO PUBLIC WORKS	Х	STAN CO HAZARDOUS MATERIALS
	STANISLAUS LAFCO	Х	STAN CO SUPERVISOR DIST 2: CHIESA
Х	SURROUNDING LAND OWNERS	Х	STANISLAUS FIRE PREVENTION BUREAU
Х	PACIFIC GAS & ELECTRIC	Х	MOSQUITO ABATEMENT DISTRICT: TURLOCK

STANISLAUS COUNTY CEQA REFERRAL RESPONSE FORM

Stanislaus County Planning & Community Development

TO:

	1010 10 th Street, Modesto, CA 9		
FROM:			
SUBJECT:		OVAL APPLICATION NO. ISULTING - BYSTRUM ROAD	PLN2022-0054 - COMPLETE
Based on thi	s agency's particu	ılar field(s) of expertise, it is o	our position the above described
		ignificant effect on the environn ificant effect on the environmen	
		ts which support our determina etc.) – (attach additional sheet if	tion (e.g., traffic general, carrying f necessary)
TO INCLUDE	E WHEN THE MI		sted impacts: PLEASE BE SURE NEEDS TO BE IMPLEMENTED A BUILDING PERMIT, ETC.):
In addition, ou	ur agency has the f	following comments (attach add	ditional sheets if necessary).
Response pre	epared by:		
Name		Title	Date

COMPLETE WIRELESS CONSULTING

SAA PLN2022-0054

AREA MAP

LEGEND


Project Site

Sphere of Influence

City

Road

River

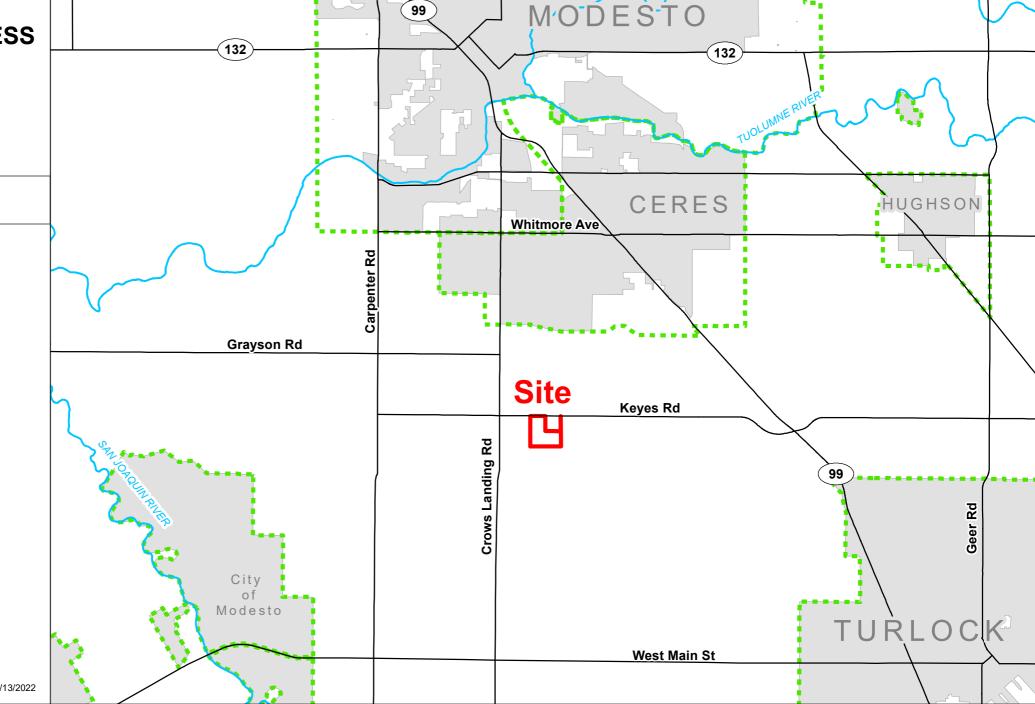

Source: Planning Department GIS

Date: 5/13/2022




COMPLETE WIRELESS CONSULTING

SAA PLN2022-0054

ZONING MAP



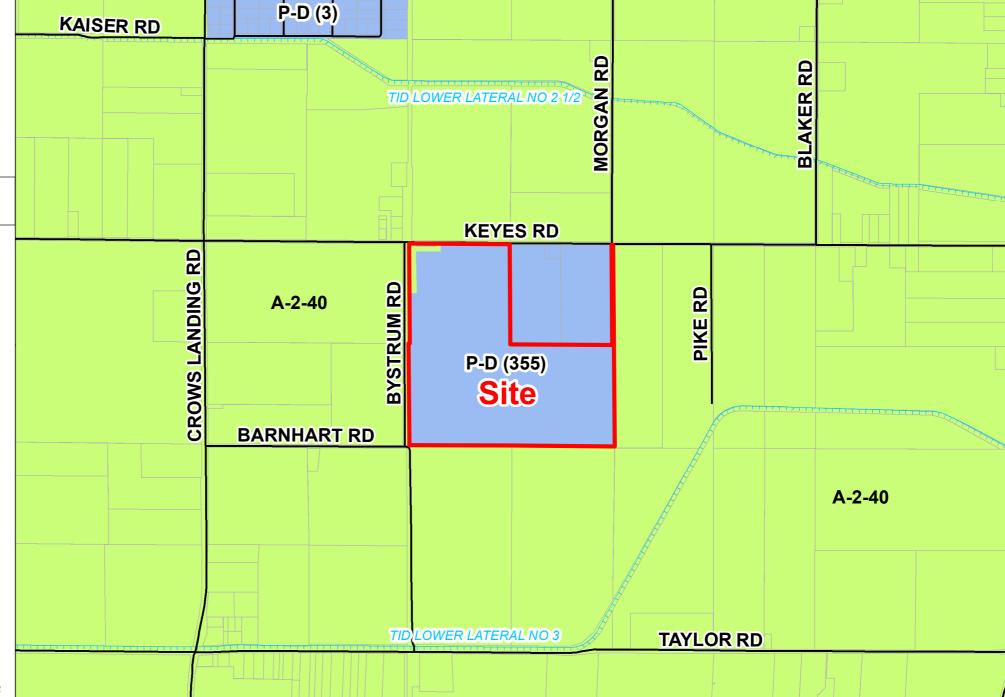

Source: Planning Department GIS

Date: 5/13/2022

1,500 ft

COMPLETE WIRELESS CONSULTING

SAA PLN2022-0054

2021 AERIAL AREA MAP


LEGEND


Project Site

— Road

····· Can

Canal

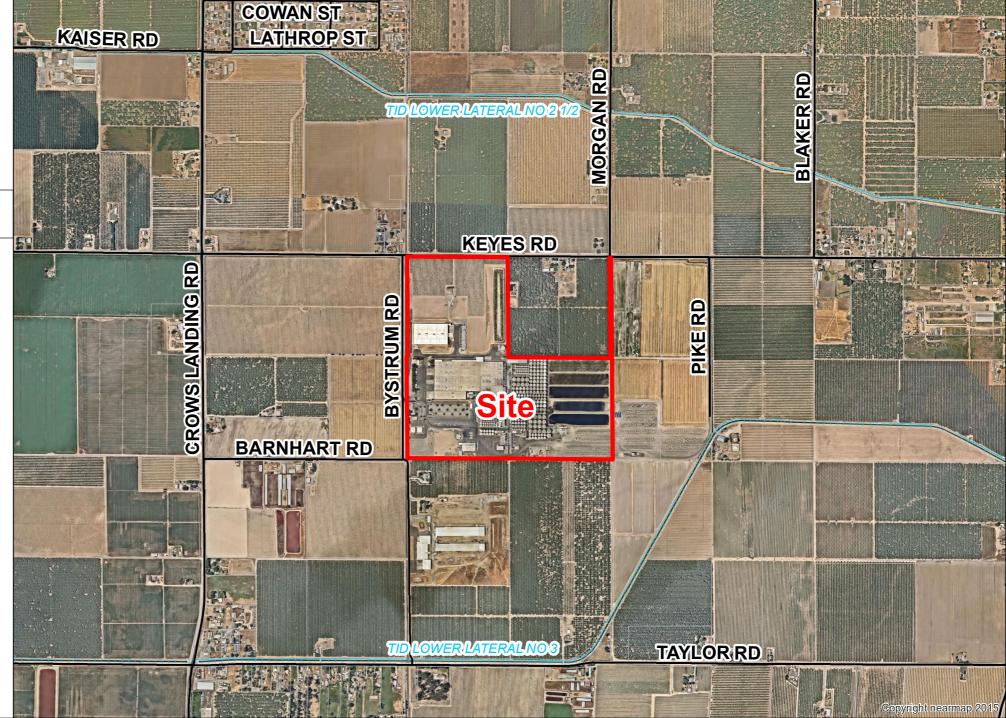

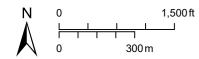

Source: Planning Department GIS

Date: 5/13/2022

COMPLETE WIRELESS CONSULTING

SAA PLN2022-0054

2021 AERIAL SITE MAP

LEGEND

Project Site


Road

Canal





Source: Planning Department GIS Date: 5/13/2022

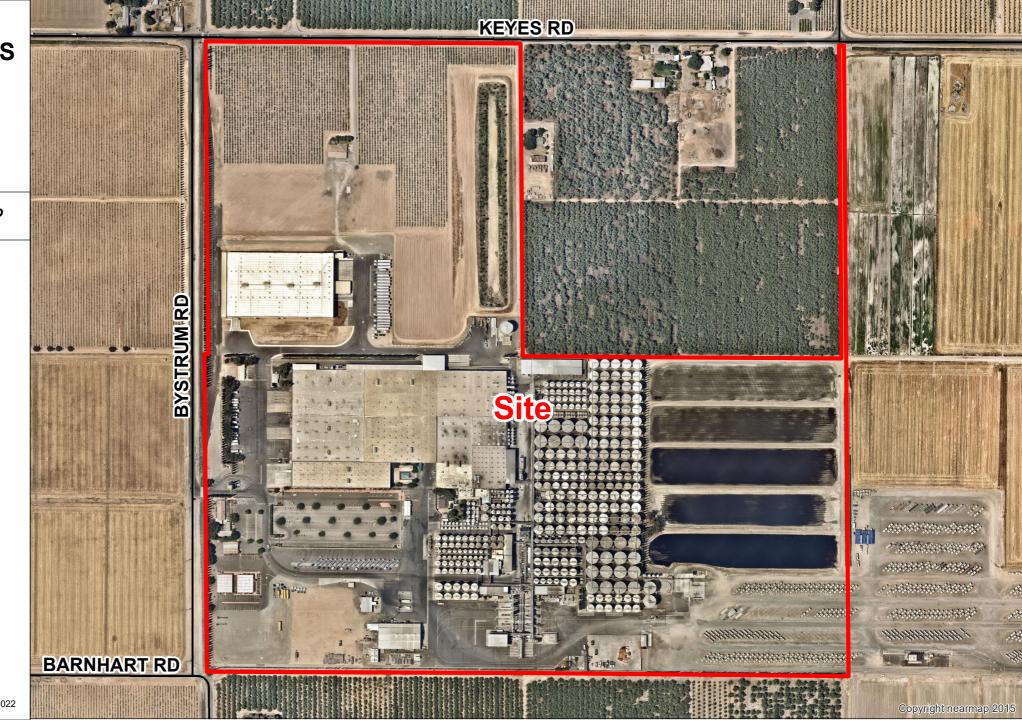



FA CODE: 14638055 USID#: 312502

PACE#: MRSFR050496

CERES, CA

11B-202.4 EXCEPTION 7.


SITE NUMBER: CVL06197

SITE NAME: BRONCO WINE CO

6342 BYSTRUM ROAD **CERES, CA 96307 JURISDICTION: STANISLAUS COUNTY** APN: 041-046-021

SITE TYPE: OUTDOOR EQUIPMENT CABINETS / MONOPOLE

MATERIAL ORDERS OR BE RESPONSIBLE FOR THE SAME.

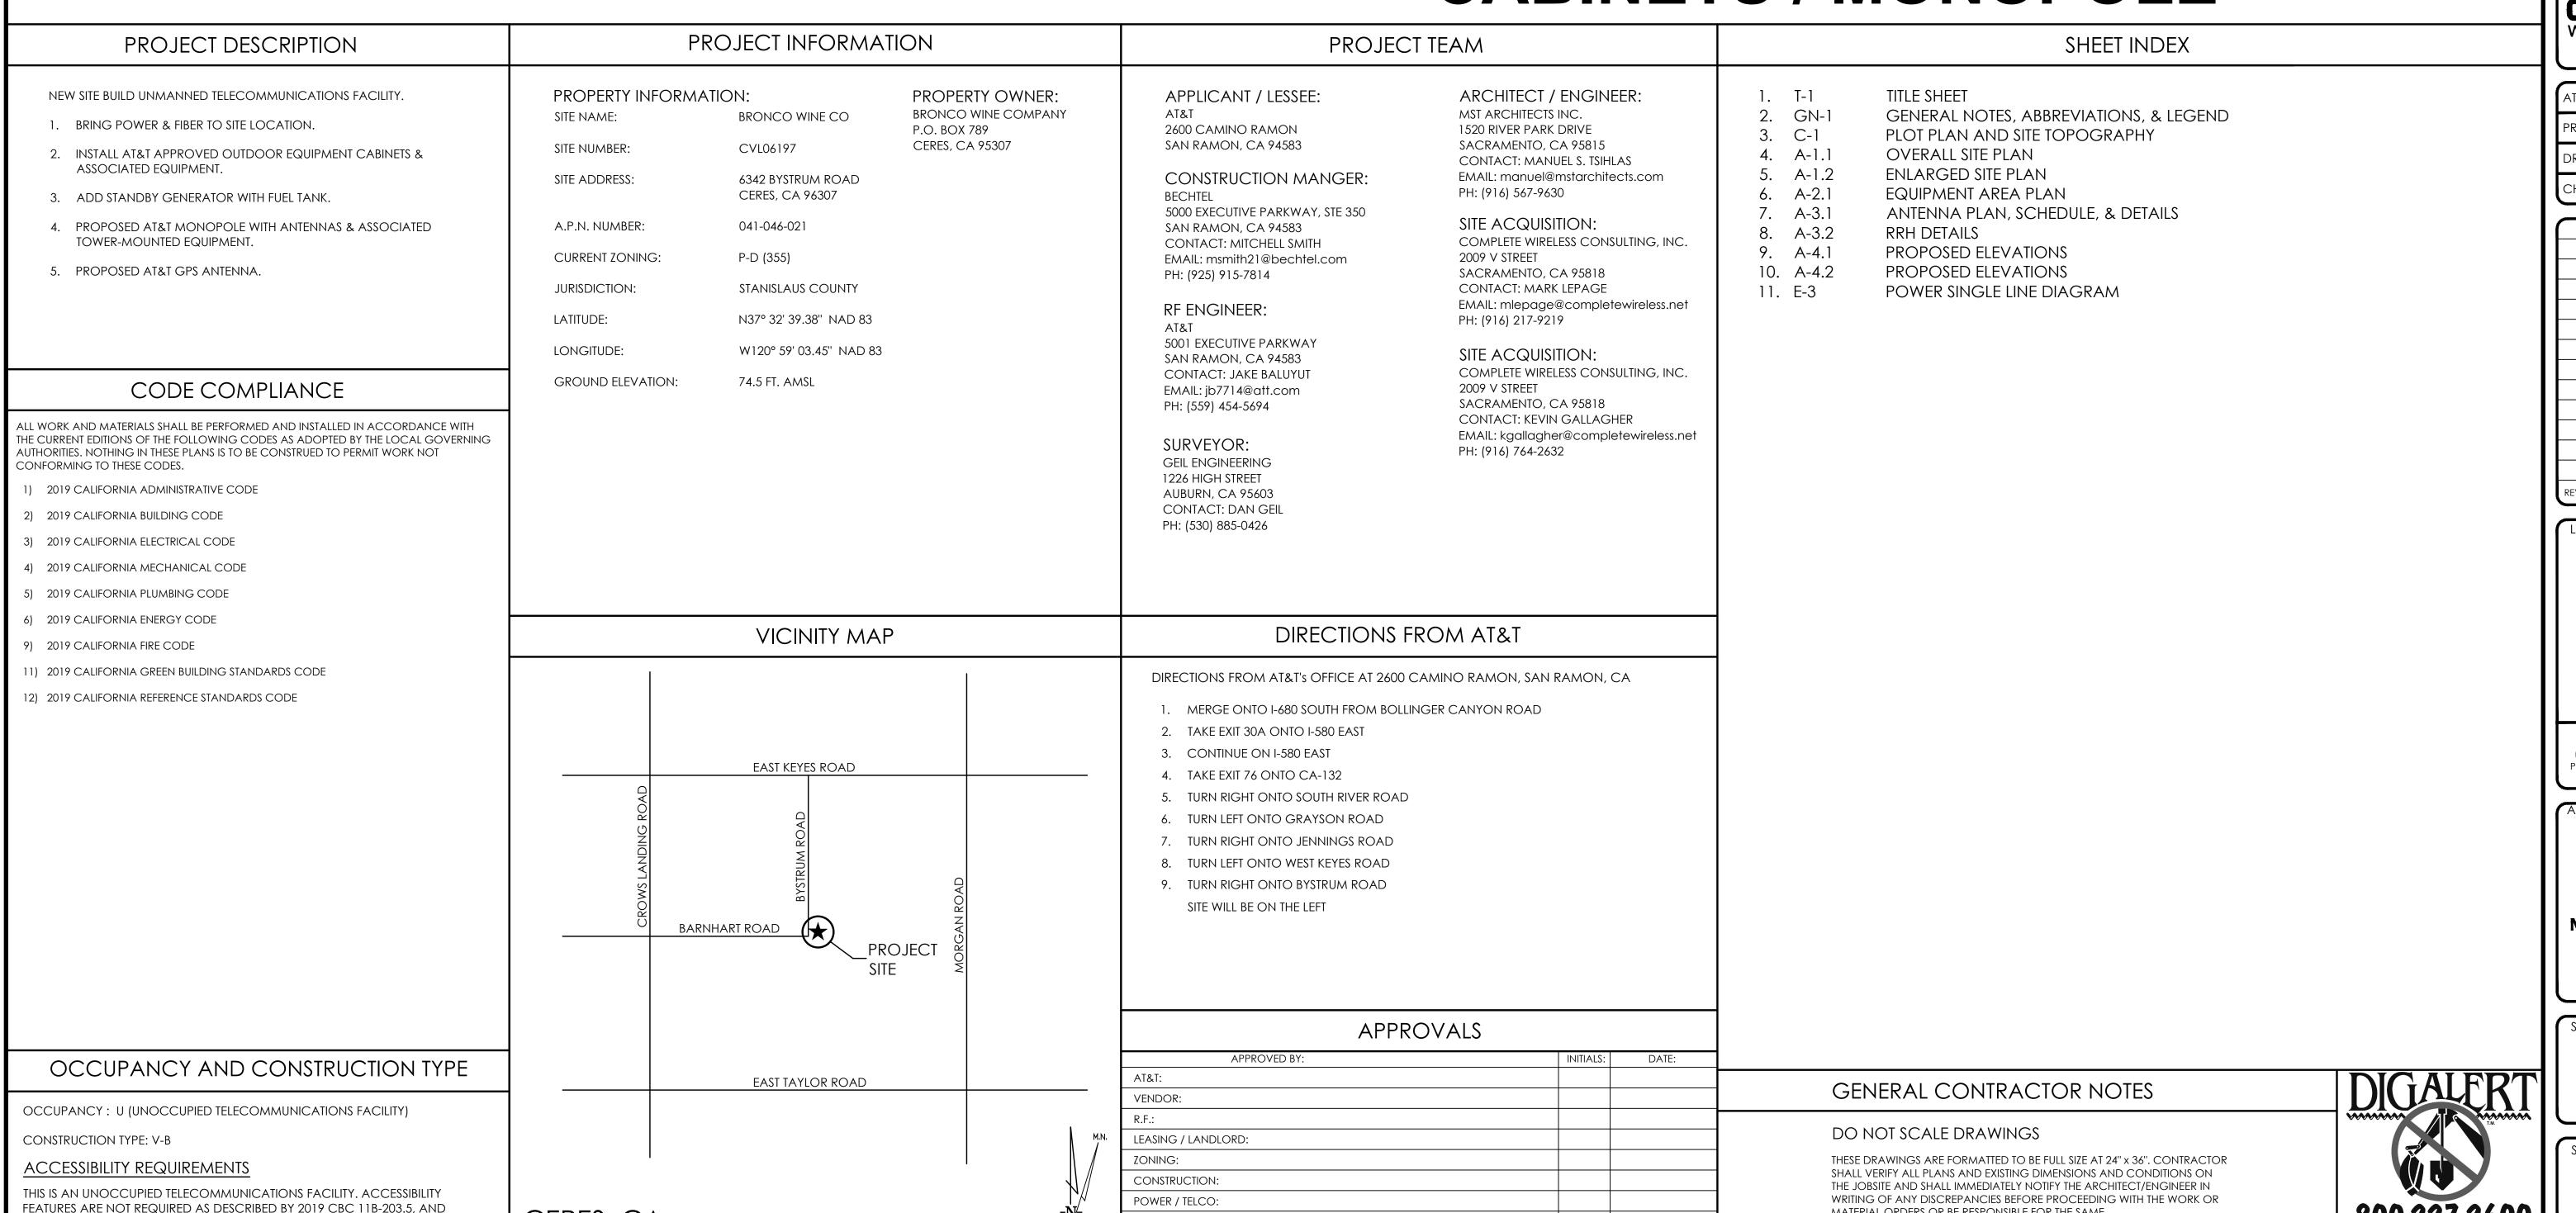

PG&E:

CVL06197 **BRONCO** WINE CO

6342 BYSTRUM ROAD CERES, CA 96307





AT&T SITE NO: CVL06197 PROJECT NO: 162.2820

DRAWN BY: TLS

CHECKED BY: TST

01/05/22 | 100% ZD 12/02/21 90% ZD REV DATE DESCRIPTION

Licensee:

IT IS A VIOLATION OF LAW FOR ANY PERSON, UNLESS THEY ARE ACTING UNDER THE DIRECTION OF A LICENSED PROFESSIONAL ENGINEER, TO ALTER THIS



MST ARCHITECTS 1520 River Park Drive Sacramento, California 95815

SHEET TITLE:

TITLE SHEET

SHEET NUMBER:

GENERAL CONSTRUCTION NOTES:

- PLANS ARE INTENDED TO BE DIAGRAMMATIC OUTLINE ONLY, UNLESS NOTED OTHERWISE. THE WORK SHALL INCLUDE FURNISHING MATERIALS, EQUIPMENT, APPURTENANCES AND LABOR NECESSARY TO COMPLETE ALL INSTALLATIONS AS INDICATED ON THE DRAWINGS.
- 2. THE CONTRACTOR SHALL OBTAIN, IN WRITING, AUTHORIZATION TO PROCEED BEFORE STARTING WORK ON ANY ITEM NOT CLEARLY DEFINED OR IDENTIFIED BY THE CONTRACT DOCUMENTS.
- 3. CONTRACTOR SHALL CONTACT USA (UNDERGROUND SERVICE ALERT) AT (800) 227-2600, FOR UTILITY LOCATIONS, 48 HOURS BEFORE PROCEEDING WITH ANY EXCAVATION, SITE WORK OR CONSTRUCTION.
- 4. THE CONTRACTOR SHALL INSTALL ALL EQUIPMENT AND MATERIALS IN ACCORDANCE WITH MANUFACTURER'S RECOMMENDATIONS UNLESS SPECIFICALLY INDICATED OTHERWISE, OR WHERE LOCAL CODES OR REGULATIONS TAKE PRECEDENCE.
- 5. ALL CONSTRUCTION SHALL BE IN ACCORDANCE WITH THE CBC / UBC'S REQUIREMENTS REGARDING EARTHQUAKE RESISTANCE, FOR, BUT NOT LIMITED TO, PIPING, LIGHT FIXTURES, CEILING GRID, INTERIOR PARTITIONS, AND MECHANICAL EQUIPMENT. ALL WORK MUST COMPLY WITH LOCAL EARTHQUAKE CODES AND REGULATIONS.
- 6. REPRESENTATIONS OF TRUE NORTH, OTHER THAN THOSE FOUND ON THE PLOT OF SURVEY DRAWINGS, SHALL NOT BE USED TO IDENTIFY OR ESTABLISH BEARING OF TRUE NORTH AT THE SITE. THE CONTRACTOR SHALL RELY SOLELY ON THE PLOT OF SURVEY DRAWING AND ANY SURVEYOR'S MARKINGS AT THE SITE FOR THE ESTABLISHMENT OF TRUE NORTH, AND SHALL NOTIFY THE ARCHITECT / ENGINEER PRIOR TO PROCEEDING WITH THE WORK IF ANY DISCREPANCY IS FOUND BETWEEN THE VARIOUS ELEMENTS OF THE WORKING DRAWINGS AND THE TRUE NORTH ORIENTATION AS DEPICTED ON THE CIVIL SURVEY. THE CONTRACTOR SHALL ASSUME SOLE LIABILITY FOR ANY FAILURE TO NOTIFY THE ARCHITECT / ENGINEER.
- 7. THE BUILDING DEPARTMENT ISSUING THE PERMITS SHALL BE NOTIFIED AT LEAST TWO WORKING DAYS PRIOR TO THE COMMENCEMENT OF WORK, OR AS OTHERWISE STIPULATED BY THE CODE ENFORCEMENT OFFICIAL HAVING JURISDICTION.
- 8. DO NOT EXCAVATE OR DISTURB BEYOND THE PROPERTY LINES OR LEASE LINES, UNLESS OTHERWISE NOTED.
- ALL EXISTING UTILITIES, FACILITIES, CONDITIONS, AND THEIR DIMENSIONS SHOWN ON THE PLAN HAVE BEEN PLOTTED FROM AVAILABLE RECORDS. THE ARCHITECT / ENGINEER AND THE OWNER ASSUME NO RESPONSIBILITY WHATSOEVER AS TO THE SUFFICIENCY OR THE ACCURACY OF THE INFORMATION SHOWN ON THE PLANS, OR THE MANNER OF THEIR REMOVAL OR ADJUSTMENT. CONTRACTORS SHALL BE RESPONSIBLE FOR DETERMINING EXACT LOCATION OF ALL EXISTING UTILITIES AND FACILITIES PRIOR TO START OF CONSTRUCTION. CONTRACTORS SHALL ALSO OBTAIN FROM EACH UTILITY COMPANY DETAILED INFORMATION RELATIVE TO WORKING SCHEDULES AND METHODS OF REMOVING OR ADJUSTING EXISTING UTILITIES.
- 10. CONTRACTOR SHALL VERIFY ALL EXISTING UTILITIES, BOTH HORIZONTAL AND VERTICALLY, PRIOR TO THE START OF CONSTRUCTION. ANY DISCREPANCIES OR DOUBTS AS TO THE INTERPRETATION OF PLANS SHOULD BE IMMEDIATELY REPORTED TO THE ARCHITECT / ENGINEER FOR RESOLUTION AND INSTRUCTION, AND NO FURTHER WORK SHALL BE PERFORMED UNTIL THE DISCREPANCY IS CHECKED AND CORRECTED BY THE ARCHITECT / ENGINEER. FAILURE TO SECURE SUCH INSTRUCTION MEANS CONTRACTOR WILL HAVE WORKED AT HIS/HER OWN RISK AND EXPENSE.
- 11. ALL NEW AND EXISTING UTILITY STRUCTURES ON SITE AND IN AREAS TO BE DISTURBED BY CONSTRUCTION SHALL BE ADJUSTED TO FINISH ELEVATIONS PRIOR TO FINAL INSPECTION OF WORK.
- 12. ANY DRAIN AND/OR FIELD TILE ENCOUNTERED / DISTURBED DURING CONSTRUCTION SHALL BE RETURNED TO IT'S ORIGINAL CONDITION PRIOR TO COMPLETION OF WORK. SIZE, LOCATION AND TYPE OF ANY UNDERGROUND UTILITIES OR IMPROVEMENTS SHALL BE ACCURATELY NOTED AND PLACED ON "AS-BUILT" DRAWINGS BY GENERAL CONTRACTOR, AND ISSUED TO THE ARCHITECT / ENGINEER AT COMPLETION OF PROJECT.
- 13. ALL TEMPORARY EXCAVATIONS FOR THE INSTALLATION OF FOUNDATIONS, UTILITIES, ETC., SHALL BE PROPERLY LAID BACK OR BRACED IN ACCORDANCE WITH CORRECT OCCUPATIONAL SAFETY AND HEALTH ADMINISTRATION (OSHA) REQUIREMENTS.
- 14. INCLUDE MISC. ITEMS PER AT&T SPECIFICATIONS

APPLICABLE CODES, REGULATIONS AND STANDARDS:

SUBCONTRACTOR'S WORK SHALL COMPLY WITH ALL APPLICABLE NATIONAL, STATE, AND LOCAL CODES AS ADOPTED BY THE LOCAL AUTHORITY HAVING JURISDICTION (AHJ) FOR THE LOCATION.

THE EDITION OF THE AHJ ADOPTED CODES AND STANDARDS IN EFFECT ON THE DATE OF CONTRACT AWARD SHALL GOVERN THE DESIGN.

SUBCONTRACTOR'S WORK SHALL COMPLY WITH THE LATEST EDITION OF THE FOLLOWING STANDARDS:

- AMERICAN CONCRETE INSTITUTE (ACI) 318, BUILDING CODE REQUIREMENTS FOR STRUCTURAL CONCRETE
- AMERICAN INSTITUTE OF STEEL CONSTRUCTION (AISC), MANUAL OF STEEL CONSTRUCTION, ASD, 15TH EDITION
- TELECOMMUNICATIONS INDUSTRY ASSOCIATION (TIA) 222-H, STRUCTURAL STANDARD FOR STRUCTURAL ANTENNA TOWER AND ANTENNA SUPPORTING STRUCTURES
- INSTITUTE FOR ELECTRICAL AND ELECTRONICS ENGINEERS (IEEE) 81, GUIDE FOR MEASURING EARTH RESISTIVITY, GROUND IMPEDANCE, AND EARTH SURFACE POTENTIALS OF A GROUND SYSTEM IEEE 1100 (1999) RECOMMENDED PRACTICE FOR POWERING AND GROUNDING OF ELECTRICAL EQUIPMENT.
- -IEEE C62.41, RECOMMENDED PRACTICES ON SURGE VOLTAGES IN LOW VOLTAGE AC POWER CIRCUITS (FOR LOCATION CATEGORY "C3" AND "HIGH SYSTEM EXPOSURE")
- TIA 607 COMMERCIAL BUILDING GROUNDING AND BONDING REQUIREMENTS FOR TELECOMMUNICATIONS TELCORDIA GR-63 NETWORK
- EQUIPMENT-BUILDING SYSTEM (NEBS): PHYSICAL PROTECTION TELCORDIA GR-347 CENTRAL OFFICE POWER WIRING
- TELCORDIA GR-1275 GENERAL INSTALLATION REQUIREMENTS
- TELCORDIA GR-1503 COAXIAL CABLE CONNECTIONS

ANY AND ALL OTHER LOCAL & STATE LAWS AND REGULATIONS

FOR ANY CONFLICTS BETWEEN SECTIONS OF LISTED CODES AND STANDARDS REGARDING MATERIAL, METHODS OF CONSTRUCTION, OR OTHER REQUIREMENTS, THE MOST RESTRICTIVE SHALL GOVERN. WHERE THERE IS CONFLICT BETWEEN A GENERAL REQUIREMENT AND A SPECIFIC REQUIREMENT, THE SPECIFIC REQUIREMENT SHALL GOVERN.

ABBREVIATIONS A.B. **ANCHOR BOLT** IN. (") INCH(ES) ABV. INTERIOR ANTENNA CABLE COVER ASSEMBLY ACCA POUND(S) ADD'L ADDITIONAL LAG BOLTS ABOVE FINISHED FLOOR LINEAR FEET (FOOT **ABOVE FINISHED GRADE** LONG(ITUDINAL) ALUM. ALUMINUM MASONRY ALTERNATE MAXIMUM ANT. ANTENNA M.B. MACHINE BOLT APPROXIMATE(LY) APPRX. **MECHANICAL** ARCH. ARCHITECT(URAL) MANUFACTURER AMERICAN WIRE GAUGE AWG. MINIMUM BLDG. BUILDING MISCELLANEOUS BLOCK BLK. METAL BLKG. BLOCKING NEW NUMBER B.N. **BOUNDARY NAILING** NOT TO SCALE N.T.S. BTCW. BARE TINNED COPPER WIRE O.C. ON CENTER B.O.F. **BOTTOM OF FOOTING** OPNG. OPENING **BACK-UP CABINET** B/U PRECAST CONCRETE CAB. PCS PERSONAL COMMUNICATION SERVICES CANTILEVER(ED PLYWOOD C.I.P. **CAST IN PLACE** POWER PROTECTION CABINET CLG. CEILING PRIMARY RADIO CABINET CLR. CLEAR P.S.F. POUNDS PER SQUARE FOOT COL. COLUMN P.S.I. POUNDS PER SQUARE INCH CONC. CONCRETE PRESSURE TREATED CONN. CONNECTION(OR) PWR. POWER (CABINET) CONST. CONSTRUCTION QUANTITY CONT. CONTINUOUS RAD.(R) **RADIUS** PENNY (NAILS) REFERENCE DOUBLE DBL. REINFORCEMENT(ING) DEPT. DEPARTMENT REQUIRED DOUGLAS FIR RIGID GALVANIZED STEEL DIA. DIAMETER SCH. SCHEDULE DIAG. DIAGONAL SHEET DIM. **DIMENSION** SIMILAR DWG. **DRAWING(S SPECIFICATIONS** DWL. DOWEL(S) SQUARE STAINLESS STEE **ELEVATION** STANDARD **ELECTRICAL ELEVATOR** STRUCTURAL ELECTRICAL METALLIC TUBING **TEMPORARY** TEMP. E.N. **EDGE NAIL** THICK(NESS) ENG. **ENGINEER** TOE NAIL EQ. EQUAL TOP OF ANTENNA EXP. **EXPANSION** T.O.C. TOP OF CURB EXST.(E) EXISTING TOP OF FOUNDATION **EXTERIOR** T.O.P. TOP OF PLATE (PARAPET) FAB. FABRICATION(OR) T.O.S. TOP OF STEEL F.F. FINISH FLOOR T.O.W. TOP OF WALL F.G. FINISH GRADE TYPICAL FINISH(ED) **UNDER GROUND** FLR. FLOOR UNDERWRITERS LABORATORY FDN. **FOUNDATION** UNLESS NOTED OTHERWISE F.O.C. FACE OF CONCRETE VERIFY IN FIELD F.O.M. FACE OF MASONRY WIDE (WIDTH) F.O.S. FACE OF STUD WITH F.O.W. FACE OF WALL WOOD F.S. FINISH SURFACE WEATHERPROOF FT.(') FOOT (FEET) WEIGHT **FOOTING** CENTERLINE **GROWTH (CABINET** PLATE, PROPERTY LINE GAUGE GALVANIZE(D) GROUND FAULT CIRCUIT INTERRUPTER GLUE LAMINATED BEAM GLB. (GLU-LAM) GLOBAL POSITIONING SYSTEM GRND. **GROUND** HEADER HDR. **HANGER** HGR. ISOLATED COPPER GROUND BUS SYMBOLS LEGEND **GROUT OR PLASTER** (E) BRICK BLDG. SECTION (E) MASONRY **WALL SECTION** CONCRETE EARTH GRAVEL **PLYWOOD** Sand **ELEVATION PLYWOOD** SAND (E) STEEL DOOR SYMBOL MATCH LINE WINDOW SYMBOL GROUND CONDUCTOR **OVERHEAD SERVICE CONDUCTORS** TILT-UP PANEL MARK TELEPHONE CONDUIT PROPERTY LINE POWER CONDUIT COAXIAL CABLE — ELEVATION DATUM CHAIN LINK FENCE **WOOD FENCE** GRID/COLUMN LINE (P) ANTENNA DIMENSION ITEM (P) RRU

KEYNOTE,

OFFICE

CONSTRUCTION ITEM

WALL TYPE MARK

ROOM NAME

ROOM NUMBER

(P) DC SURGE SUPRESSION

(F) ANTENNA

(E) EQUIPMENT

(F) RRU

CVL06197
BRONCO
WINE CO

6342 BYSTRUM ROAD CERES, CA 96307



San Ramon, California 94583

andar:



AT&T SITE NO: CVL06197

PROJECT NO: 162.2820

DRAWN BY: TLS

CHECKED BY: TST

REV DATE

Licensee:

01/05/22 100% ZD 12/02/21 90% ZD

DESCRIPTION


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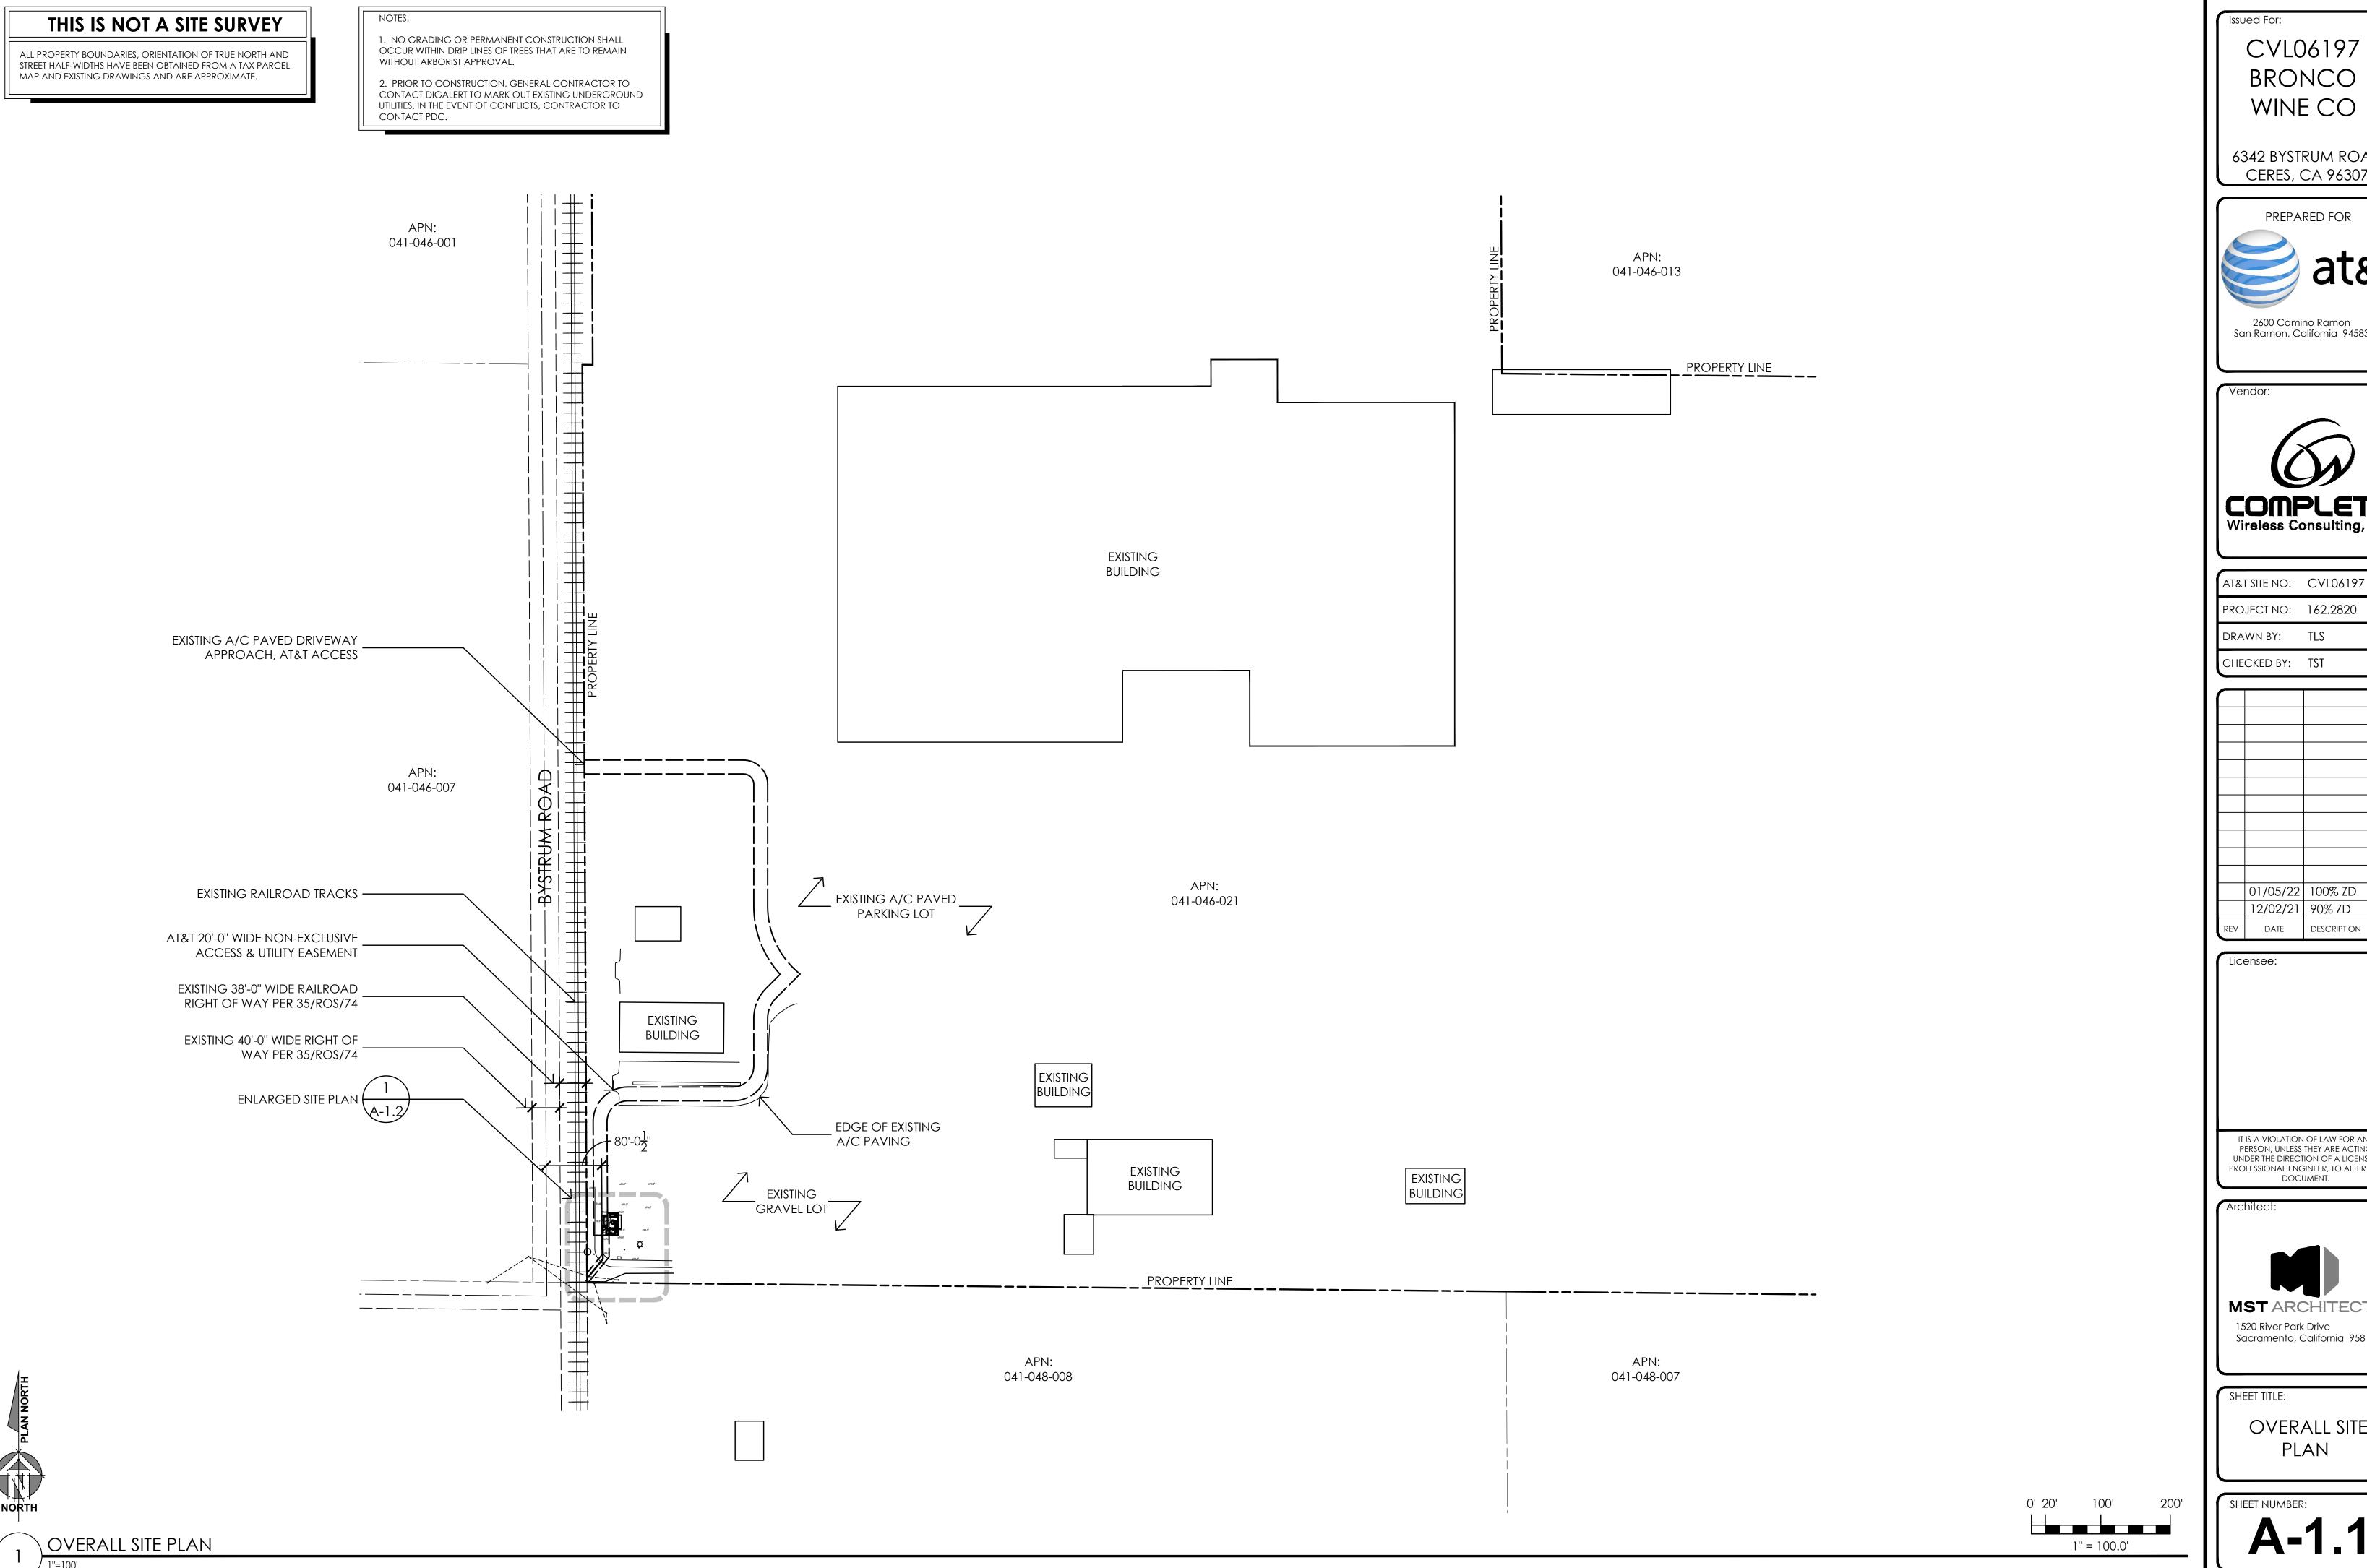


MST ARCHITECTS
1520 River Park Drive
Sacramento, California 95815

GENERAL NOTES,
ABBREVIATIONS, &
LEGEND

SHEET NUMBER:



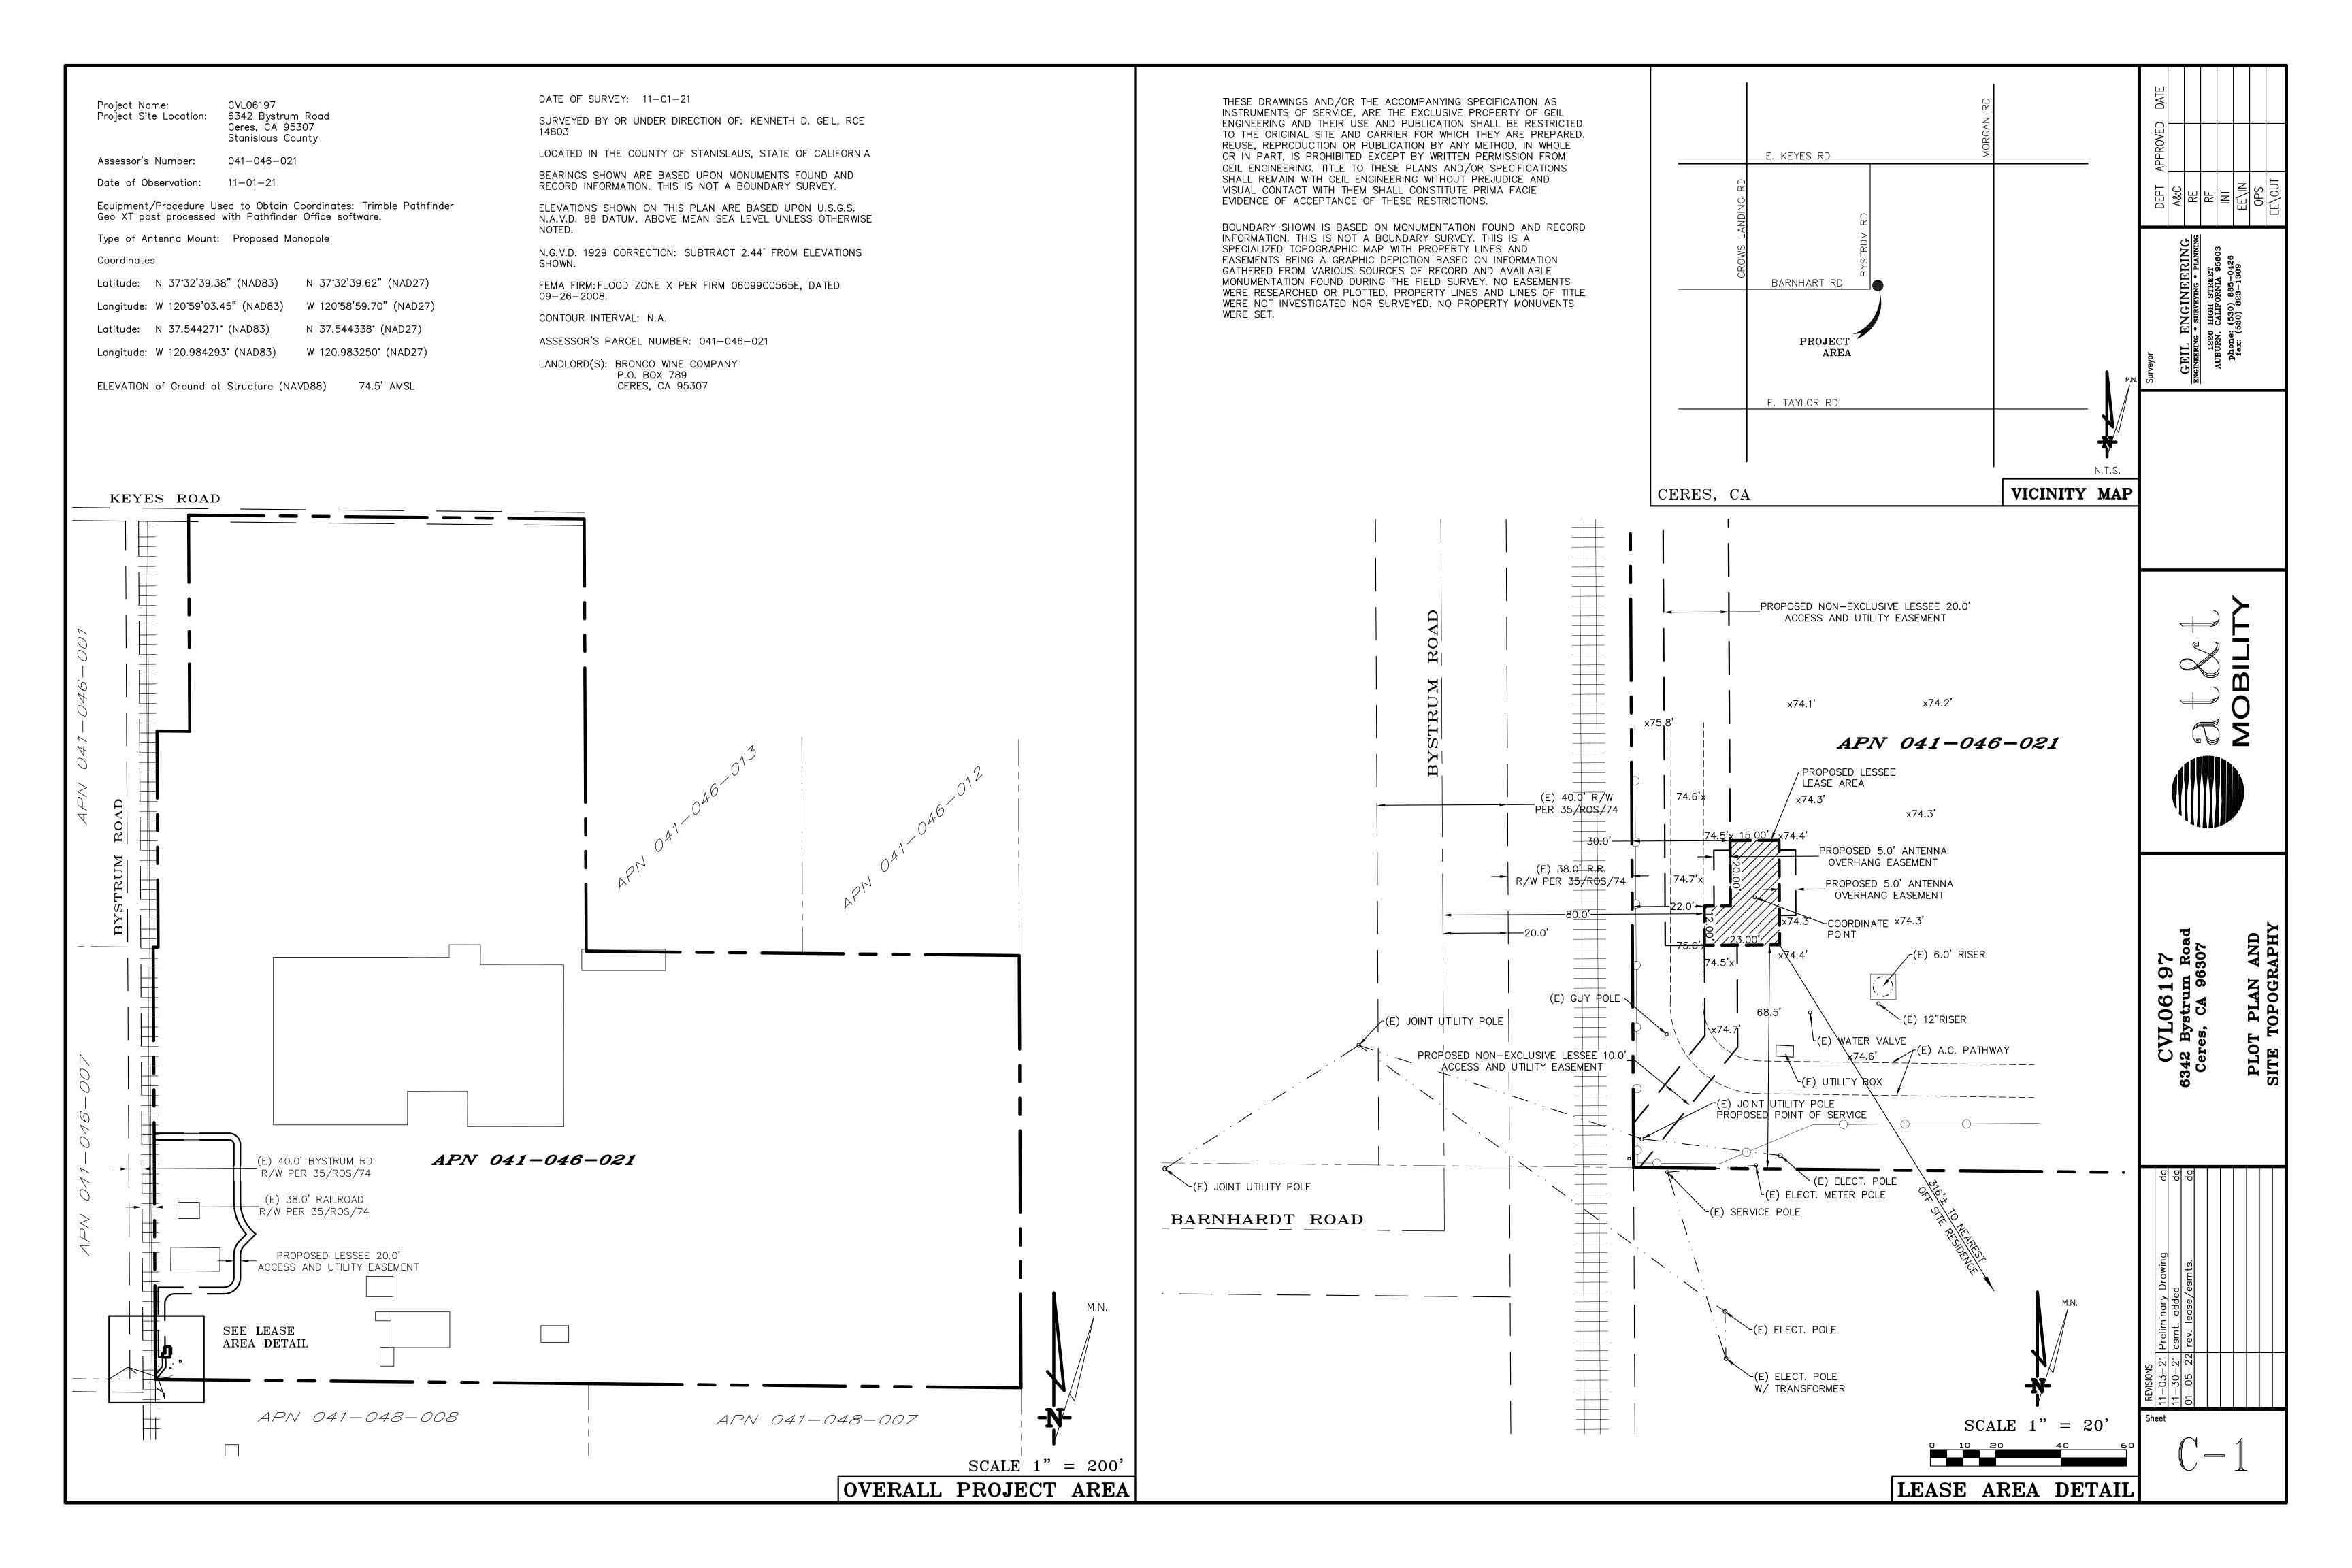

CVL06197 BRONCO WINE CO

6342 BYSTRUM ROAD CERES, CA 96307



2600 Camino Ramon San Ramon, California 94583



AT&T SITE NO: CVL06197 PROJECT NO: 162.2820

CHECKED BY: TST

01/05/22 100% ZD 12/02/21 90% ZD

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MST ARCHITECTS 1520 River Park Drive Sacramento, California 95815

SHEET TITLE:

OVERALL SITE PLAN

SHEET NUMBER:

NOTES:

 NO GRADING OR PERMANENT CONSTRUCTION SHALL OCCUR WITHIN DRIP LINES OF TREES THAT ARE TO REMAIN WITHOUT ARBORIST APPROVAL.

2. PRIOR TO CONSTRUCTION, GENERAL CONTRACTOR TO CONTACT DIGALERT TO MARK OUT EXISTING UNDERGROUND UTILITIES. IN THE EVENT OF CONFLICTS, CONTRACTOR TO CONTACT PDC.

EQUIPMENT AREA PLAN AT&T 20'-0" WIDE NON-EXCLUSIVE ACCESS & UTILITY EASEMENT ×74.3' ×74.3' EXISTING RAILROAD TRACKS — ×74.3' - EXISTING WATER VALVE EXISTING A/C PAVED DRIVEWAY, AT&T ACCESS — EXISTING 6'-0" RISER EXISTING GUYED UTILITY POLE — EXISTING CHAIN LINK FENCE W/ BARBED WIRE AT&T 10'-0" WIDE NON-EXCLUSIVE ACCESS & UTILITY EASEMENT PROPOSED AT&T UNDERGROUND POWER (±80'-0") PROPOSED AT&T UNDERGROUND — EXISTING 12" RISER FIBER (±80'-0") ×74.6' EXISTING JOINT UTILITY POLE, PROPOSED AT&T POWER & FIBER P.O.F. - EXISTING UTILITY BOX PROPERTY LINE _--__-- EXISTING ELECTRICAL POLE CVL06197
BRONCO
WINE CO

6342 BYSTRUM ROAD CERES, CA 96307





AT&T SITE NO: CVL06197

PROJECT NO: 162.2820

DRAWN BY: TLS

CHECKED BY: TST

	01/05/22	100% ZD
	12/02/21	90% ZD
REV	DATE	DESCRIPTION

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Architec



1520 River Park Drive Sacramento, California 95815

SHEET TITLE:

EXISTING ELECTRICAL METER

ENLARGED SITE PLAN


SHEET NUMBER:


0' 2'

1'' = 10.0'

A-1.2



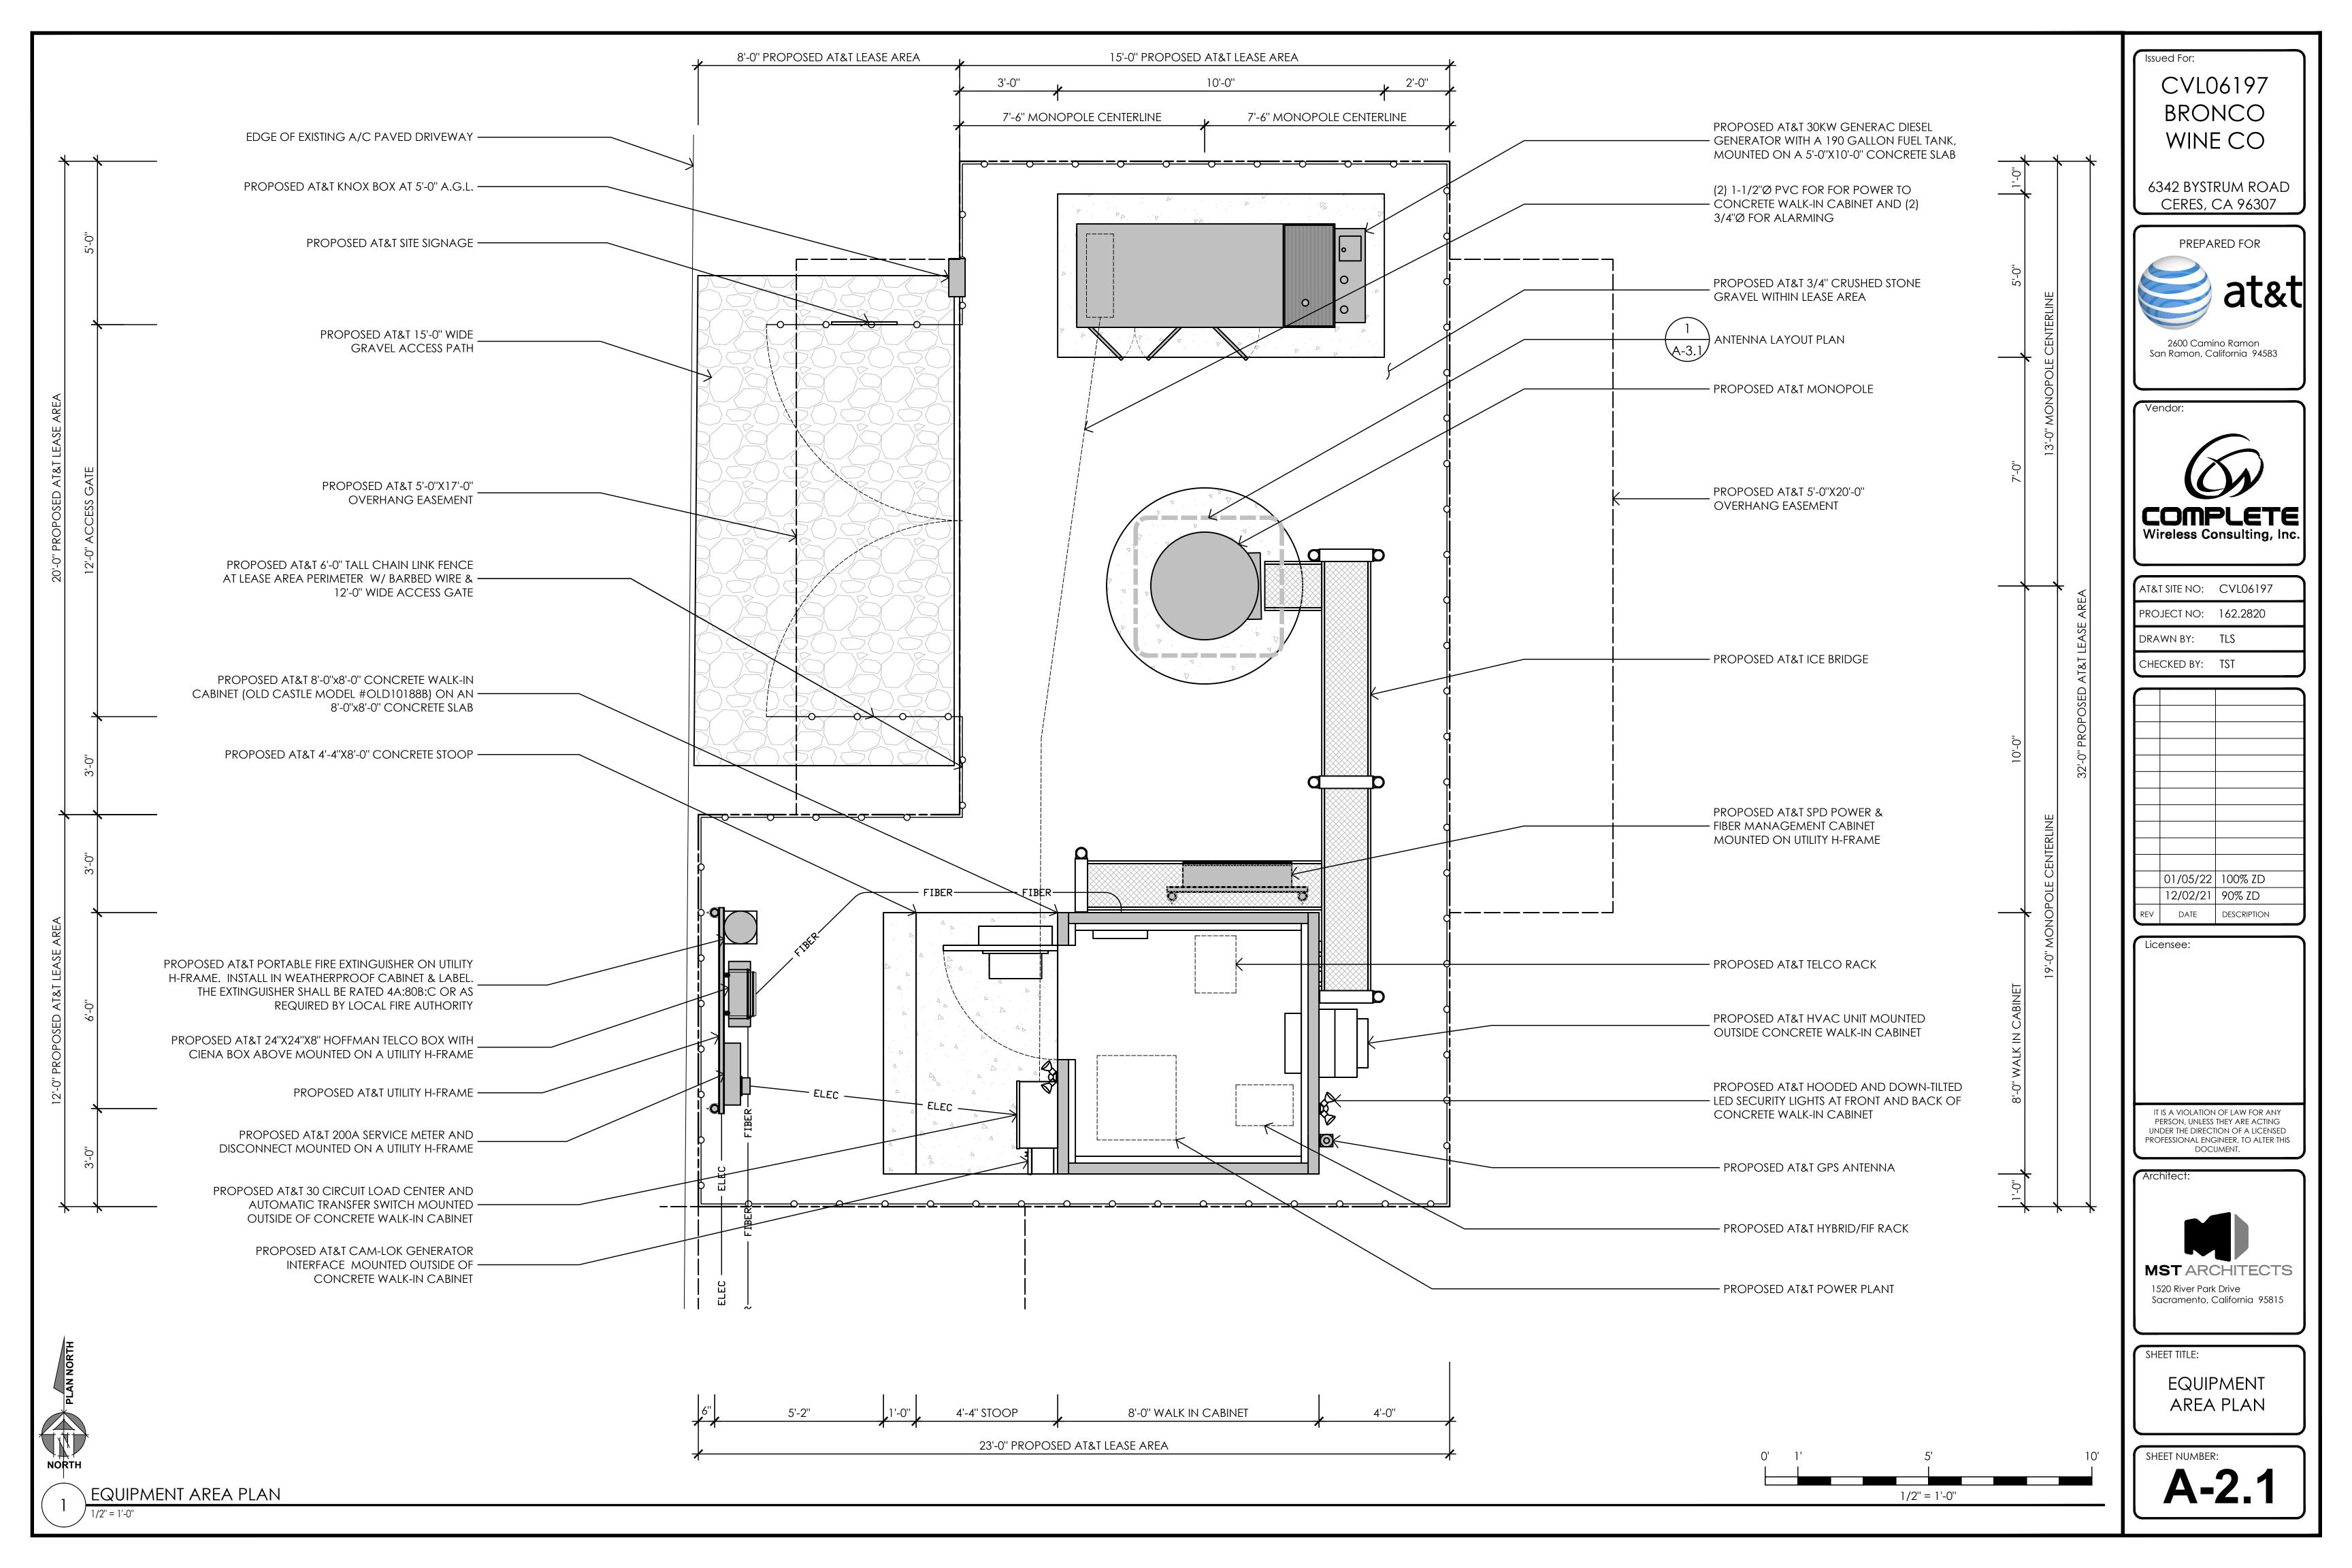

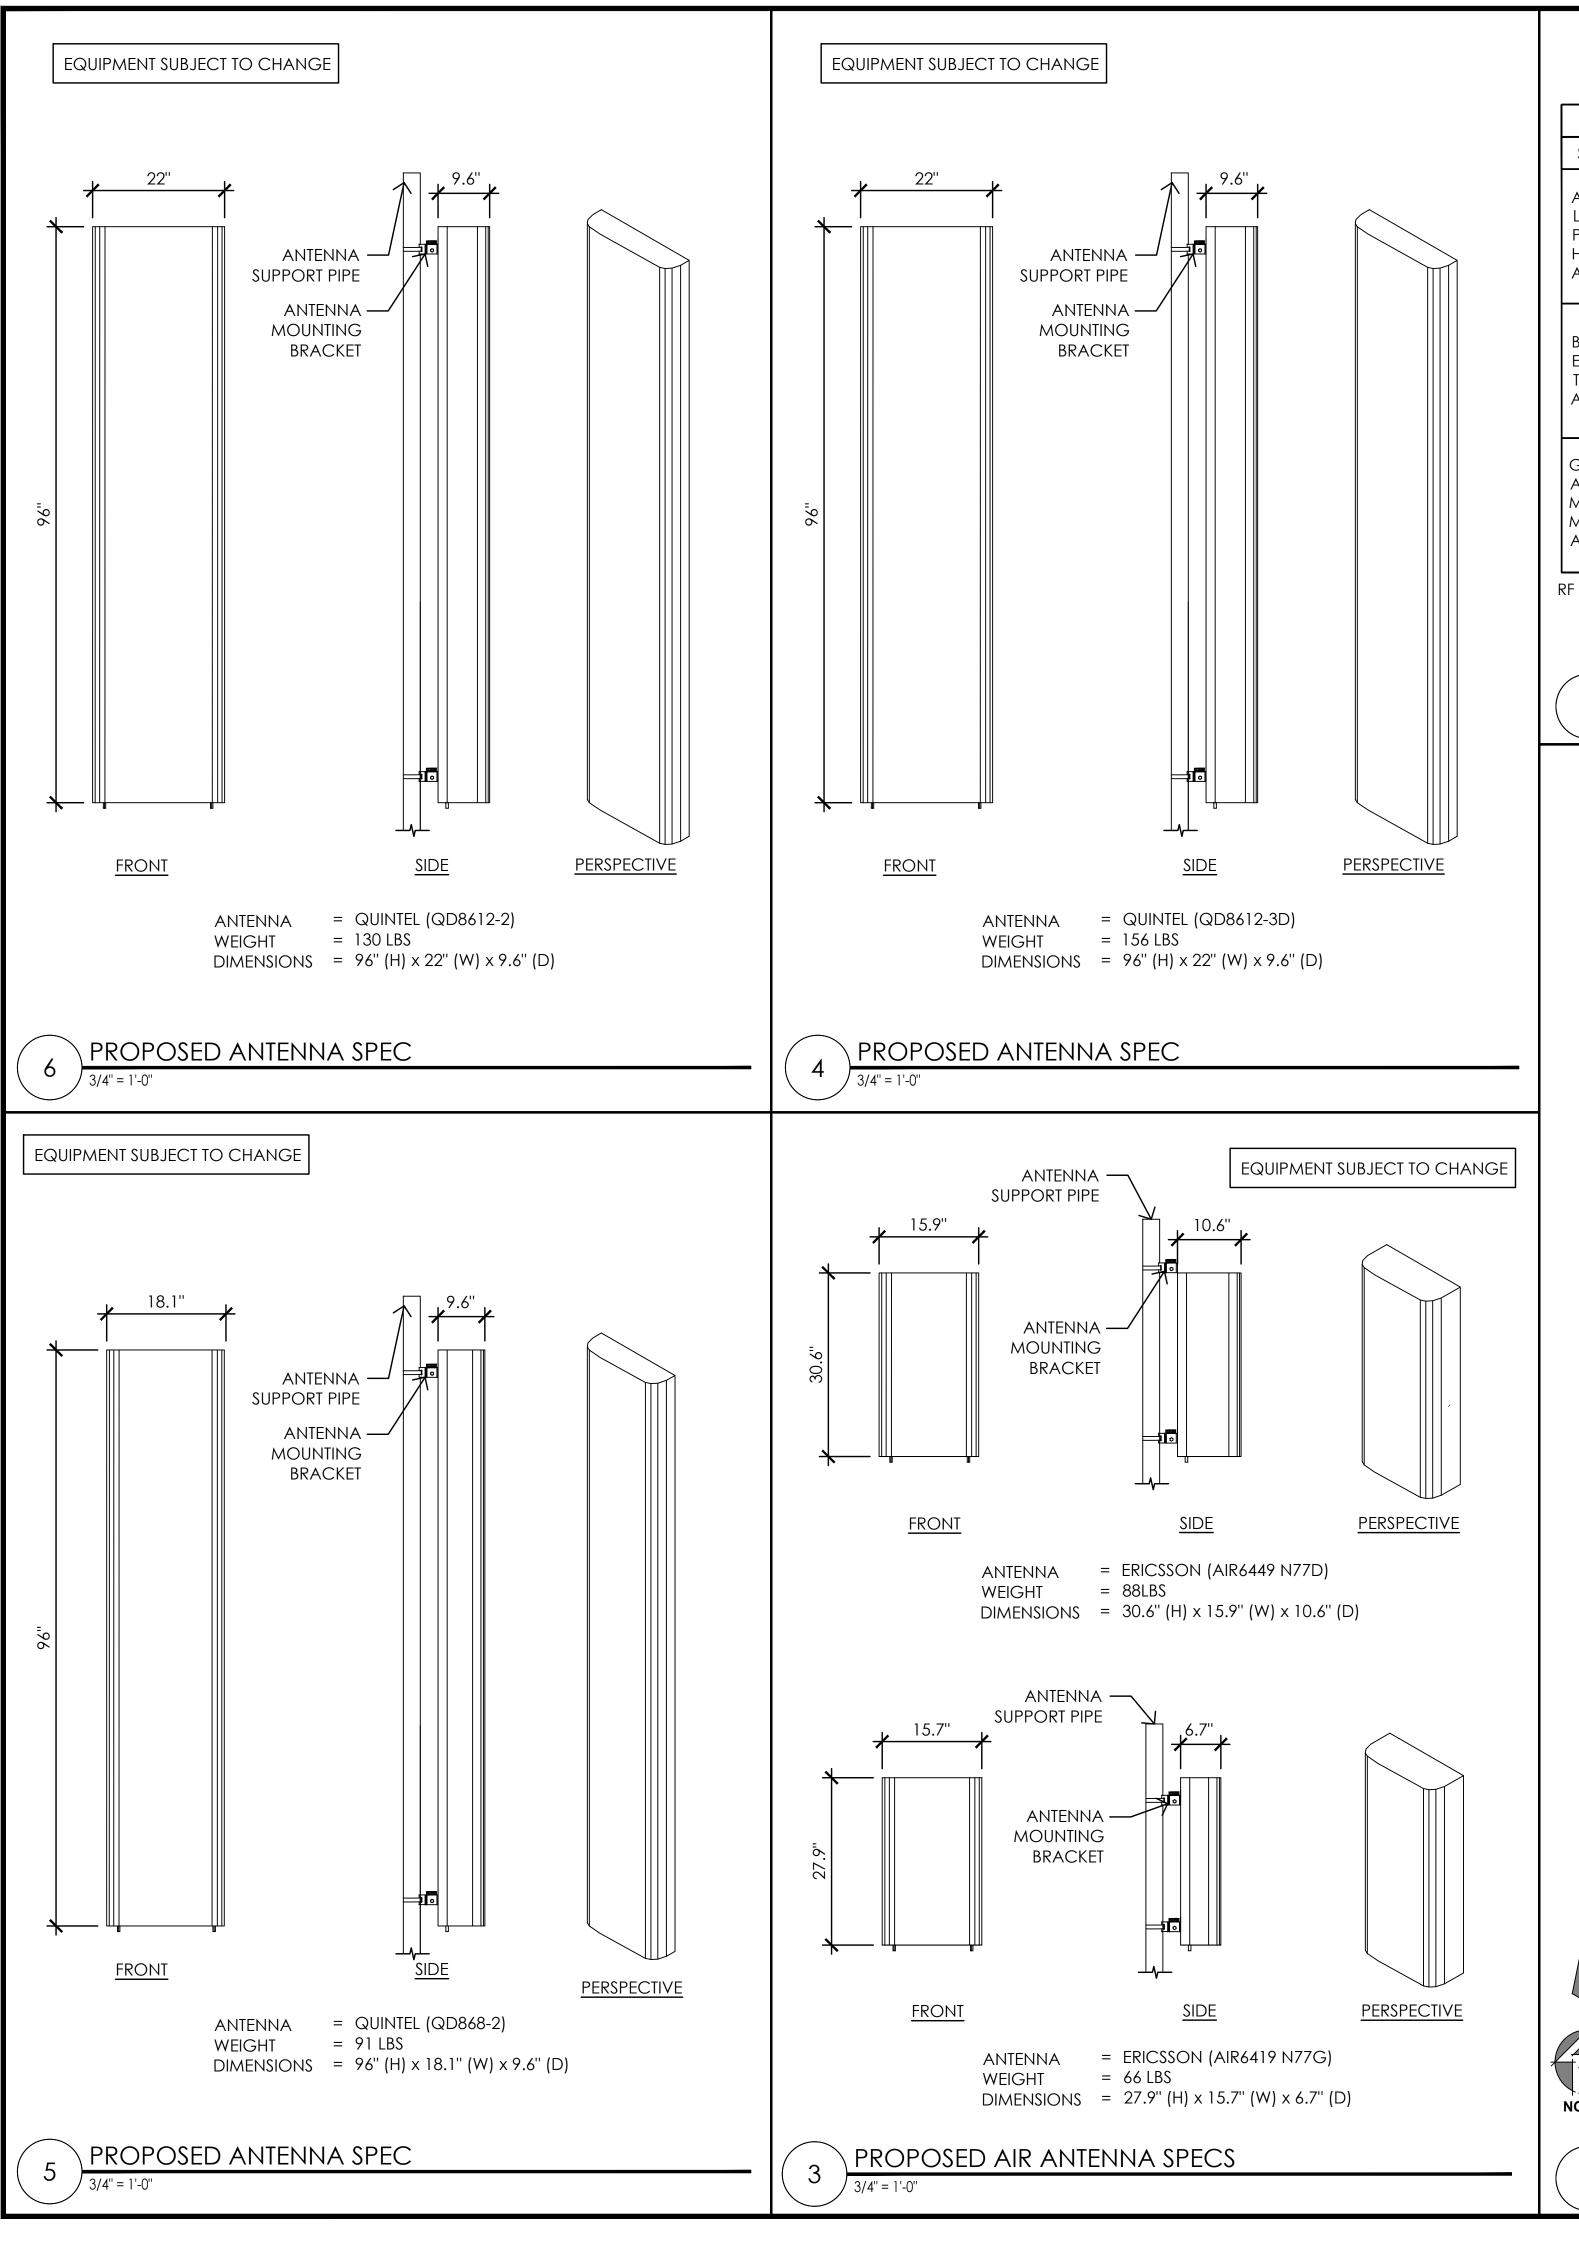


	RF SCHEDULE										
SECTOR ANTENNA MODEL NO.		AZIMUTH	CENTERLINE	RRH	FIBER LENGTH	COAX LENGTH	JUMPER TYPE	RRU NO.	DC FEEDS		
A	A1	Al QUINTEL - QD8612-3D		± 126'-0''	(1) 4449 B5/B12 / (1) 8843 B2/B66A	±50M	-	LDF4	(2)	(4)	
L	A2	ERICSSON - AIR6449 B77D & AIR6419 B77G (STACKED)	85°	± 126'-0''	-	±50M	-	LDF4	-	(2)	
H A3	A3	QUINTEL - QD8612-2	85°	± 126'-0''	(1) 4478 B14 / (1) 8843 B2/B66A	±50M	-	LDF4	(2)	(3)	
A	A4	QUINTEL - QD868-2	85°	± 126'-0''	(1) 2012 B29 / (1) 4415 B30	±50M	-	LDF4	(2)	(2)	
	В1	QUINTEL - QD8612-3D		± 126'-0''	(1) 4449 B5/B12 / (1) 8843 B2/B66A	±50M	-	LDF4	(2)	(4)	
B E	B2	ERICSSON - AIR6449 B77D & AIR6419 B77G (STACKED)	335°	± 126'-0''	-	±50M	-	LDF4	-	(2)	
T	В3	QUINTEL - QD8612-2	335°	± 126'-0''	(1) 4478 B14 / (1) 8843 B2/B66A	±50M	-	LDF4	(2)	(3)	
	В4	QUINTEL - QD868-2	335°	± 126'-0''	(1) 2012 B29 / (1) 4415 B30	±50M	-	LDF4	(2)	(2)	
G	C1	QUINTEL - QD8612-3D	230°	± 126'-0''	(1) 4449 B5/B12 / (1) 8843 B2/B66A	±50M	-	LDF4	(2)	(4)	
A	C2	ERICSSON - AIR6449 B77D & AIR6419 B77G (STACKED)	230°	± 126'-0''	-	±50M	-	LDF4	-	(2)	
M	C3	QUINTEL - QD8612-2	230°	± 126'-0''	(1) 4478 B14 / (1) 8843 B2/B66A	±50M	-	LDF4	(2)	(3)	
A	C4	QUINTEL - QD868-2	230°	± 126'-0''	(1) 2012 B29 / (1) 4415 B30	±50M	-	LDF4	(2)	(2)	

RF DATA SHEET v1.00 DATED 11/11/2021

NOTE: ANTENNA POSITIONS ARE LEFT TO RIGHT FROM FRONT OF ANTENNA EQUIPMENT IS PRELIMINARY AND SUBJECT TO CHANGE.



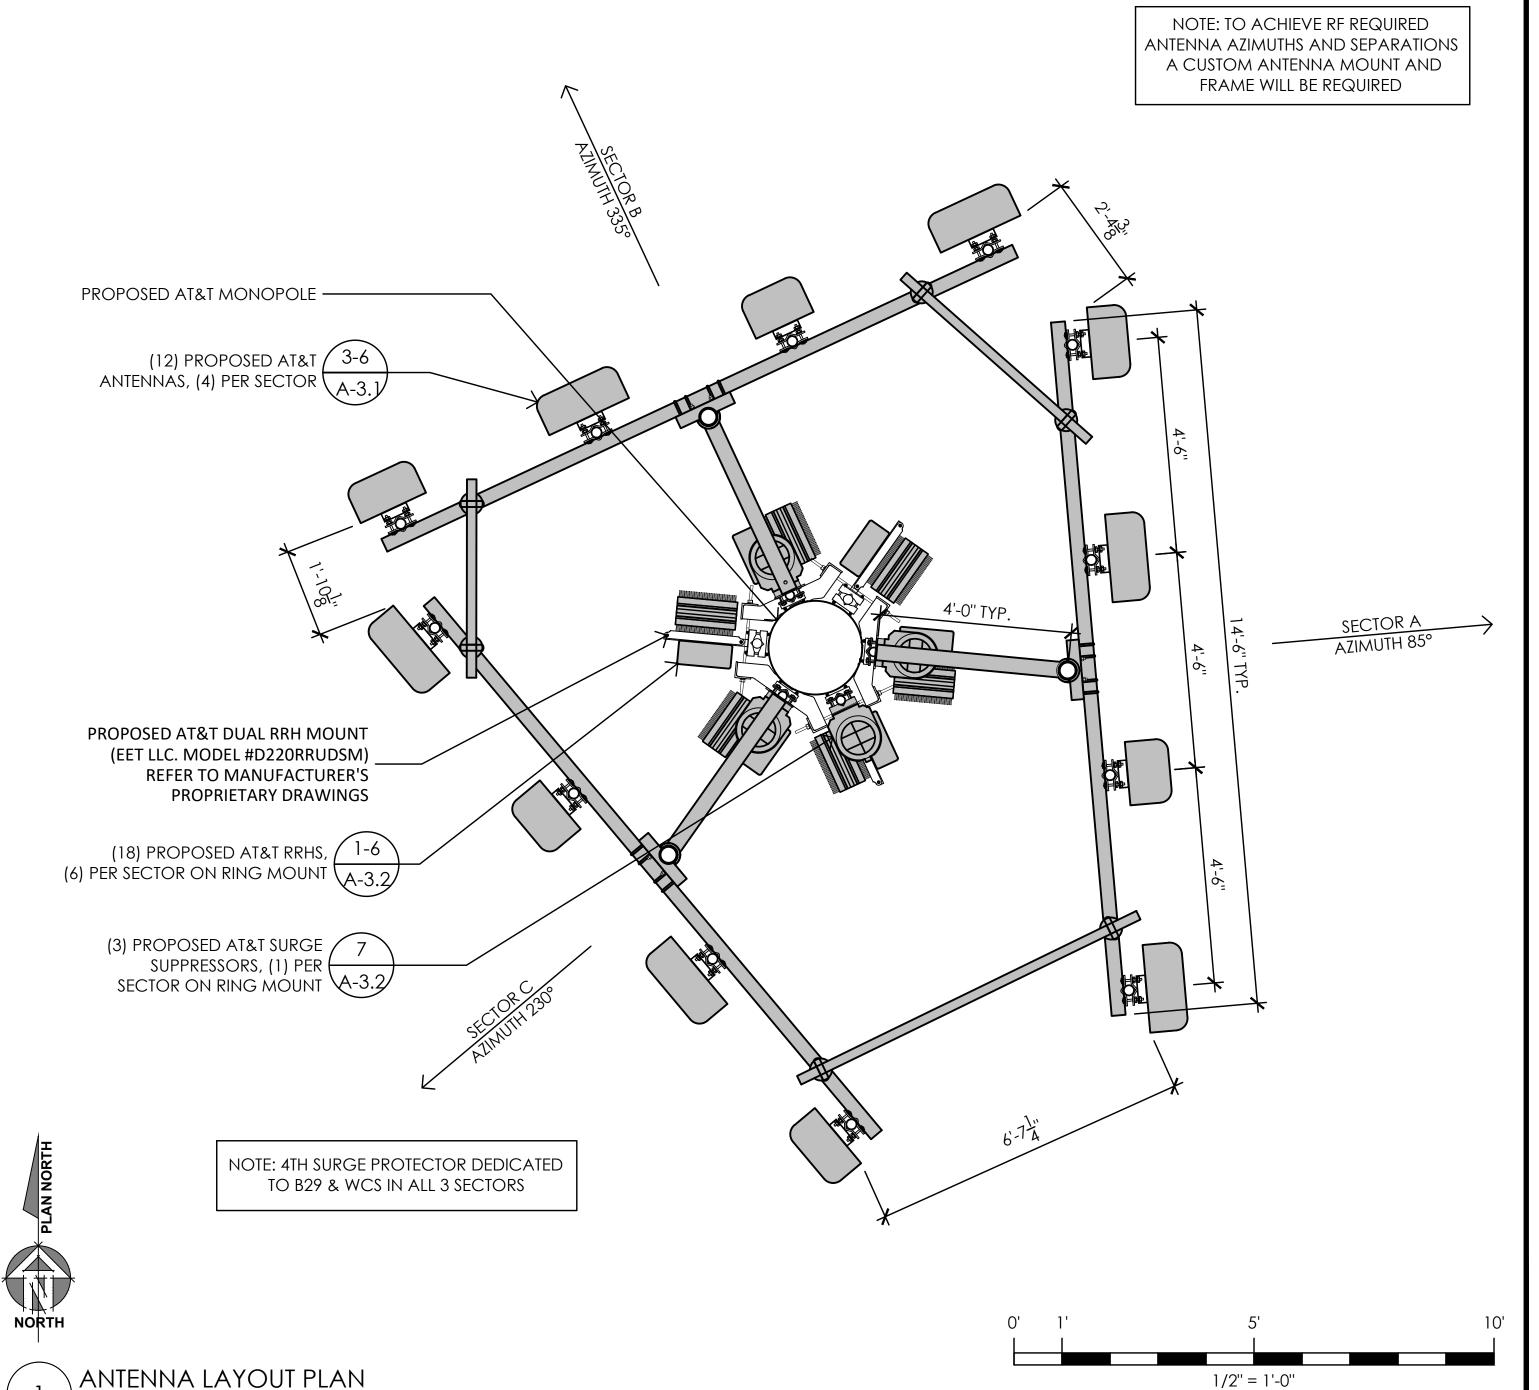

Issued For: CVL06197 BRONCO

6342 BYSTRUM ROAD CERES, CA 96307

WINE CO



2600 Camino Ramon San Ramon, California 94583



AT&T SITE NO: CVL06197 PROJECT NO: 162.2820

drawn by: TLS CHECKED BY: TST

01/05/22 100% ZD 12/02/21 90% ZD

REV DATE DESCRIPTION

Licensee:

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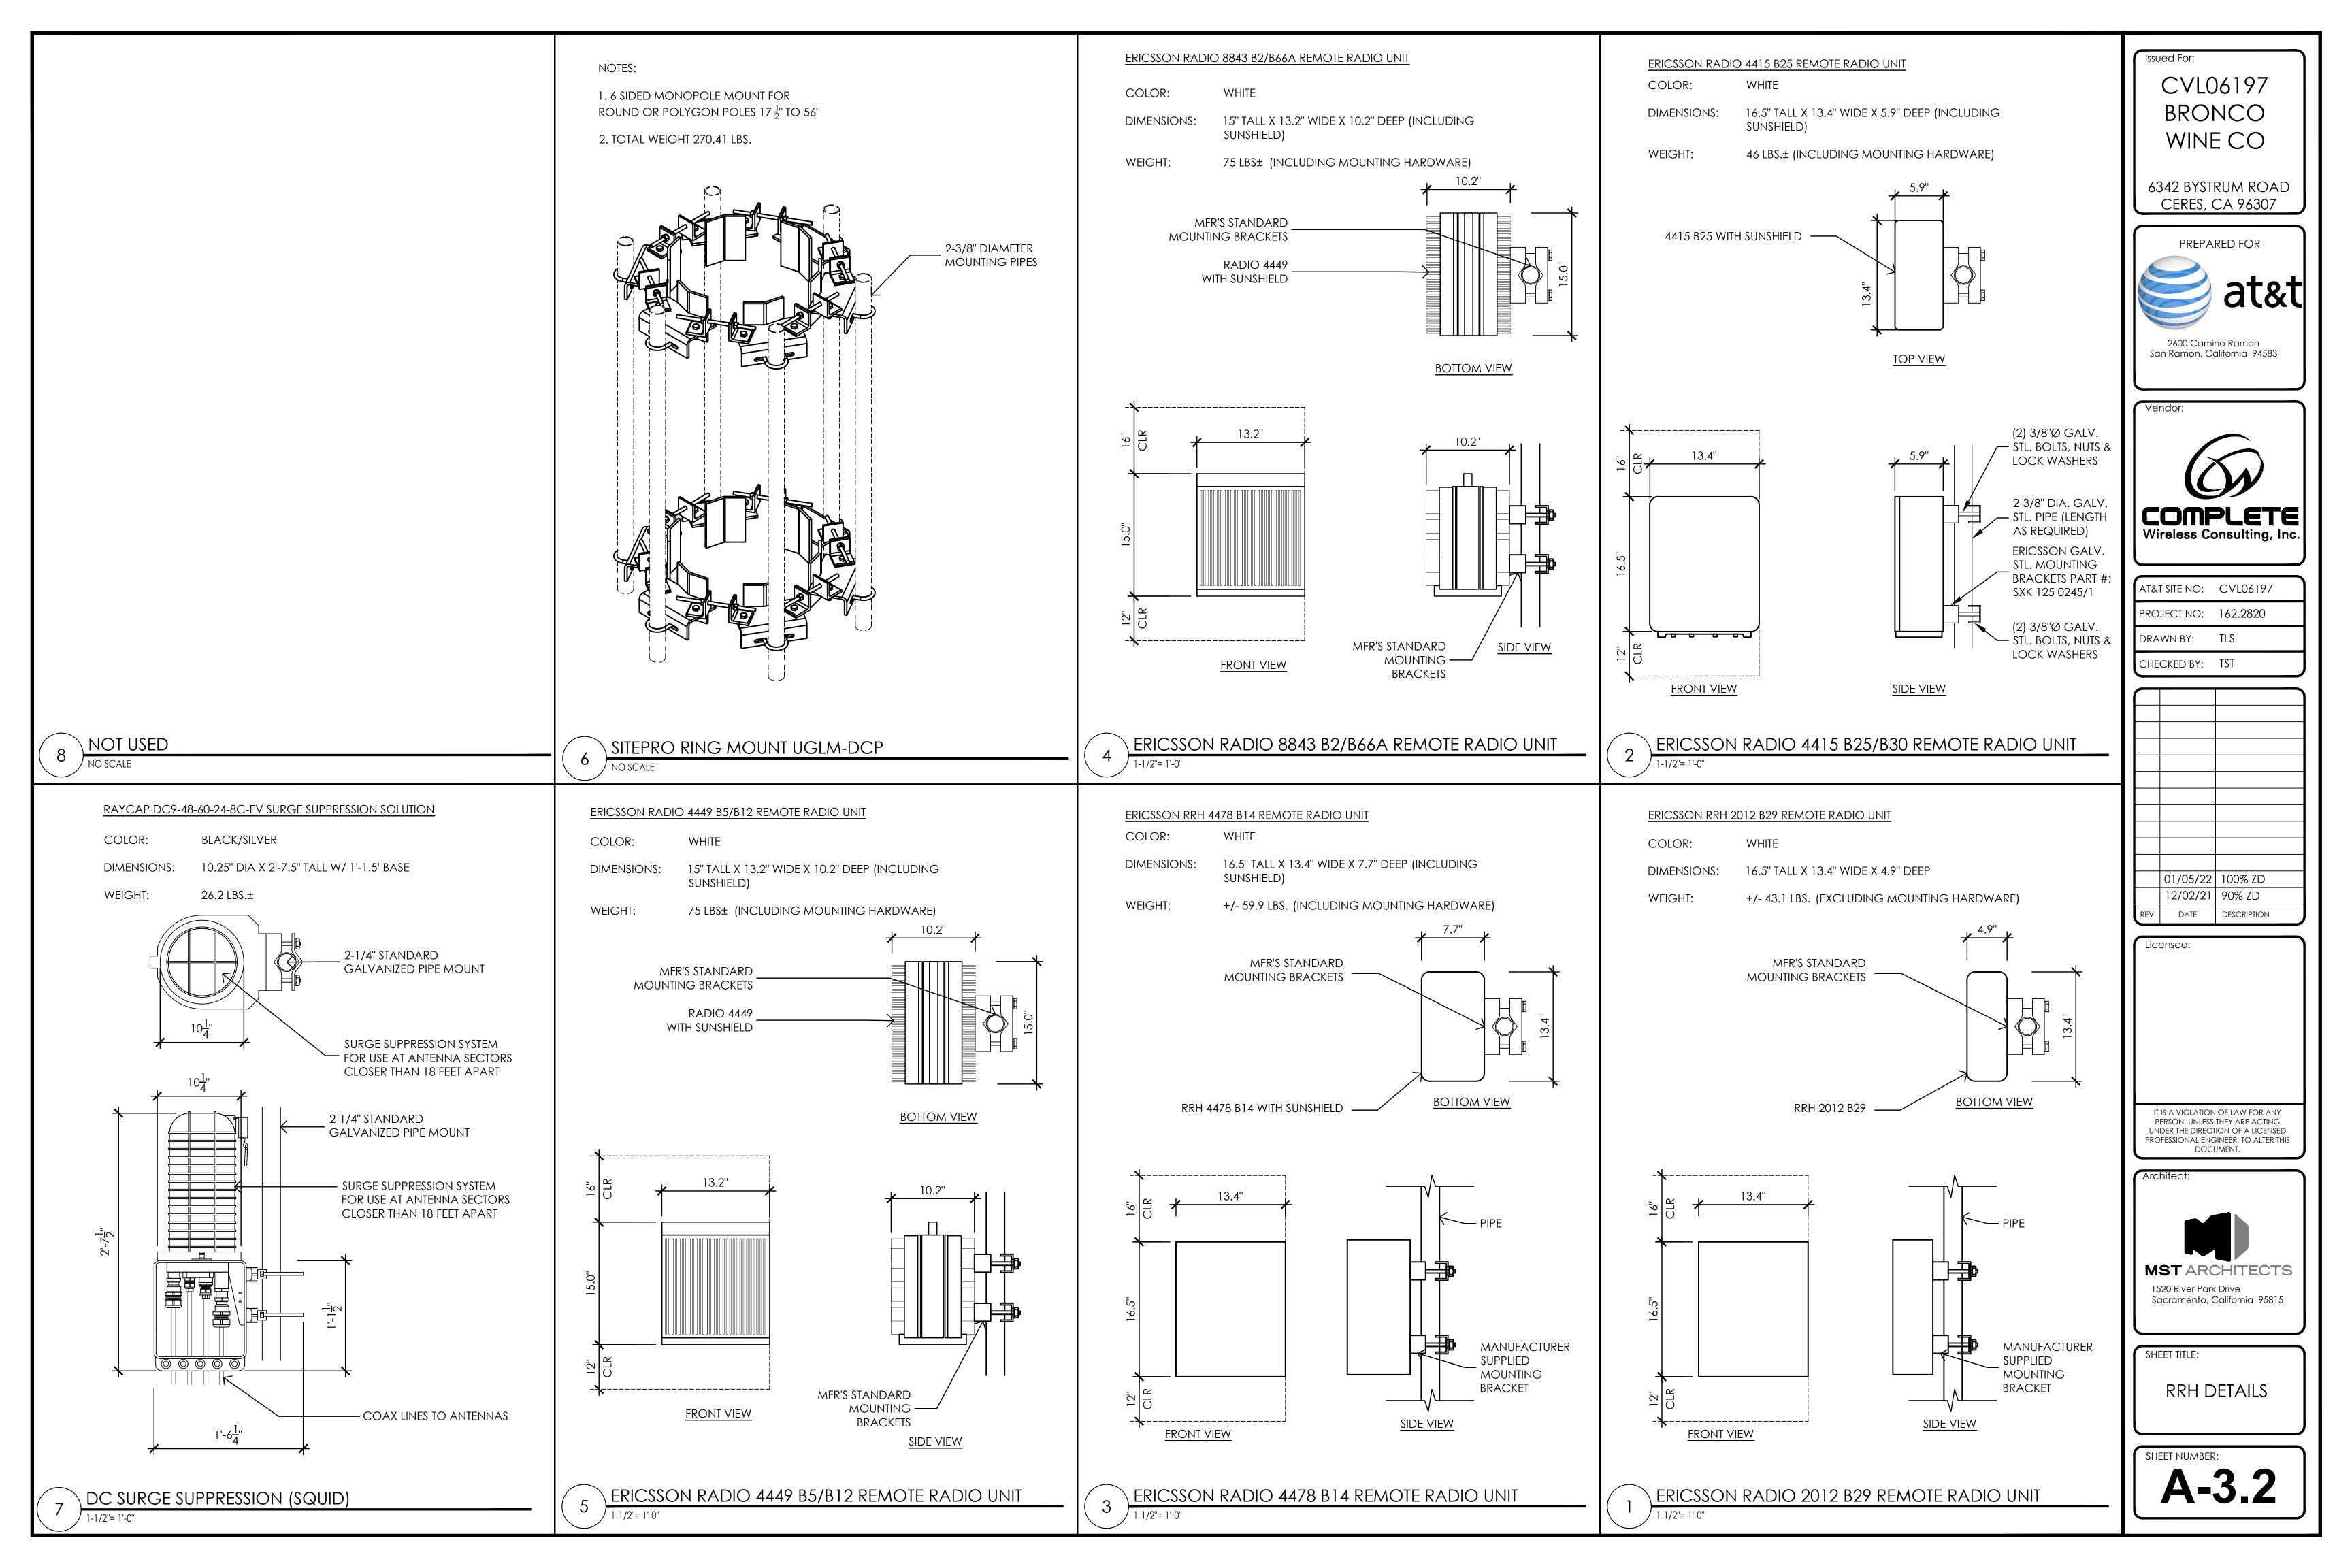
MST ARCHITECTS 1520 River Park Drive Sacramento, California 95815


SHEET TITLE: ANTENNA PLAN, SCHEDULE, & **DETAILS**


SHEET NUMBER:

A-3.1

ANTENNA LAYOUT PLAN



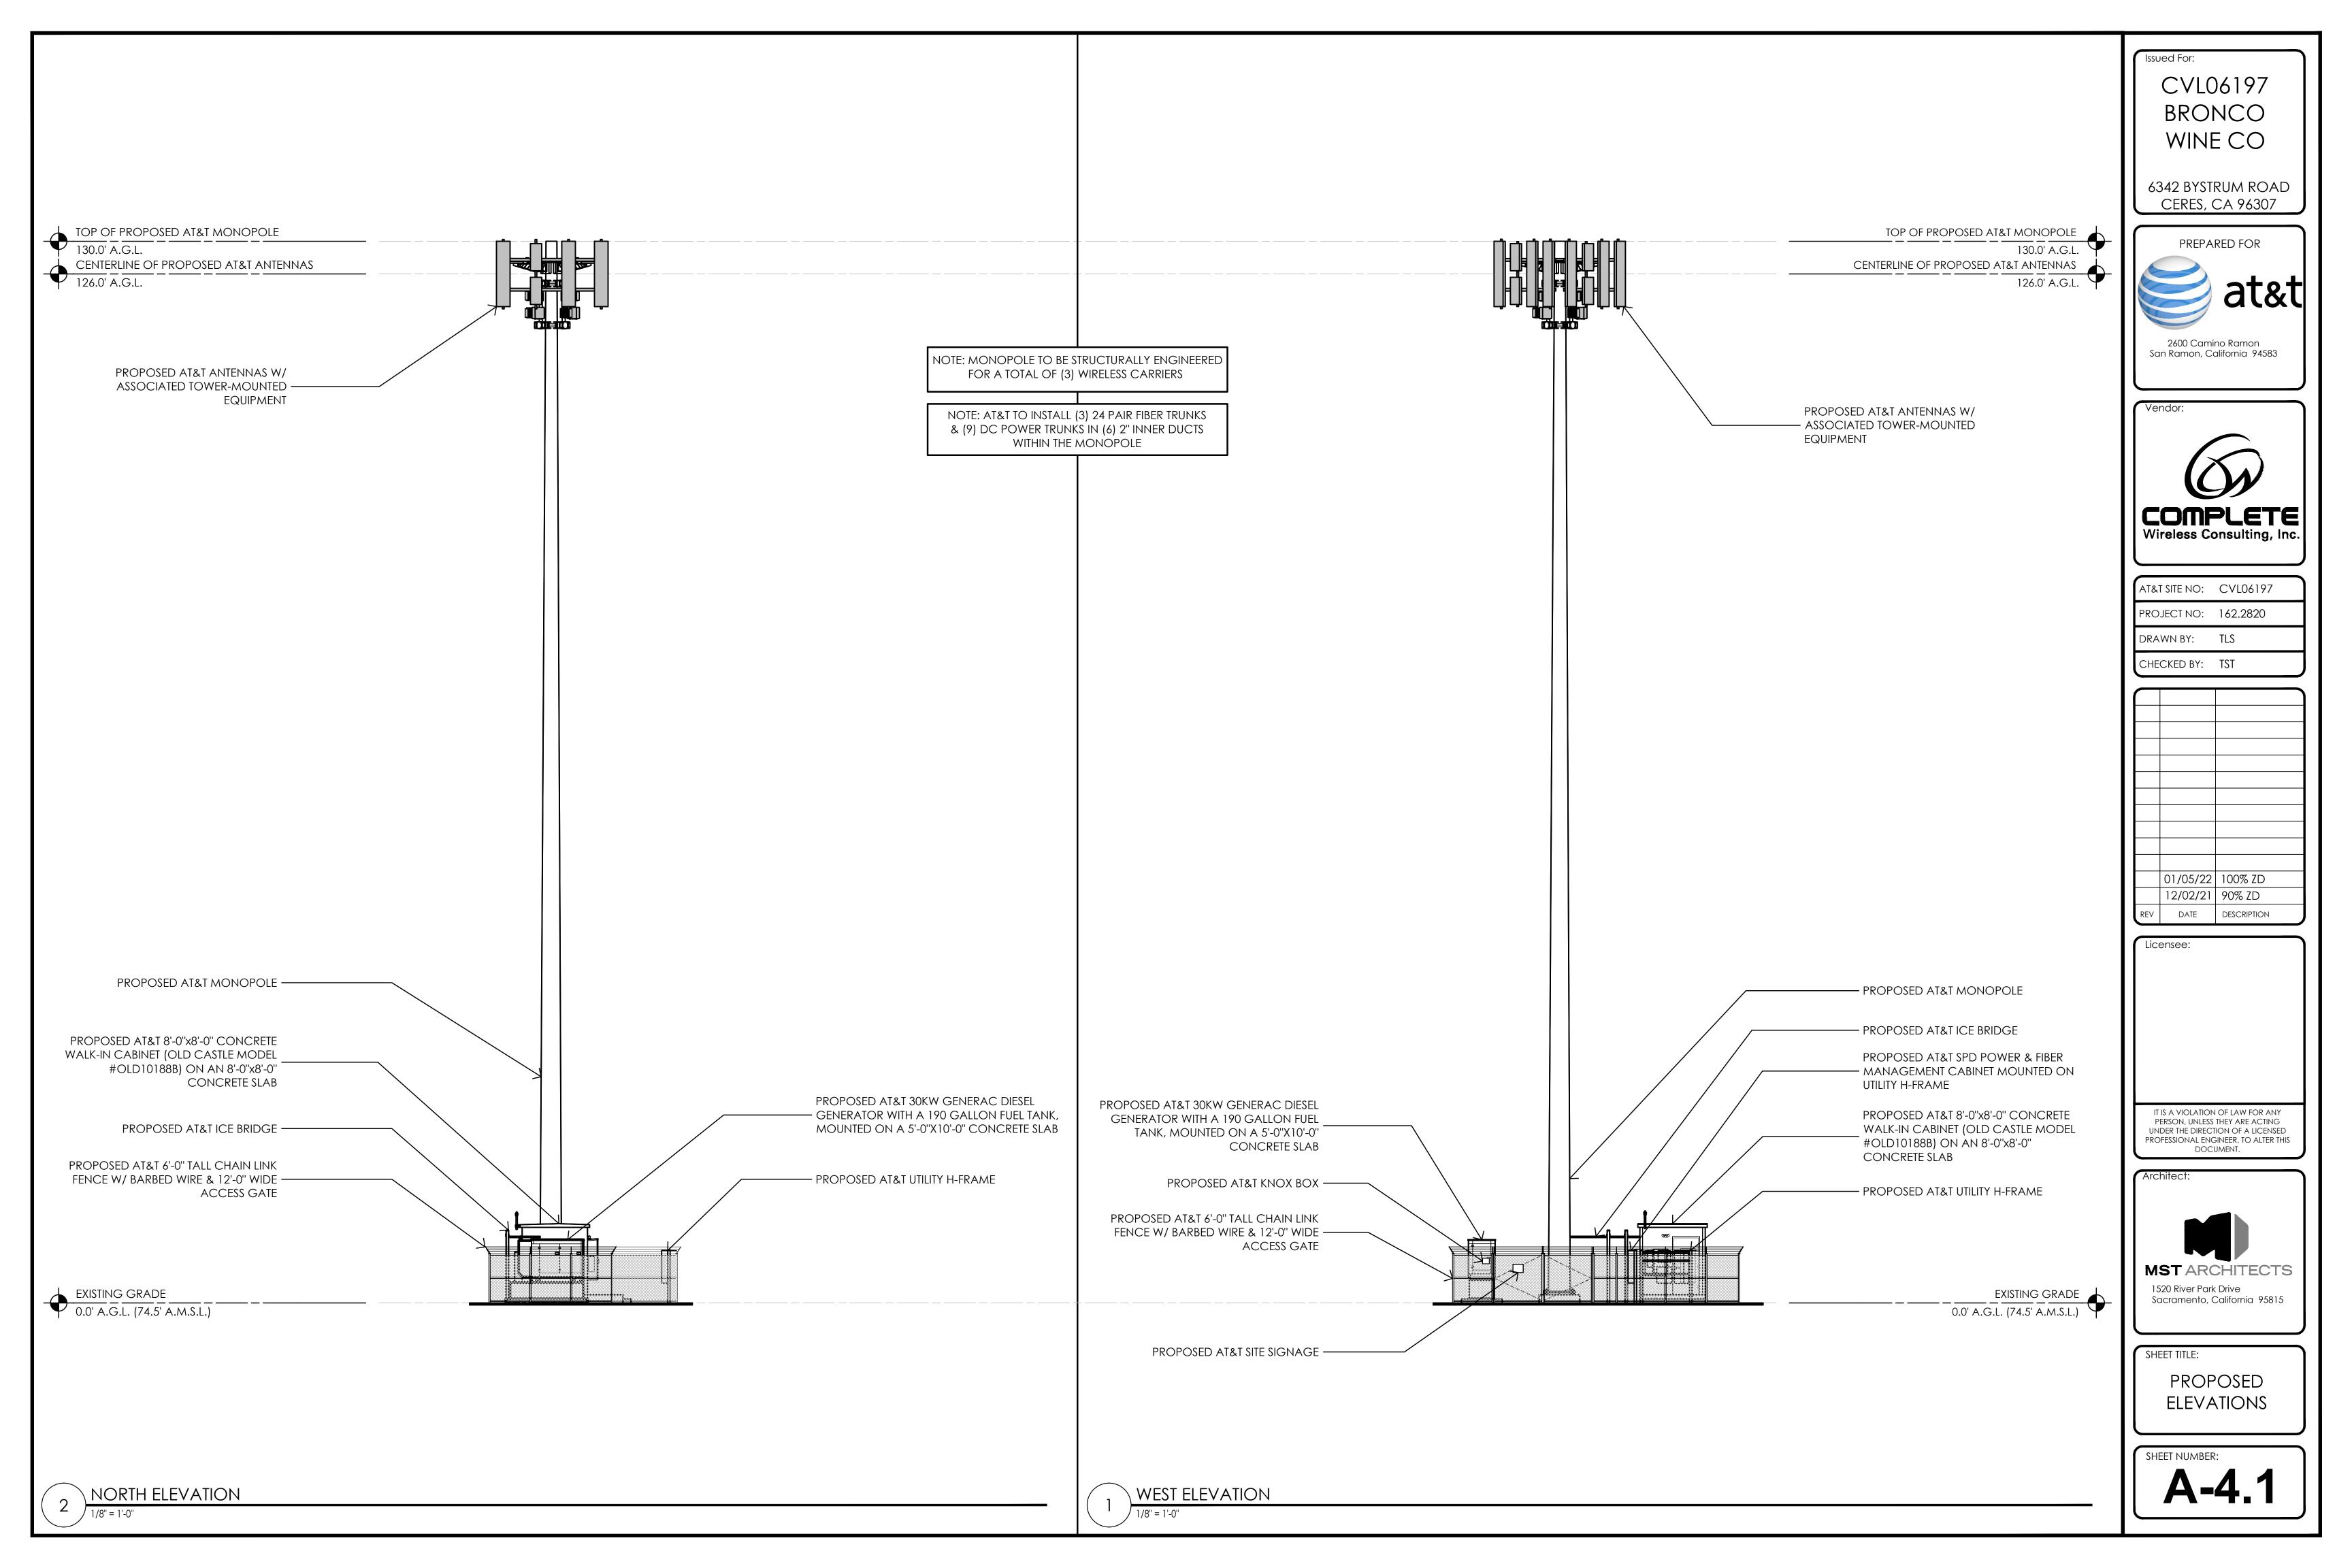

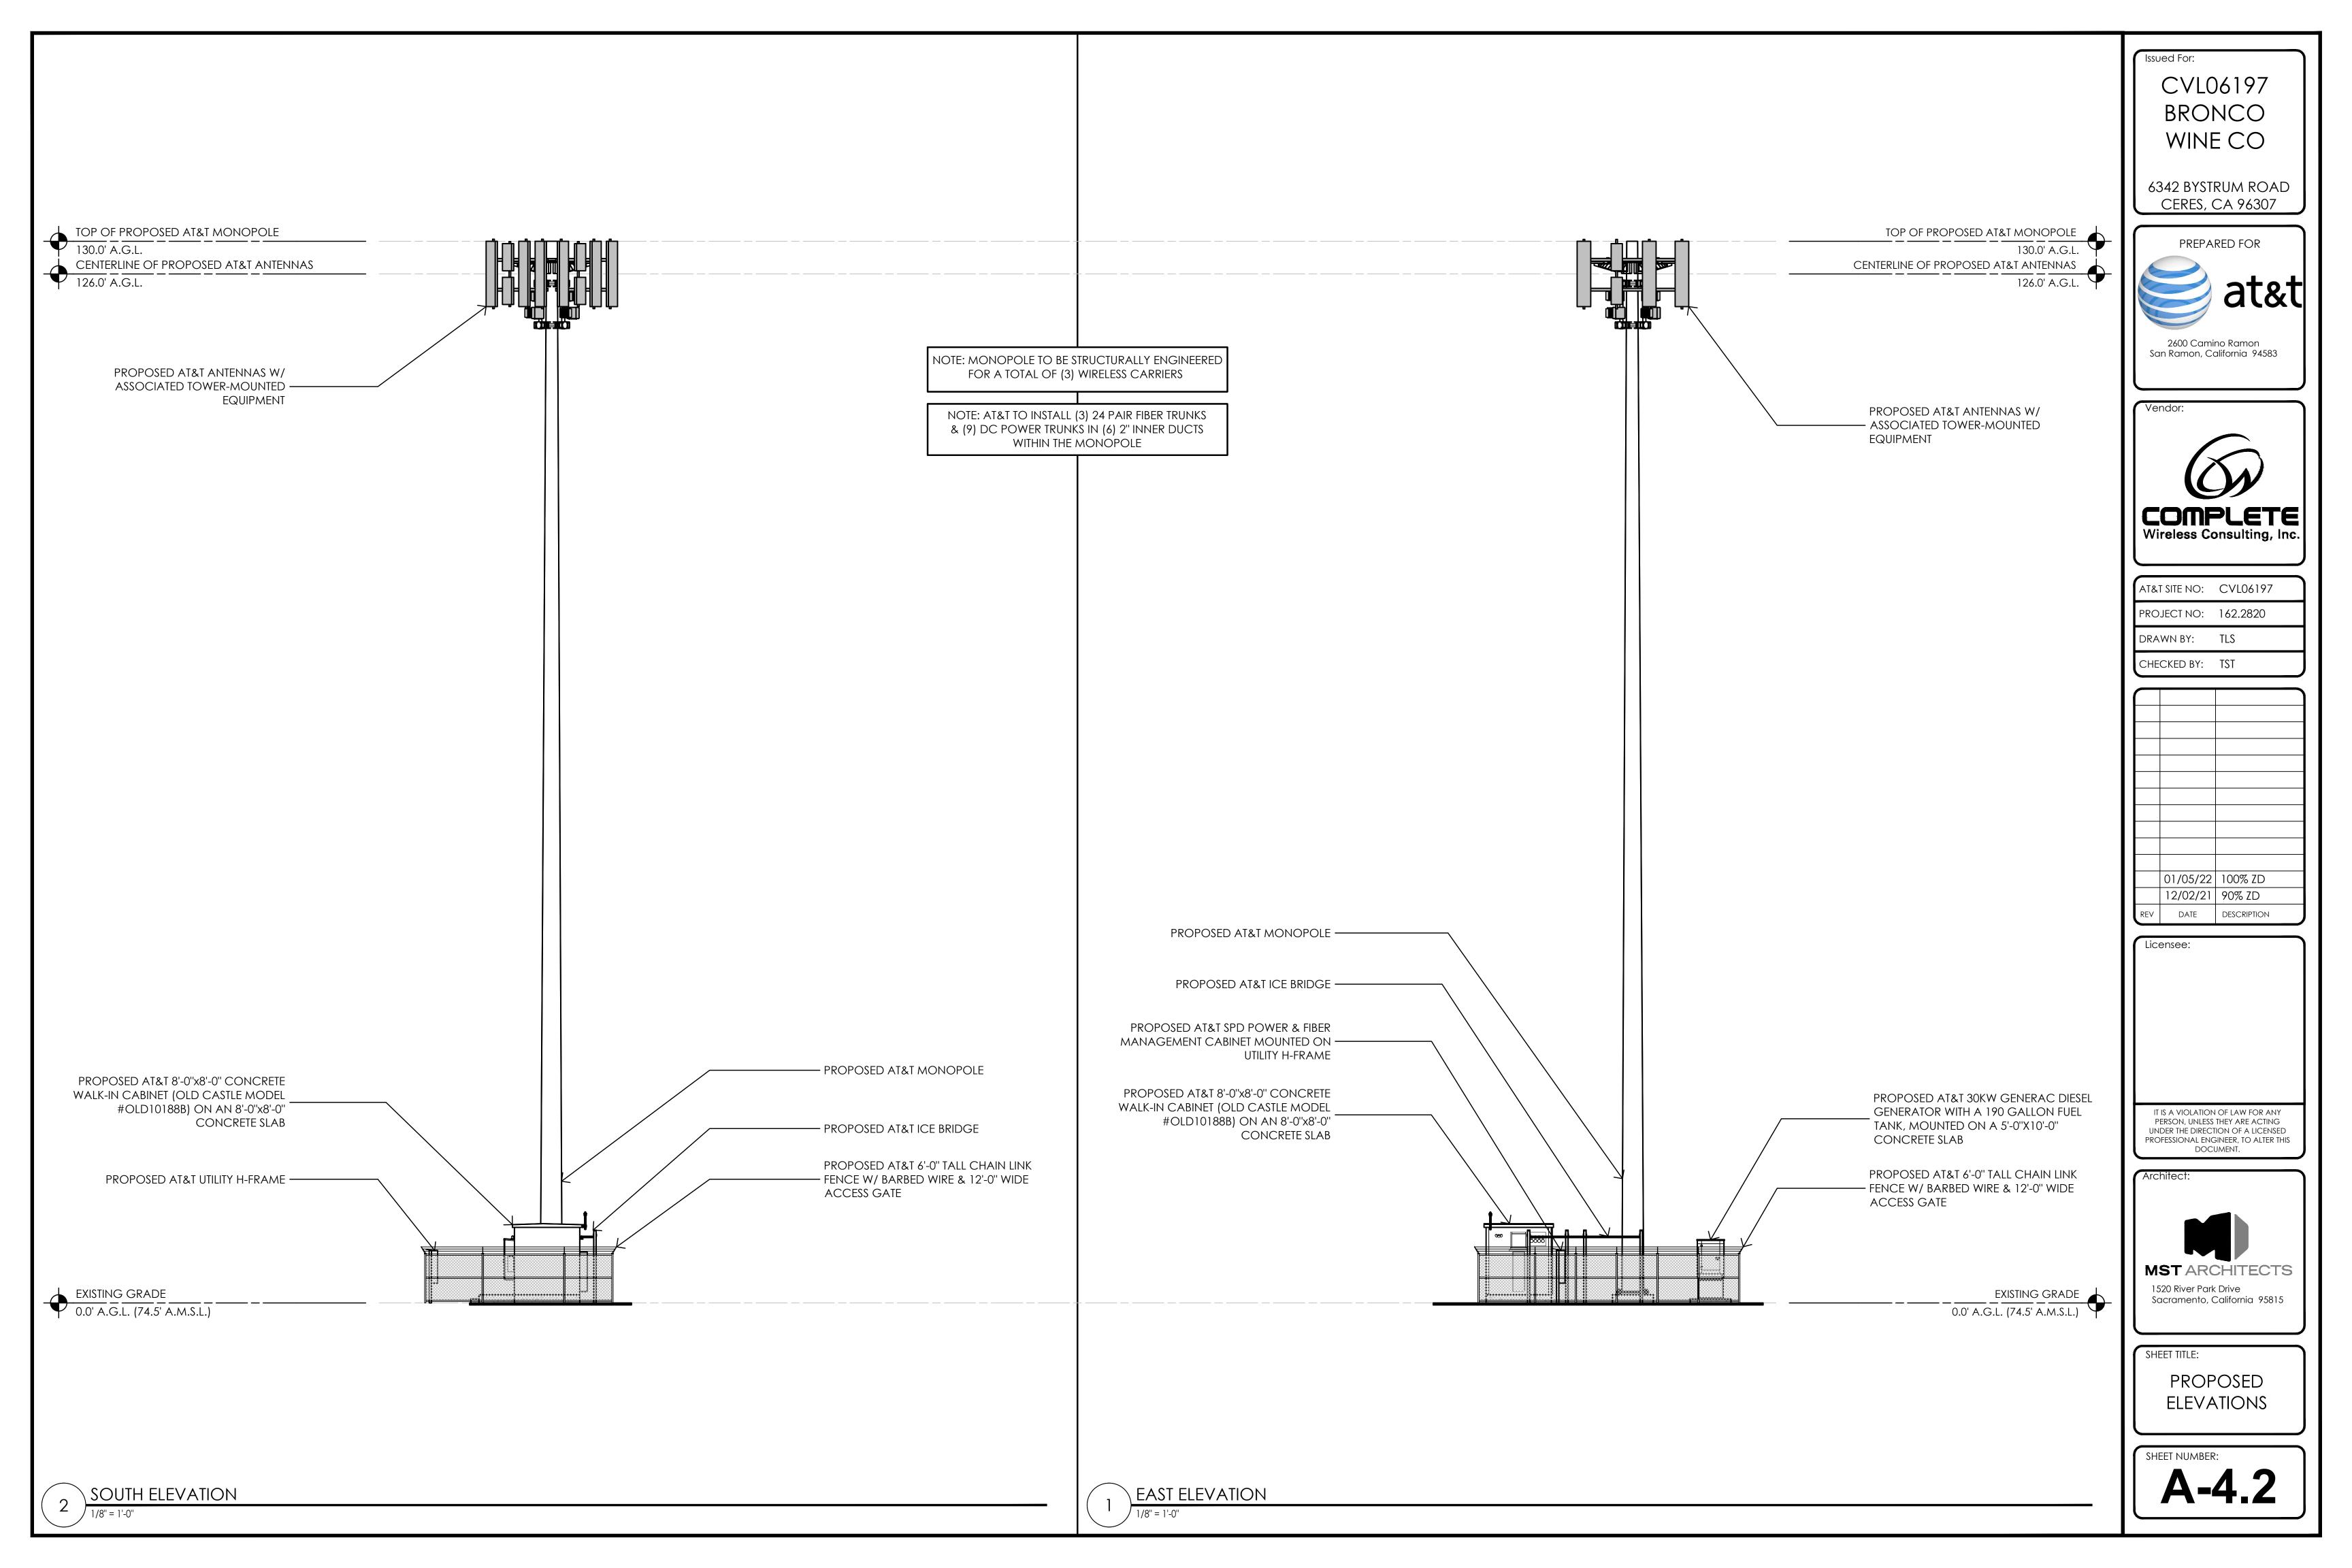

PANEL CIRCUIT AND LOAD SCHEDULE									DESIGNATION: PANEL "AT&T"									
LOAD PER PHASE (VA)								1 1				LOAD PER I		1010				
LOAD	PH	PHASE		POLES	WIRE		WIRE	POLES	TRIP	PHASE		LOAD						
DESCRIPTION		UNIT VA	A	В	TRIP	P0	>		3	9	Ë	Α	В	UNIT VA	QTY	DESCRIPTION		
1 SHELF #1: RECTIFIERS 1 & 2	1	1500	1500		- 30	2	10				60	0		0	1	SURGE ARRESTOR	2	
3	1	1500		1500						_	00		0	0	1	SONGE ANNESTON	4	
5	1	1500	1500		20	_	10		12	1	20	300		150	2	WORK LIGHTS	6	
SHELF #1: RECTIFIERS 3 & 4	1	1500		1500	30	2			12	1	20		180	180	1	DC POWER PLANT GFCI	8	
9	1	1500	1500		- 30	2	10] [12	1	20	800		800	1	DC POWER PLANT HEATER CTL	10	
SHELF #1: RECTIFIERS 5 & 6	1	1500		1500					12	1	20		10	10	1	BLOCK HEATER	12	
13	1	1500	1500		- 30			1	12	1	20	10		10	1	BATTERY CHARGER	14	
SHELF #1: RECTIFIERS 7 & 8	1	1500		1500		2	10						0				16	
.7	1	1500	1500		- 30	2	10					0					18	
SHELF #1: RECTIFIERS 9 & 10	1	1500		1500									0				20	
21	1	1500	1500		- 30	2						0					22	
SHELF #1: RECTIFIERS 11 & 12	1	1500		1500			10						0				24	
25	1	1500	1500		30	2	10	1				0					26	
SHELF #1: RECTIFIERS 13 & 14	1	1500		1500									0				28	
9	1	1500	1500		- 30	2	10	1				0					30	
SHELF #1: RECTIFIERS 15 & 16	1	1500		1500									0				32	
33			0					1				0					34	
35				0				1					0				36	
37			0					1				0					38	
39				0				1					0				40	
11			0					1				0					42	
				12000		'	•					1110	190	Subtotal		1	\dashv	
Voltage: 120/240 1 ph 3w					AIC:							PHASE A (KVA)	13.11				
Bus: 200 amps					Main:	LUG								PHASE B (
Enclosure: NEMA 3R Outdoor					Mount: Surface													
			1						<u> </u>	Tot	al Ampera							

PREPARED FOR

2600 Camino Ramon
San Ramon, California 94583

Vendor:

Issued For:

CVL06197

BRONCO

WINE CO

6342 BYSTRUM ROAD

COMPLETE
Wireless Consulting, Inc.

AT&T SITE NO: CVL06197

PROJECT NO: 162.2820

DRAWN BY: TLS

CHECKED BY: \$V

01/05/22 100% ZD 12/02/21 90% ZD REV DATE DESCRIPTION

Licensee:

IT IS A VIOLATION OF LAW FOR ANY
PERSON, UNLESS THEY ARE ACTING
UNDER THE DIRECTION OF A LICENSED
PROFESSIONAL ENGINEER, TO ALTER THIS

DOCUMENT.

Architect:



1520 River Park Drive Sacramento, California 95815

SHEET TITLE:

POWER SINGLE LINE DIAGRAM

SHEET NUMBER:


E-3

OUTDOOR EQUIPMENT POWER SCHEDULE

NTS

SINGLE LINE DIAGRAM


NO SCALE

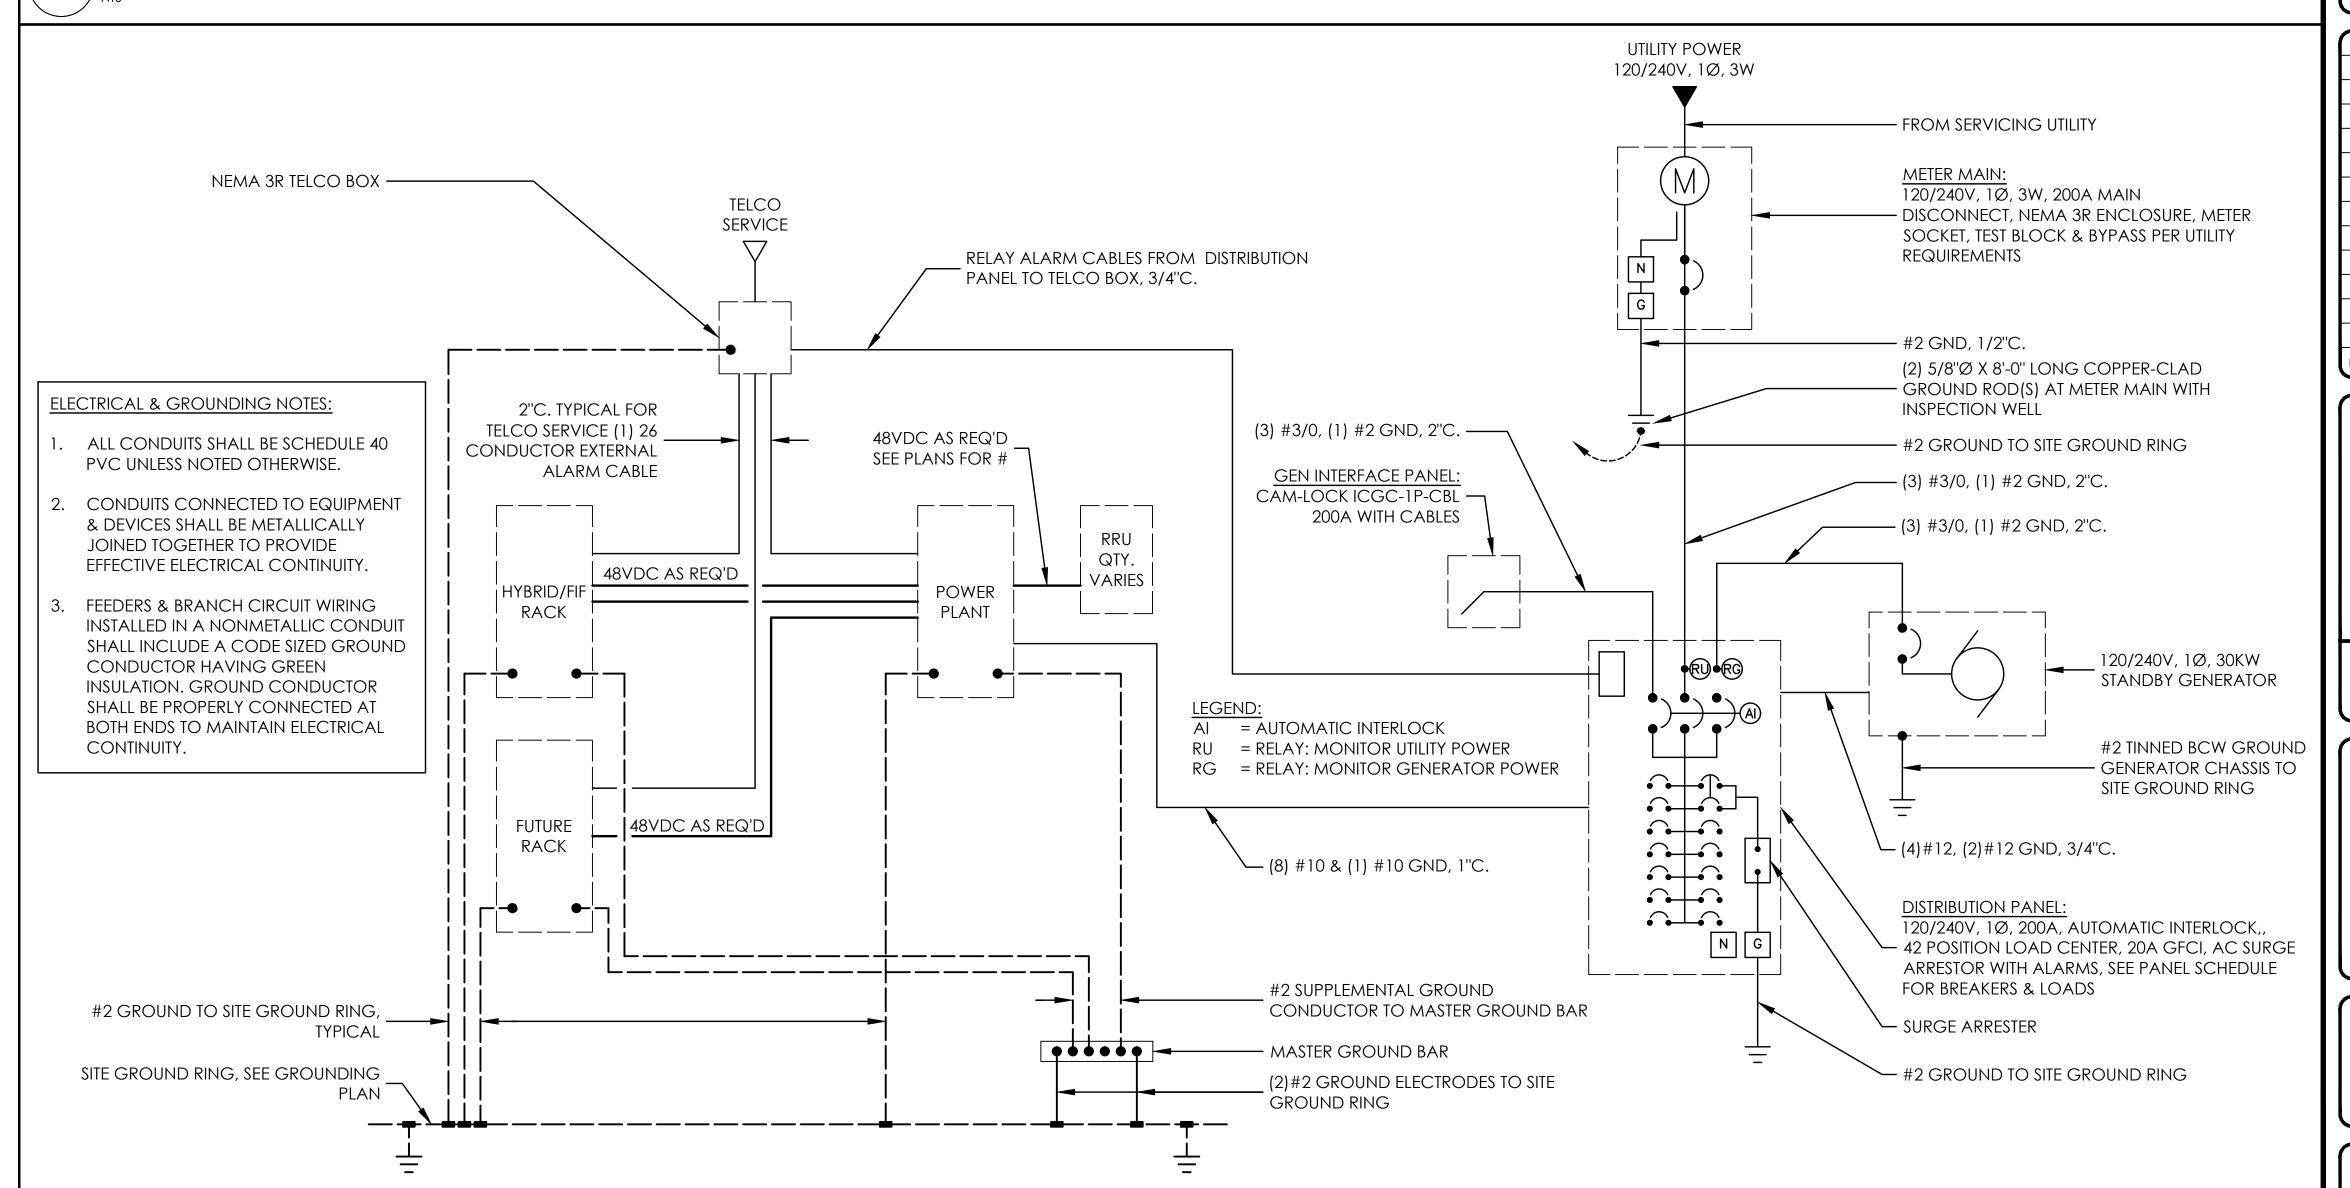

CVL06197 Zoning Propagation Map


December 28, 2021

Existing LTE 700 Coverage

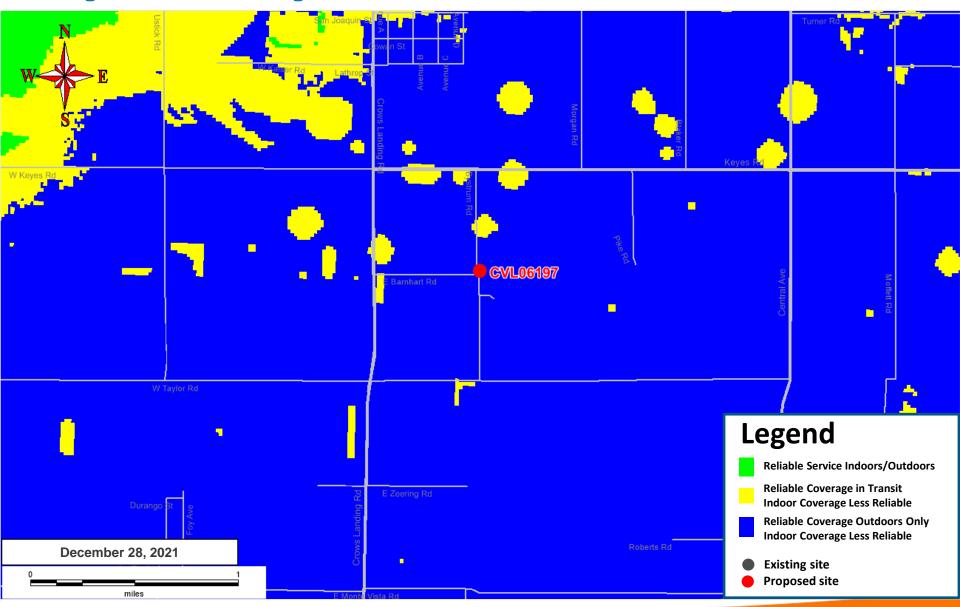



Proposed LTE 700 Coverage - 6342 BYSTRUM ROAD @ RC = 126 ft

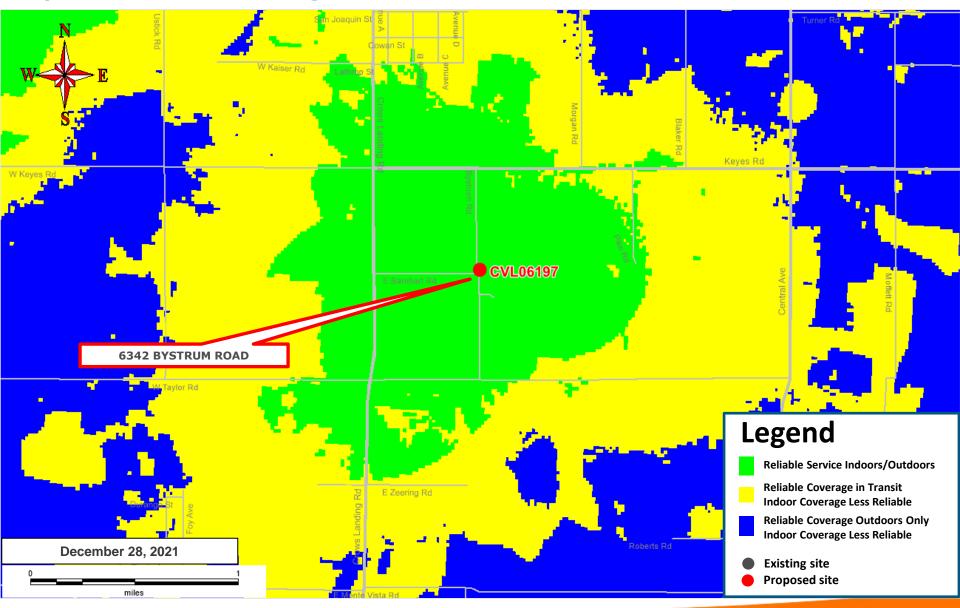



AT&T MOBILITY PROJECT SUPPORT STATEMENT

Site Name: CVL06197

Site Address: 6342 Bystrum Road, Ceres

APN: 041-046-021

INTRODUCTION & FACILITY DESCRIPTION

The demand for wireless and data services continues to grow across California. Access to the wireless network has become vital as individuals increasingly rely on handheld and mobile devices as their primary method of communication. AT&T Mobility constantly seeks to improve its wireless network through industry-leading techniques and innovative solutions to respond to high levels of wireless network traffic and increased user demand. This proposal for a new wireless telecommunications facility is an essential part of the effort to continuously improve the AT&T network for future and potential customers. The facility proposal is designed to comply with all wireless communications guidelines set forth by the County of Stanislaus.

This is a proposal for a new, freestanding wireless telecommunications facility. A 130' tall monopole style facility is proposed, with the monopole and supporting ground equipment placed in a fenced, 576 square foot compound.



Location

The subject property is located within unincorporated Stanislaus County and is zoned Planned Development PD ([355]). The property is a developed, 117 acre parcel containing an operations center for a large wine company.



Project Location: Corner of Barnhart & Bystrum

Design

AT&T is proposing a 130' tall monopole style facility, with three sectors of five antennas, for a total of 15 antennas, mounted at a 126' centerline. The monopole would be placed within an irregularly shaped, 576 square foot fenced compound that has been placed to prevent interference with existing operations on the property. Supporting ground equipment within the compound would include an 8' by 8' walk-in equipment cabinet and a 30 kW emergency backup diesel generator with a 190 gallon fuel tank on a 5' by 10' concrete slab.

As designed, the facility complies with all Stanislaus County design requirements and setbacks. Because of the nature of the existing development in the area, and the lack of comparable sized trees for screening the monopole itself, a plain, unstealthed design is being proposed, to be painted a flat, non-reflective gray.

No landscaping is being proposed – the property already has a row of evergreens in place that screens the existing operations on the property.






DESCRIPTION OF COVERAGE AREA AND ALTERNATE SITES CONSIDERED

The objective of the proposed facility is to cover a roughly nine square mile area ranging from Monte Vista Road to Grayson Road, along Crows Landing Road, that currently suffers from poor service. A search area – the area within which it is possible for a new facility to fill the existing coverage gap – was identified by the AT&T Radio Access Engineer for the project.


There were no existing facilities within the search area – the nearest existing facility is one mile to the south, and a colocation would therefore be unable to fill the existing coverage gap. A new facility is therefore being proposed on an already developed parcel as the least intrusive means of filling the existing coverage gap.

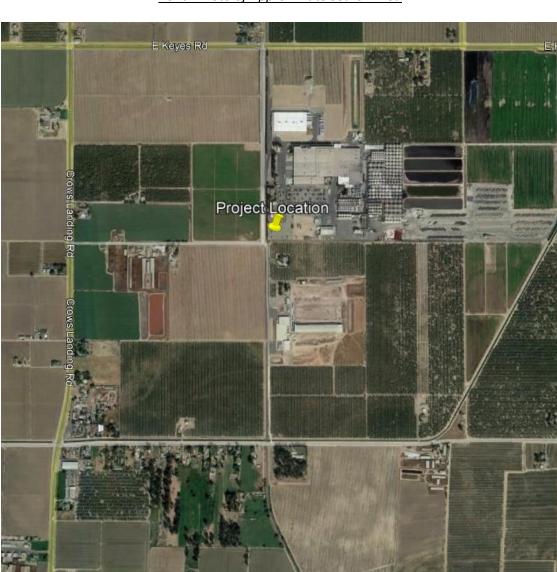


Aerial Photo of Approximate Search Area

EXISTING AND PROPOSED COVERAGE

Existing LTE 700 Coverage

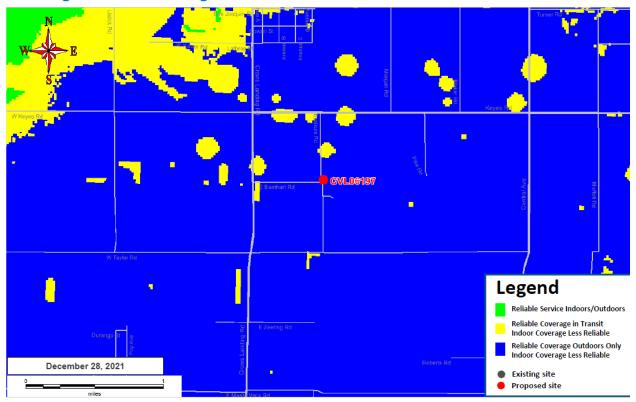

Proposed LTE 700 Coverage - 6342 BYSTRUM ROAD @ RC = 126 ft

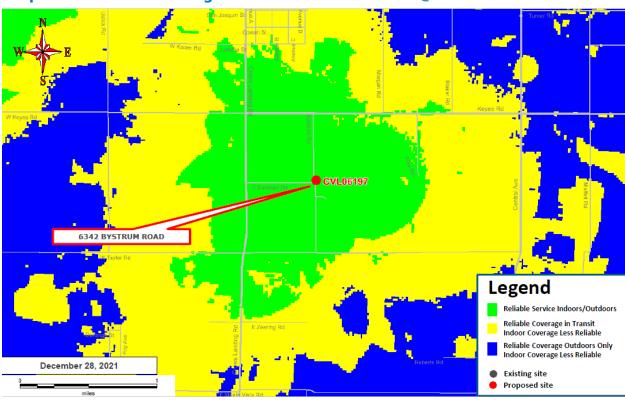

ADDITIONAL INFORMATION

Safety Benefits of Improved Wireless Service

AT&T offers its customers multiple services such as voice calls, text messaging, mobile email, picture/video messaging, mobile web, navigation, broadband access, V CAST, and E911 services. Mobile phone use has become an extremely important tool for first responders and serves as a back-up system in the event of a natural disaster. AT&T will install a standby generator at this facility to ensure quality communication for the surrounding community in the event of a natural disaster or catastrophic event. This generator will be fully contained within the equipment shelter and will provide power to the facility if local power systems are offline.

Maintenance

AT&T installs standby generators and backup batteries at all its cell sites. The batteries play a vital role in AT&T's emergency and disaster preparedness plan. In the event of a power outage, the back-up generator will automatically start and continue to run the site for up to 24 hours. The standby generator will operate for approximately 15 minutes per week for maintenance purposes and will only be tested during the daytime. Back-up generators allow AT&T's sites to continue providing valuable communications services in the event of a power outage, natural disaster or other emergency. Following construction, a small sign indicating the facility owner and a 24-hour emergency telephone number will be provided on site.

Parking & Traffic

The facility is unmanned and will operate 24 hours a day, seven days a week. A technician will occasionally visit the facility to service the equipment, approximately once a month. There will no other visitors or guests associated with the facility.

Construction Schedule

The construction of the facility will follow all local rules and regulations. The crew size will range from two to ten individuals. The construction phase of the project will last approximately two months and will not exceed acceptable noise levels.

Compliance with FCC Standards

This project will not interfere with any TV, radio, telephone, satellite, or other signals. Any interference would be against federal law and a violation of AT&T's FCC license. An RF report verifying compliance with FCC guidelines is included with this submittal.

Environmental Assessment

The project is categorically exempt under CEQA as a Class III small structure. A study verifying compliance with FCC regulations has been included as part of this application.

Water Usage

As the facility is unmanned and no landscaping is proposed, there will be no impact on water usage on the property.

6342 Bystrum Road, Ceres, CA, 96307; APN 041-046-021; AT&T Mobility Site ID CVL06197

Notice of Actions Affecting Development Permit

In accordance with California Government Code Section 65945(a), AT&T requests notice of any proposal to adopt or amend the: general plan, specific plan, zoning ordinance, ordinance(s) affecting building or grading permits that would in any manner affect this development permit. Any such notice may be sent to 2009 V Street, Sacramento, CA 95818.