STANISLAUS COUNTY

PLANS FOR THE CONSTRUCTION OF

SHIELLS ROAD BRIDGE REPLACEMENT AND IMPROVEMENTS PROJECT

FEDERAL PROJECT NO. BRLO-5938 (192) STANDARD PLANS 2010



STATE OF CALIFORNIA

COUNTY OF STANISLAUS

2/21/18 DATE

JULY 14, 2017 DATE BRADLEY WALDROP, PE RCE 59724

CENTRAL CALIFORNIA IRRIGATION DISTRICT

REVIEWED AND APPROVED FOR CONFORMANCE WITH THE CENTRAL CALIFORNIA IRRIGATION DISTRICT REQUIREMENTS ONLY. SINCE PLANS WERE PREPARED BY OTHERS, NO RESPONSIBILITY FOR THE ADEQUACY OF THE PLANS IS EXPRESSED.

1335 W. "I" ST LOS BANOS, CA 93635 (209) 826-1421


CENTRAL CALIFORNIA IRRIGATION DISTRICT

NV5, INC.

15 FEB. 2018 DATE

2025 GATEWAY PLACE, SUITE 156 SAN JOSE, CA 95110 408.392.7200 TEL 408.392.0101 FAX



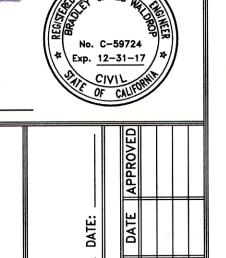

SUBMITTED:

JULY 14, 2017



SHIELLS ROAD BRIDGE REPLACEMENT

JOB NO SAB048800 DATE <u>7/14/17</u>

DR BY BW CK BY BW SCALE AS SHOWN

SHEET **NUMBER**

_ OF 23 SHEETS

3. TYPICAL SECTIONS & DETAILS X-14. CONSTRUCTION DETAILS - 1 5. CONSTRUCTION DETAILS - 2 DT-3 6. CONSTRUCTION DETAILS - 3 DT-4 7. CONSTRUCTION DETAILS - 4 DM-1 8. DEMOLITION PLAN 9. PLAN & PROFILE - 1 10. PLAN & PROFILE - 2 PP-2 DE-1 11. DETOUR PLAN 12. PAVEMENT DELINEATION & SIGNING 13. THRU 23. SHIELLS ROAD BRIDGE PLANS S-1 THRU S-11

INDEX OF SHEETS

SHEET TITLE


DRAWING NUMBER

SHEET

NUMBER

1. COVER SHEET

2. CONSTRUCTION NOTES

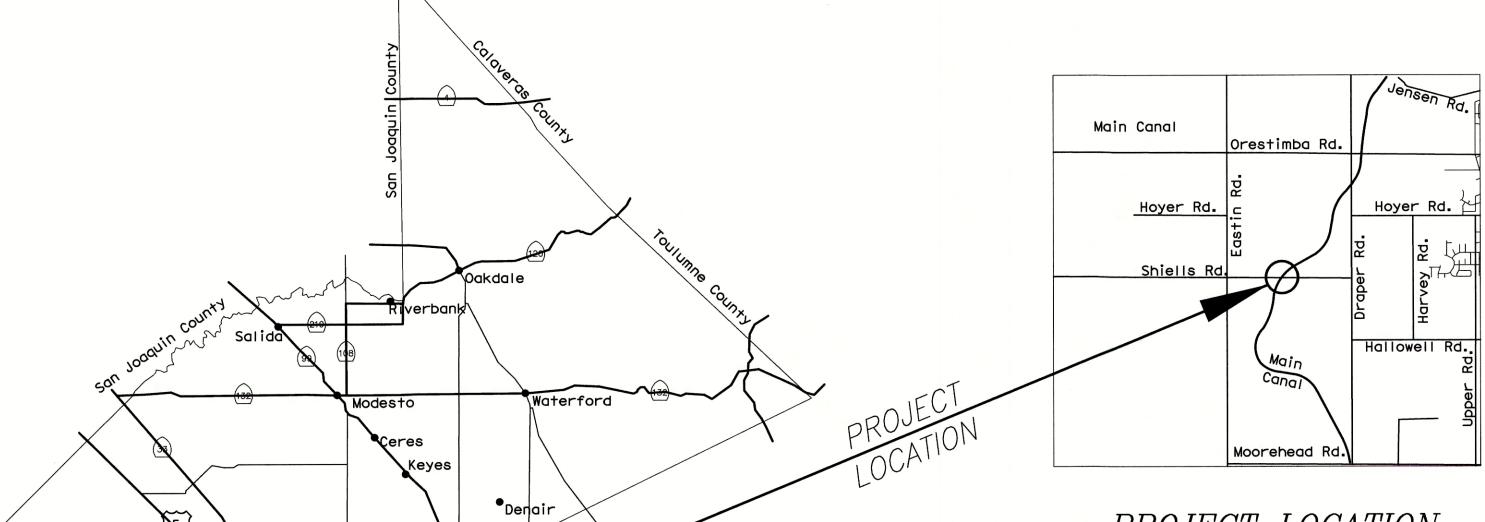

NORTH

PROJECT LOCATION

STANISLAUS COUNTY

A. MISCELLANEOUS

- 1. ALL WORK SHALL BE IN ACCORDANCE WITH THE 2010 EDITION OF STANDARD SPECIFICATIONS, STATE OF CALIFORNIA, DEPARTMENT OF TRANSPORTATION, REFERRED TO AS "STANDARD SPECIFICATIONS" AND WITH DEPARTMENT OF PUBLIC WORKS, STANISLAUS COUNTY STANDARDS AND SPECIFICATIONS 2014 EDITION. ALL IMPROVEMENTS ARE SUBJECT TO THE INSPECTION AND APPROVAL OF THE PUBLIC WORKS DEPARTMENT.
- PRIOR TO STARTING ANY WORK, THE CONTRACTOR SHALL OBTAIN A ENCROACHMENT PERMIT FROM THE STANISLAUS COUNTY DEPARTMENT OF PUBLIC WORKS. 48 HOUR ADVANCED NOTICE SHALL BE PROVIDED TO ENCROACHMENT INSPECTOR PRIOR TO STARTING ANY WORK.
- 3. CONTRACTOR SHALL ONLY USE EQUIPMENT PROVIDED WITH A SPARK ARRESTOR DEVICE TO REDUCE A POTENTIAL FIRE HAZARD.
- THE CONTRACTOR SHALL TAKE PRECAUTIONARY MEASURES TO PROTECT ALL UTILITIES. THE CONTRACTOR SHALL DO NO EXCAVATION UNTIL ALL UTILITY AGENCIES, CENTRAL CALIFORNIA IRRIGATION DISTRICT, AND THE STANISLAUS COUNTY DEPARTMENT OF PUBLIC WORKS HAVE BEEN NOTIFIED AND HAVE BEEN GIVEN THE OPPORTUNITY TO MARK THEIR FACILITIES IN THE FIELD. THE CONTRACTOR SHALL CALL U.S.A. AT LEAST FORTY-EIGHT (48) HOURS PRIOR TO DOING ANY EXCAVATING.
- CONTRACTOR SHALL PRESERVE ALL SURROUNDING PROPERTY BY CONFINING OPERATIONS TO WITHIN THE "LIMITS OF WORK".
- ALL WORK SHALL BE PERFORMED IN ACCORDANCE WITH APPLICABLE OSHA REGULATIONS.
- 7. THESE PLANS HAVE BEEN CHECKED BY THE STANISLAUS COUNTY DEPARTMENT OF PUBLIC WORKS AND/OR AUTHORIZED REPRESENTATIVE, BUT SUCH CHECKING AND/OR APPROVAL DOES NOT RELIEVE THE CONTRACTOR FROM HIS/HER RESPONSIBILITY TO CORRECT ERRORS. OMISSIONS OR MAKE CHANGES REQUIRED BY CONDITIONS DISCOVERED IN THE FIELD DURING COURSE OF CONSTRUCTION.
- THE CONTRACTOR SHALL CONTROL DUST AT ALL TIMES. DUST CONTROL SHALL BE THE RESPONSIBILITY OF THE CONTRACTOR AND SHALL BE IMPLEMENTED IN ACCORDANCE WITH APPLICABLE FEDERAL, STATE, AND LOCAL GUIDELINES (INCLUDING, BUT NOT LIMITED TO THE SAN JOAQUIN VALLEY AIR POLLUTION CONTROL DISTRICT).
- CONSTRUCTION STAKING FOR STORM DRAINS, WATER LINES, FIRE HYDRANTS, ELECTROLIERS, ETC. SHALL BE DONE UNDER THE DIRECTION OF A REGISTERED CIVIL ENGINEER OR LICENSED LAND SURVEYOR.
- 10. UNLESS OTHERWISE APPROVED, HOUSE SERVICES, FIRE HYDRANT LATERALS, GAS AND TELEPHONE LINES, AND ALL OTHER UNDERGROUND UTILITIES SHALL BE INSTALLED PRIOR TO CONSTRUCTION AND ROAD PAVING.
- 11. ALL LINES ABANDONED DURING CONSTRUCTION SHALL BE REMOVED.
- 12. ALL INDEPENDENT LABORATORY INSPECTION REQUESTED BY THE COUNTY ENGINEER SHALL BE PAID FOR BY THE CONTRACTOR.
- 13. STREET STRIPING SHALL INCLUDE STOP BARS, CENTERLINE STRIPING, AND LANE LINE MARKERS AND ALL OTHER MARKINGS REQUIRED BY THE ENGINEER. STRIPING SHALL BE DONE WITH THERMOPLASTIC AND REFLECTIVE MARKERS.
- 14. ALL TRENCHES SHALL BE BACK FILLED IN ACCORDANCE WITH STANISLAUS COUNTY SPECIFICATIONS AND IMPROVEMENTS STANDARDS.
- 15. WHEN WIDENING THE PAVEMENT ON AN EXISTING ROAD, THE EXISTING PAVEMENT SHALL BE CUT (SAW) TO A NEAT LINE AND REMOVED BACK TO AN EXISTING ADEQUATE STRUCTURAL SECTION, OR TO THE ORIGINAL ROAD SECTION. AN EXPLORATORY TRENCH, OR POT-HOLING, MAY BE REQUIRED TO DETERMINE THE LIMITS OF PAVEMENT REMOVAL.
- 16. EXISTING ROADSIDE FACILITIES WITHIN THE PROJECT LIMITS THAT ARE DAMAGED OR DISPLACED, EVEN THOUGH THEY WERE NOT TO BE REMOVED, SHALL BE REPAIRED OR REPLACED PER STANISLAUS COUNTY STANDARDS.
- 17. ASBESTOS CEMENT PIPE (ACP) OR FITTINGS SHALL NOT BE USED.
- 18. PRIOR TO TRENCHING FOR STORM DRAIN PIPE, THE CONTRACTOR SHALL VERIFY, IN THE FIELD, THE SIZE AND LOCATION OF EXISTING PIPE AT THE POINT OF CONNECTION. ANY DEVIATION FROM THE PLANS SHALL BE RESOLVED BY THE DESIGN ENGINEER AND APPROVED BY THE COUNTY PRIOR TO TRENCHING.
- 19. MANHOLES, VALVES, CLEAN OUTS, ETC. SHALL BE BROUGHT TO FINISH GRADE BY THE CONTRACTOR AFTER THE FINAL PAVING COURSE IS PLACED.
- 20. STORM DRAIN PIPE SIZES SHALL NOT BE CHANGED WITHOUT THE APPROVAL OF STANISLAUS COUNTY.
- 21. ALL TREES TO REMAIN SHALL BE PRESERVED AND PROTECTED BY ERECTING A 48" HIGH ORANGE CONSTRUCTION FENCE AROUND THE TREE TRUNK PRIOR TO STARTING WORK ON THE SITE.
- 22. ALL CONSTRUCTION SITE ACTIVITIES SHALL CONFORM TO THE STATE WATER RESOURCES CONTROL BOARD, NATIONAL POLLUTION DISCHARGE ELIMINATION SYSTEM (NPDES), WASTE DISCHARGE REQUIREMENTS FOR DISCHARGES OF STORM WATER RUNOFF ASSOCIATED WITH CONSTRUCTION ACTIVITY.
- 23. AN APPROVED SWPPP SHALL BE SUBMITTED TO THE COUNTY AND MUST BE ON-SITE DURING ALL CONSTRUCTION ACTIVITIES.
- 24. CONTRACTOR'S OPERATIONS SHALL BE PERFORMED IN A MANNER WHICH WILL NOT ALLOW HARMFUL POLLUTANTS TO ENTER THE CCID MAIN CANAL. CONTRACTOR SHALL IMPLEMENT APPROPRIATE BEST MANAGEMENT PRACTICES (BMP'S) AS INDICATED IN THE SPECIFICATIONS AND AS REQUIRED BY STANISLAUS COUNTY.
- 25. PRIOR TO INITIATING ANY CONSTRUCTION, THE CONTRACTOR SHALL VERIFY THAT ALL NECESSARY FEDERAL, STATE, AND LOCAL PERMITS AND/OR AUTHORIZATIONS HAVE BEEN OBTAINED.
- 26. THE CONTRACTOR SHALL NOTIFY THE CENTRAL CALIFORNIA IRRIGATION DISTRICT (CCID) OF WORK COMMENCEMENT A MINIMUM OF 48 HOURS PRIOR TO THE START OF MOBILIZATION.
- 27. ALL WORK WITHIN THE PROPERTY OF CENTRAL CALIFORNIA IRRIGATION DISTRICT SHALL BE PERFORMED IN ACCORDANCE WITH THE CONDITIONS SET FORTH IN THE LICENSE AGREEMENT MADE BETWEEN THE COUNTY OF STANISLAUS AND CCID.

B. DEMOLITION

- 1. DEBRIS GENERATED FROM DEMOLITION WORK TO BE DISPOSED OF OFF-SITE, AT AN APPROVED LOCATION, AT THE CONTRACTOR'S EXPENSE.
- 2. CLEARING AND GRUBBING SHALL CONFORM TO THE PROVISIONS IN SECTION 16, "CLEARING AND GRUBBING." OF THE STANDARD SPECIFICATIONS.

C. SITE WORK

CCID

CIP

EG

EVC

Thd

Tot

Тур

Var

EXPANSION

FINISH GRADE

HINGE POINT

LEFT

MAXIMUM

MINIMUM NEW

NORTH

NUMBER

OFFSET

RADIUS

RIGHT

SOUTH

TOTAL

TYPICAL

VARIES

WEST WINGWALL

VERTICAL CURVE

STATION

THREADED

PROPOSED

NOT TO SCALE

PROPERTY LINE

POINT/POST TENSIONED

ROCK SLOPE PROTECTION

UNLESS OTHERWISE NOTED

POINT OF VERTEX/INTERSECTION OF TANGENTS

TEMPORARY CONSTRUCTION EASEMENT

PRESTRESSED

REINFORCED

RIGHT OF WAY


ORIGINAL GRADE

HOT MIX ASPHALT (TYPE A)

- 1. EARTHWORK SHALL CONFORM TO THE PROVISIONS IN SECTION 19, "EARTHWORK," OF THE STANDARD SPECIFICATIONS. ROADWAY EXCAVATION SHALL CONFORM TO THE PROVISIONS IN SECTION 19-2, "ROADWAY EXCAVATION," OF THE STANDARD SPECIFICATIONS.
- 2. SUBGRADE SHALL BE COMPACTED TO 95% RELATIVE COMPACTION AND CONFORM TO SECTION 26 OF THE STANDARD SPECIFICATIONS.
- 3. HOT MIX ASPHALT SHALL BE TYPE A, 1/2" AGGREGATE CONFORMING TO SECTION 39 OF THE STANDARD SPECIFICATIONS. THE RELATIVE COMPACTION SHALL BE 95%.
- 4. SAWCUT AT ALL PAVEMENT CONFORMS. PROVIDE A NEAT, CLEAN EDGE.
- AGGREGATE BASE SHALL BE CLASS 2, WITH DEPTH AS SPECIFIED PER PLAN AND SHALL CONFORM TO THE PROVISIONS IN SECTION 26, "AGGREGATE BASES," OF THE STANDARD SPECIFICATIONS.
- 6. DEBRIS GENERATED BY CLEARING, GRUBBING, EXCAVATION AND DEMOLITION WORK SHALL BE DISPOSED OF OFF-SITE AT APPROVED DISPOSAL SITES AT THE CONTRACTOR'S EXPENSE.

ABBREVIATIONS

DITE VIA HONO	LLGLIND
AGGREGATE BASE	
ASPHALT CONCRETE AGGREGATE SUBBASE	_··-
BEGIN BRIDGE BEGIN HORIZONTAL CURVE	——————————————————————————————————————
BEGIN VERTICAL CURVE CENTRAL CALIFORNIA IRRIGATION DISTI	RICT E
CAST—IN—PLACE CENTER LINE	——————————————————————————————————————
CLASS CLEAR	——————————————————————————————————————
CONTINUOUS EAST	— - c — - c — - c —
EXISTING END BRIDGE	
END HORIZONTAL CURVE EDGE OF GRADE LINE	
ELEVATION EDGE OF PAVEMENT	
EDGE OF TRAVEL LANE END VERTICAL CURVE	

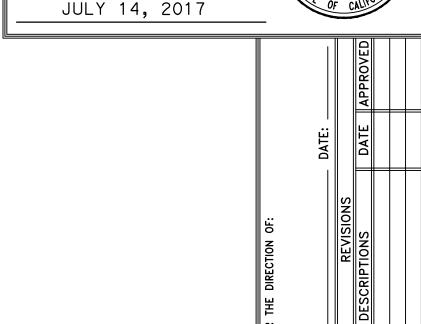

SUBMITTED:

Exp. 12-31-17



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JOB NO SAB048800 DATE <u>7/14/</u>17 DR BY BW

CK BY BW SCALE AS SHOWN

SHEET NUMBER

OF 23 SHEETS

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I FGFND

P/L OR ROW

LIMIT OF WORK

EXISTING UNDERGROUND LINE

PROPOSED STORM DRAIN LINE

EXISTING OVERHEAD FLECTRICAL LINE

FILL LINE

CUT LINE

GRADE BREAK

G OF DRAINAGE SWALE


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SHIELLS ROAD - TYPICAL SECTION 1

(NOTE 2), Typ


1.50 AB

"S" STA: 2+90.00 TO 5+53.35 "S" STA. 6+88.35 TO 10+50.00 (NTS)

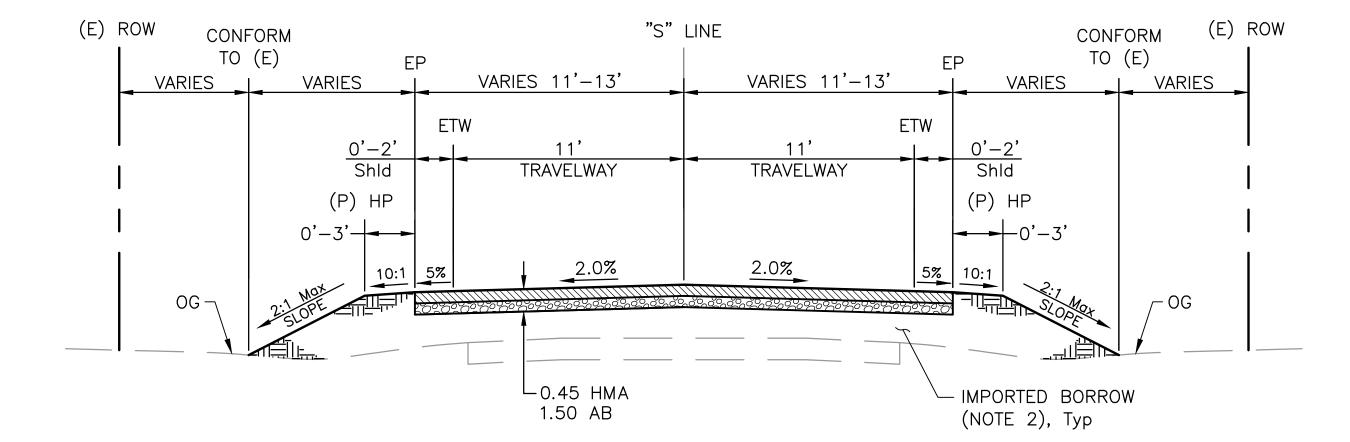

SHIELLS ROAD - TYPICAL SECTION 2

"S" STA: 5+53.35 TO 5+83.35 "S" STA. 6+58.35 TO 6+88.35 (NTS)

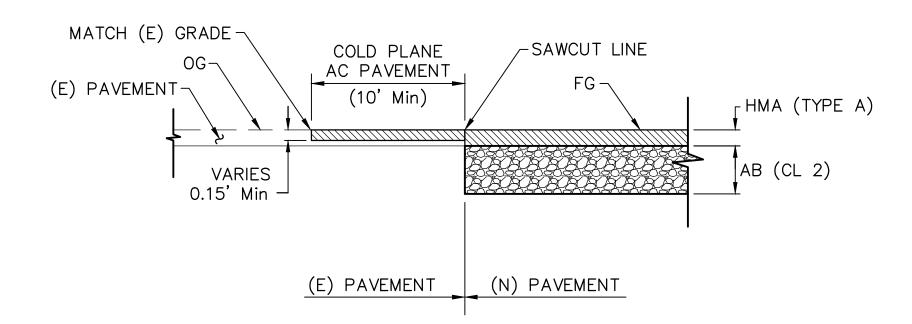

TYPICAL CONFORM DETAIL

(NTS)

SUBMITTED:

JULY 14, 2017

		STRUCTURE PAVEMENT SECTION (ft)					
TI R-VALUE		OPTION 1	OPTION 1 OPTION 2		OPTION 3		
		FULL-DEPTH HMA	НМА	AB	НМА	AB	AS
9	15	1.10	0.45	1.50	0.75	0.75	0.80

MAY BE ADJUSTED UPON WRITTEN APPROVAL FROM COUNTY ENGINEER.

2. CONTRACTOR SHALL USE THE PREFERRED PAVEMENT SECTION OPTION 2, AS REPRESENTED IN PLANS AND ESTIMATE. HOWEVER, IF CONTRACTOR PREFERS TO USE A DIFFERENT OPTION, WRITTEN APPROVAL MUST BE FIRST OBTAIN BY THE ENGINEER.

HMA: HOT MIX ASPHALT (TYPE A)

AB: AGGREGATE BASE (CLASS 2) WITH R-VALUE EQUAL TO 78

AS: AGGREGATE SUB-BASE (CLASS 2) WITH R-VALUE EQUAL TO 50

LEGEND:

HOT MIX ASPHALT (TYPE A)

AGGREGATE BASE (CL2) IMPORTED BORROW

NOTES:

- 1. FOR GENERAL NOTES & ABBREVIATIONS, SEE SHEET C-1.
- 2. CONTRACTOR SHALL COMPACT UPPER 0.5' OF SUBGRADE SOIL BELOW PAVEMENT SECTION TO 95% RELATIVE COMPACTION.
- 3. SINCE THE IMPORT FILL MATERIAL WILL BE BROUGHT IN FOR APPROACH EMBANKMENT, IT IS RECOMMENDED TO USE AN R-VALUE OF 15 FOR PAVEMENT DESIGN. THE IMPORT FILL SHOULD HAVE A MINIMUM R-VALUE OF 15.
- 4. THE MATERIALS (HMA, AB AND AS) TO BE USED AND THEIR PLACEMENT AND COMPACTION SHOULD COMPLY WITH THE REQUIREMENTS OF CALTRANS STANDARD SPECIFICATIONS (2010).



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SHIELLS ROAD BRIDGE REPLACEMENT

JOB NO SAB048800

SCALE AS SHOWN

X-1

SHEET NUMBER


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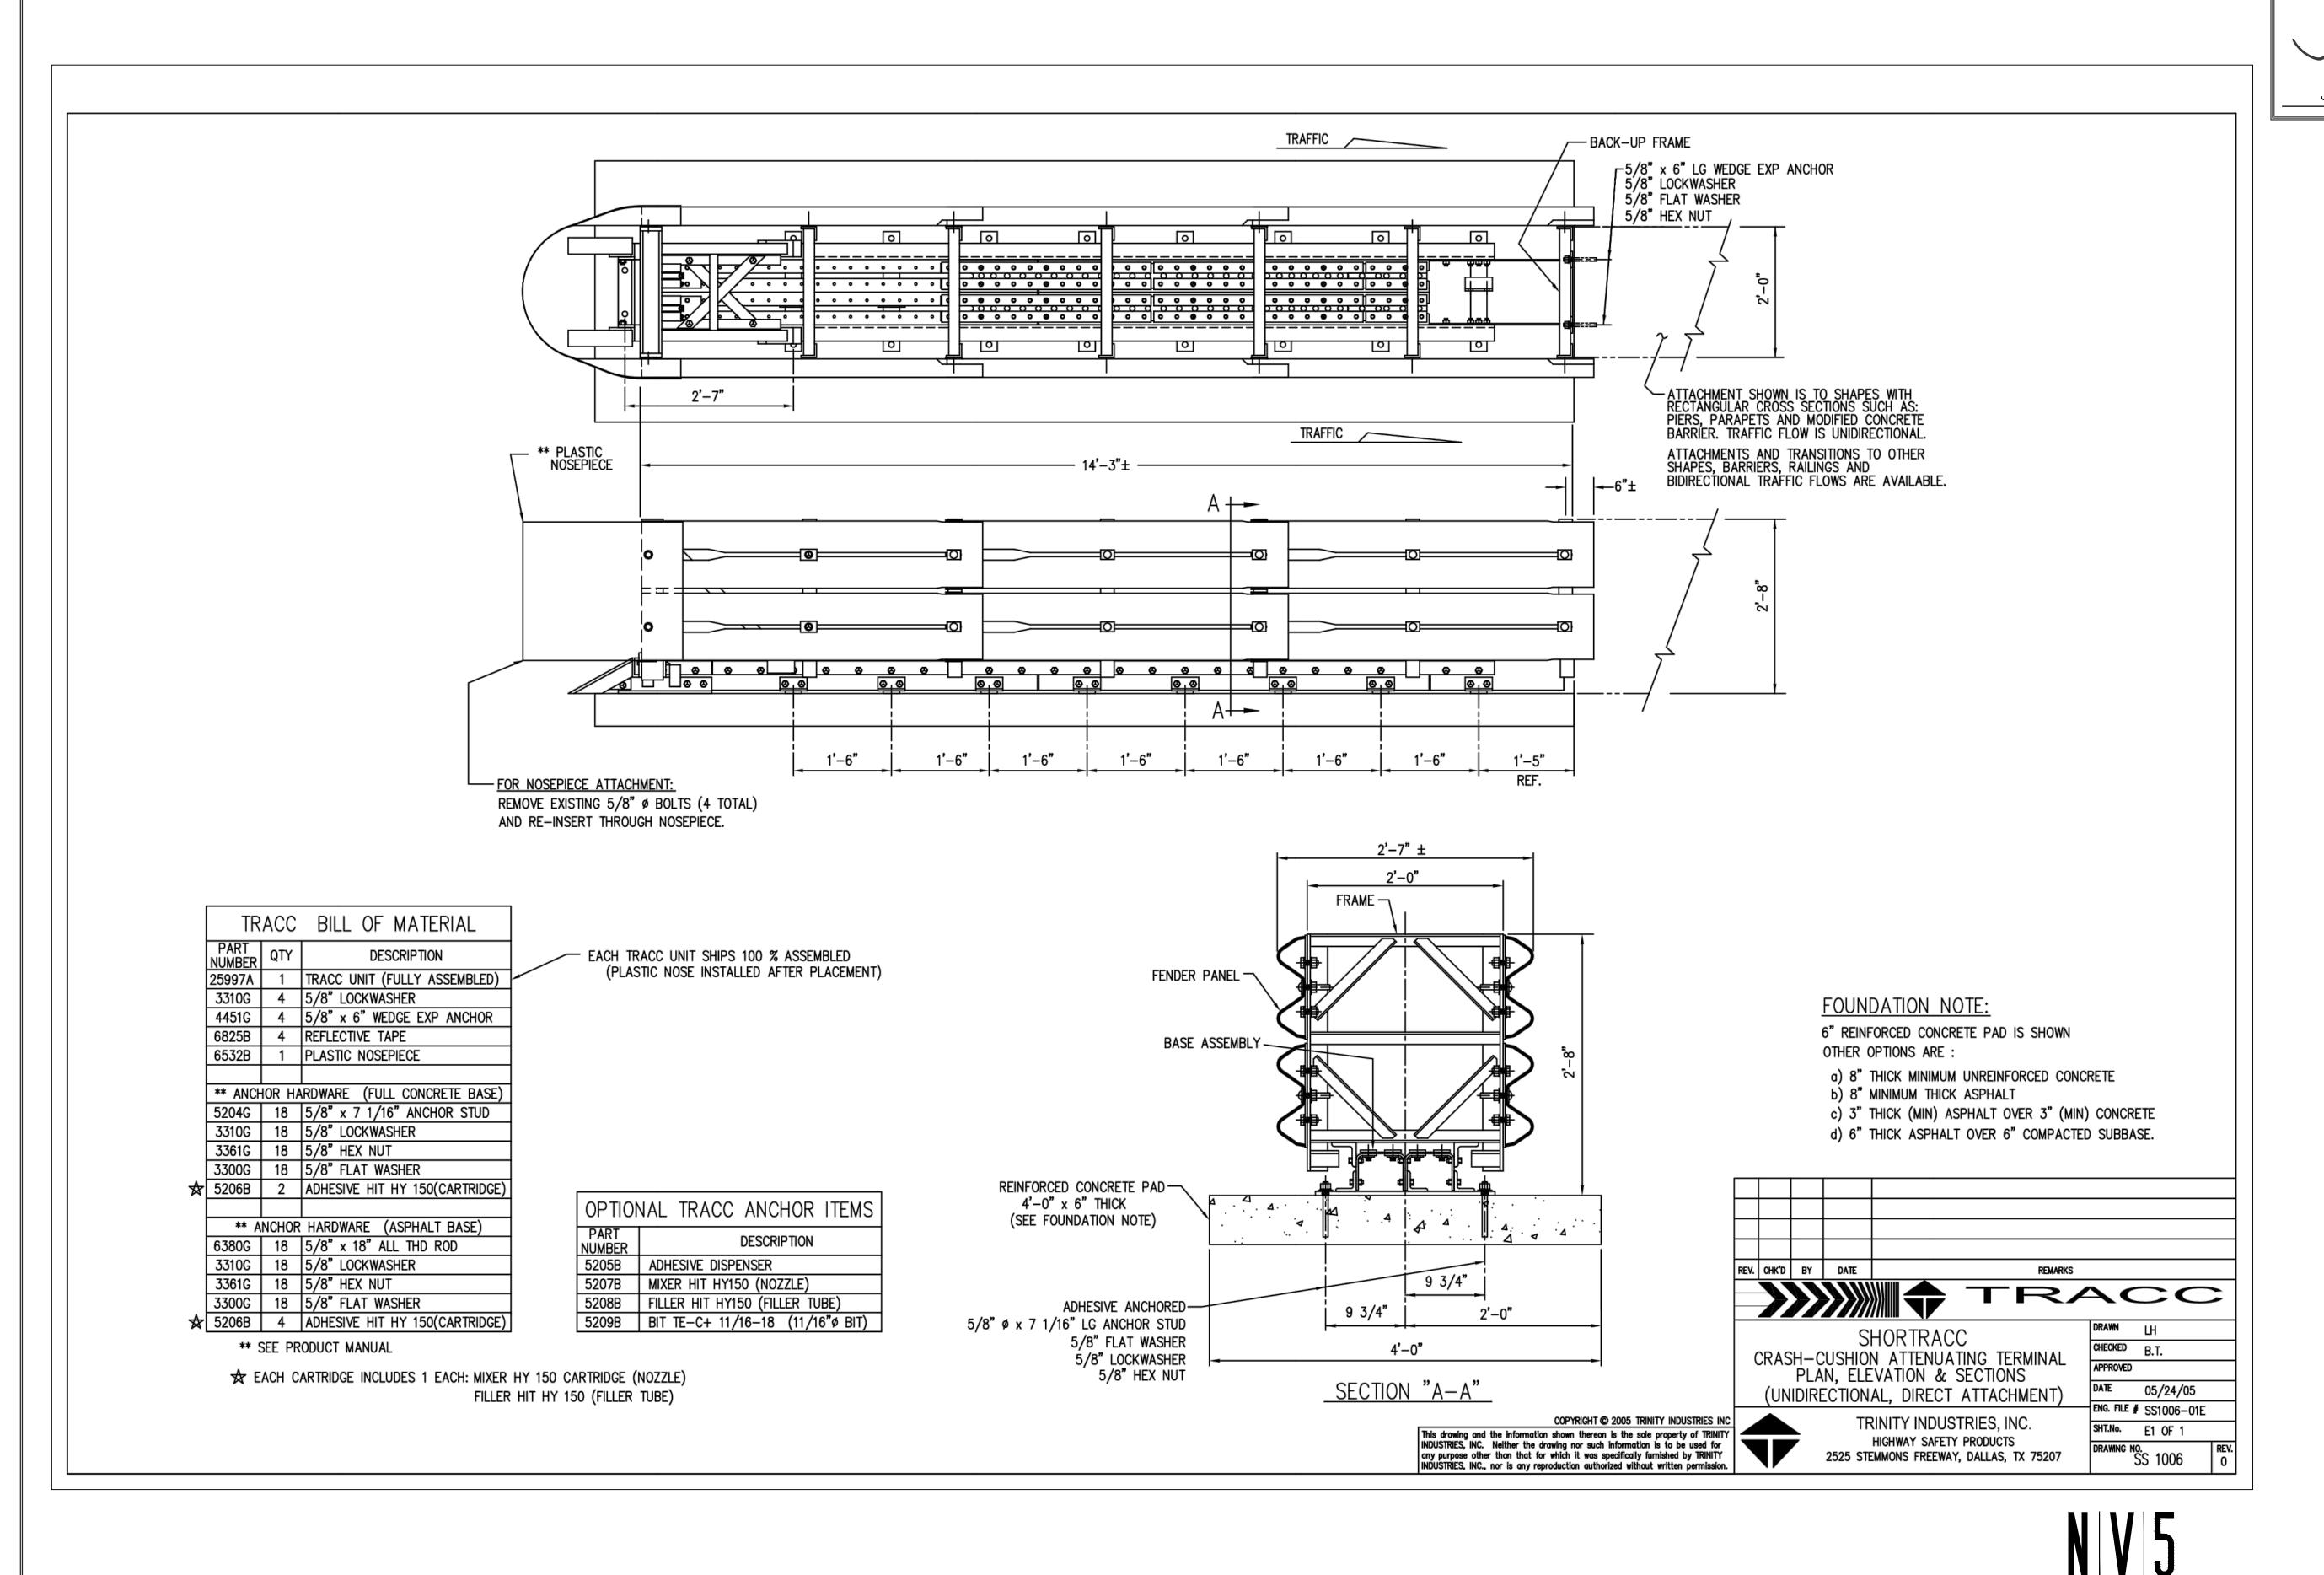
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DETAILS

\$

SECTIONS



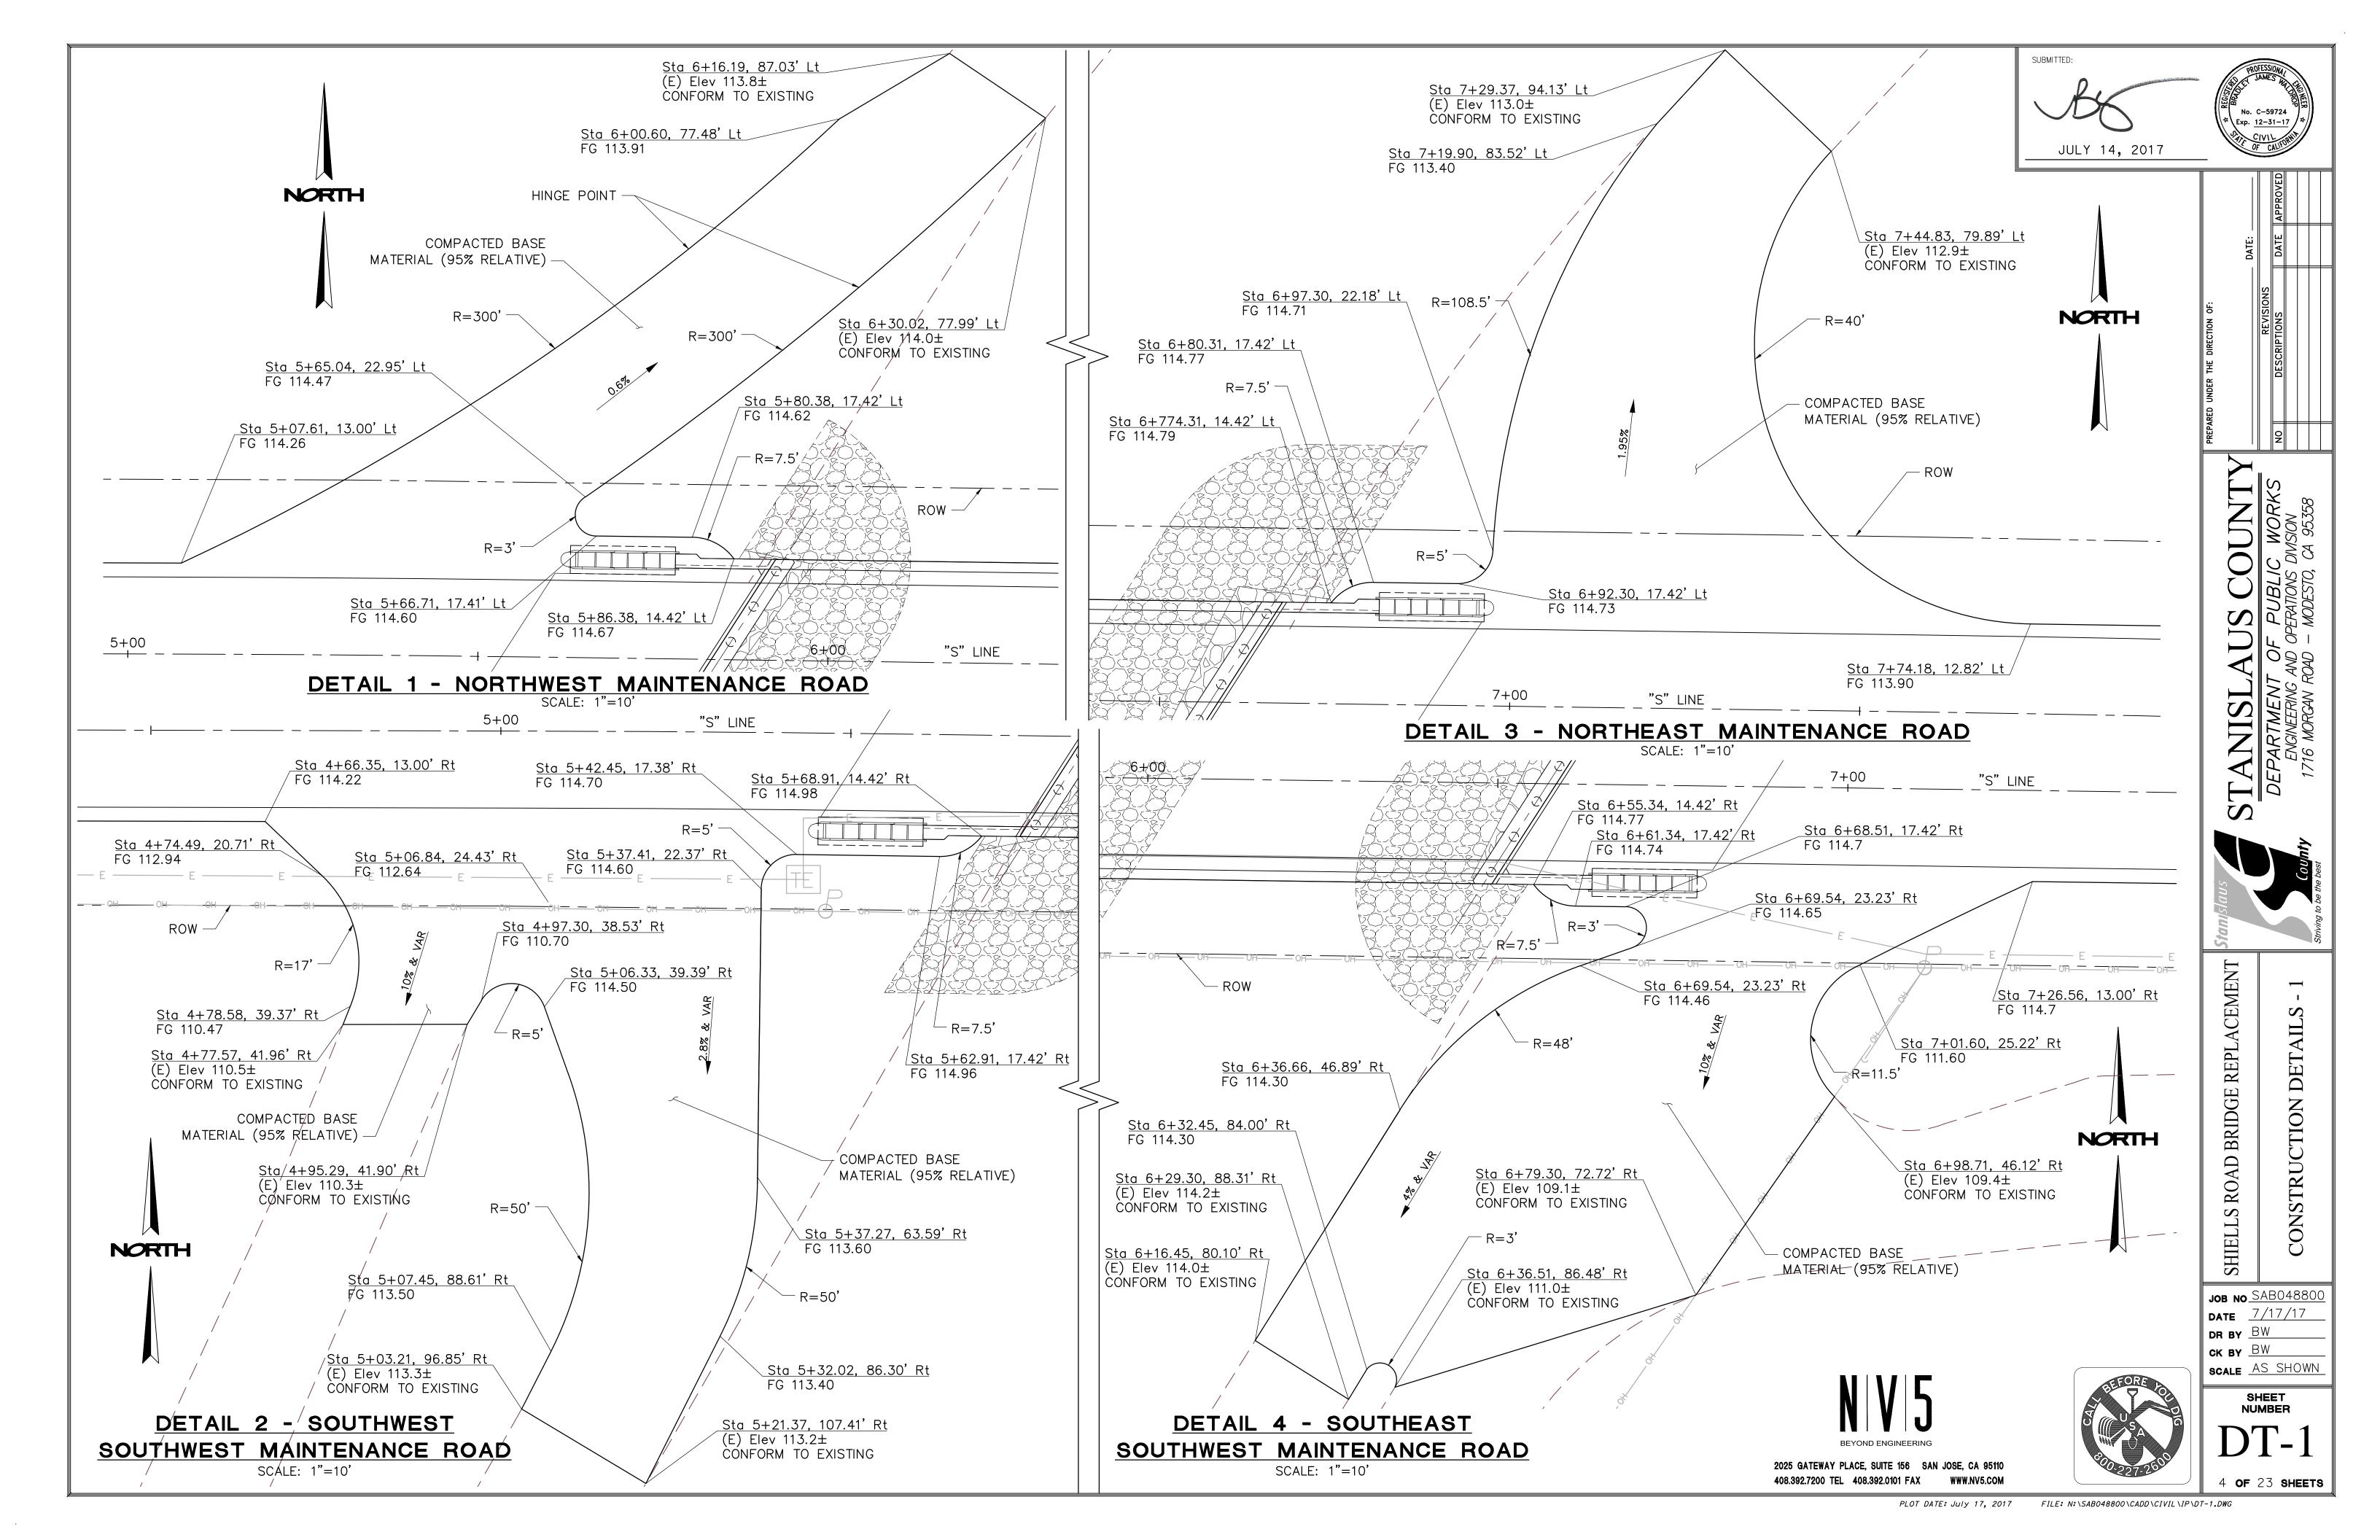

SUBMITTED: JULY 14, 2017

BRIDGE REPLACEMENT DETAIL CONSTRUCTION ROAD

SHIELLS JOB NO SAB048800 DATE <u>7/14/17</u> DR BY BW


ск ву <u>BW</u> SCALE AS SHOWN

> SHEET NUMBER

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SUBMITTED: JULY 14, 2017



SHIELLS ROAD BRIDGE REPLACEMENT

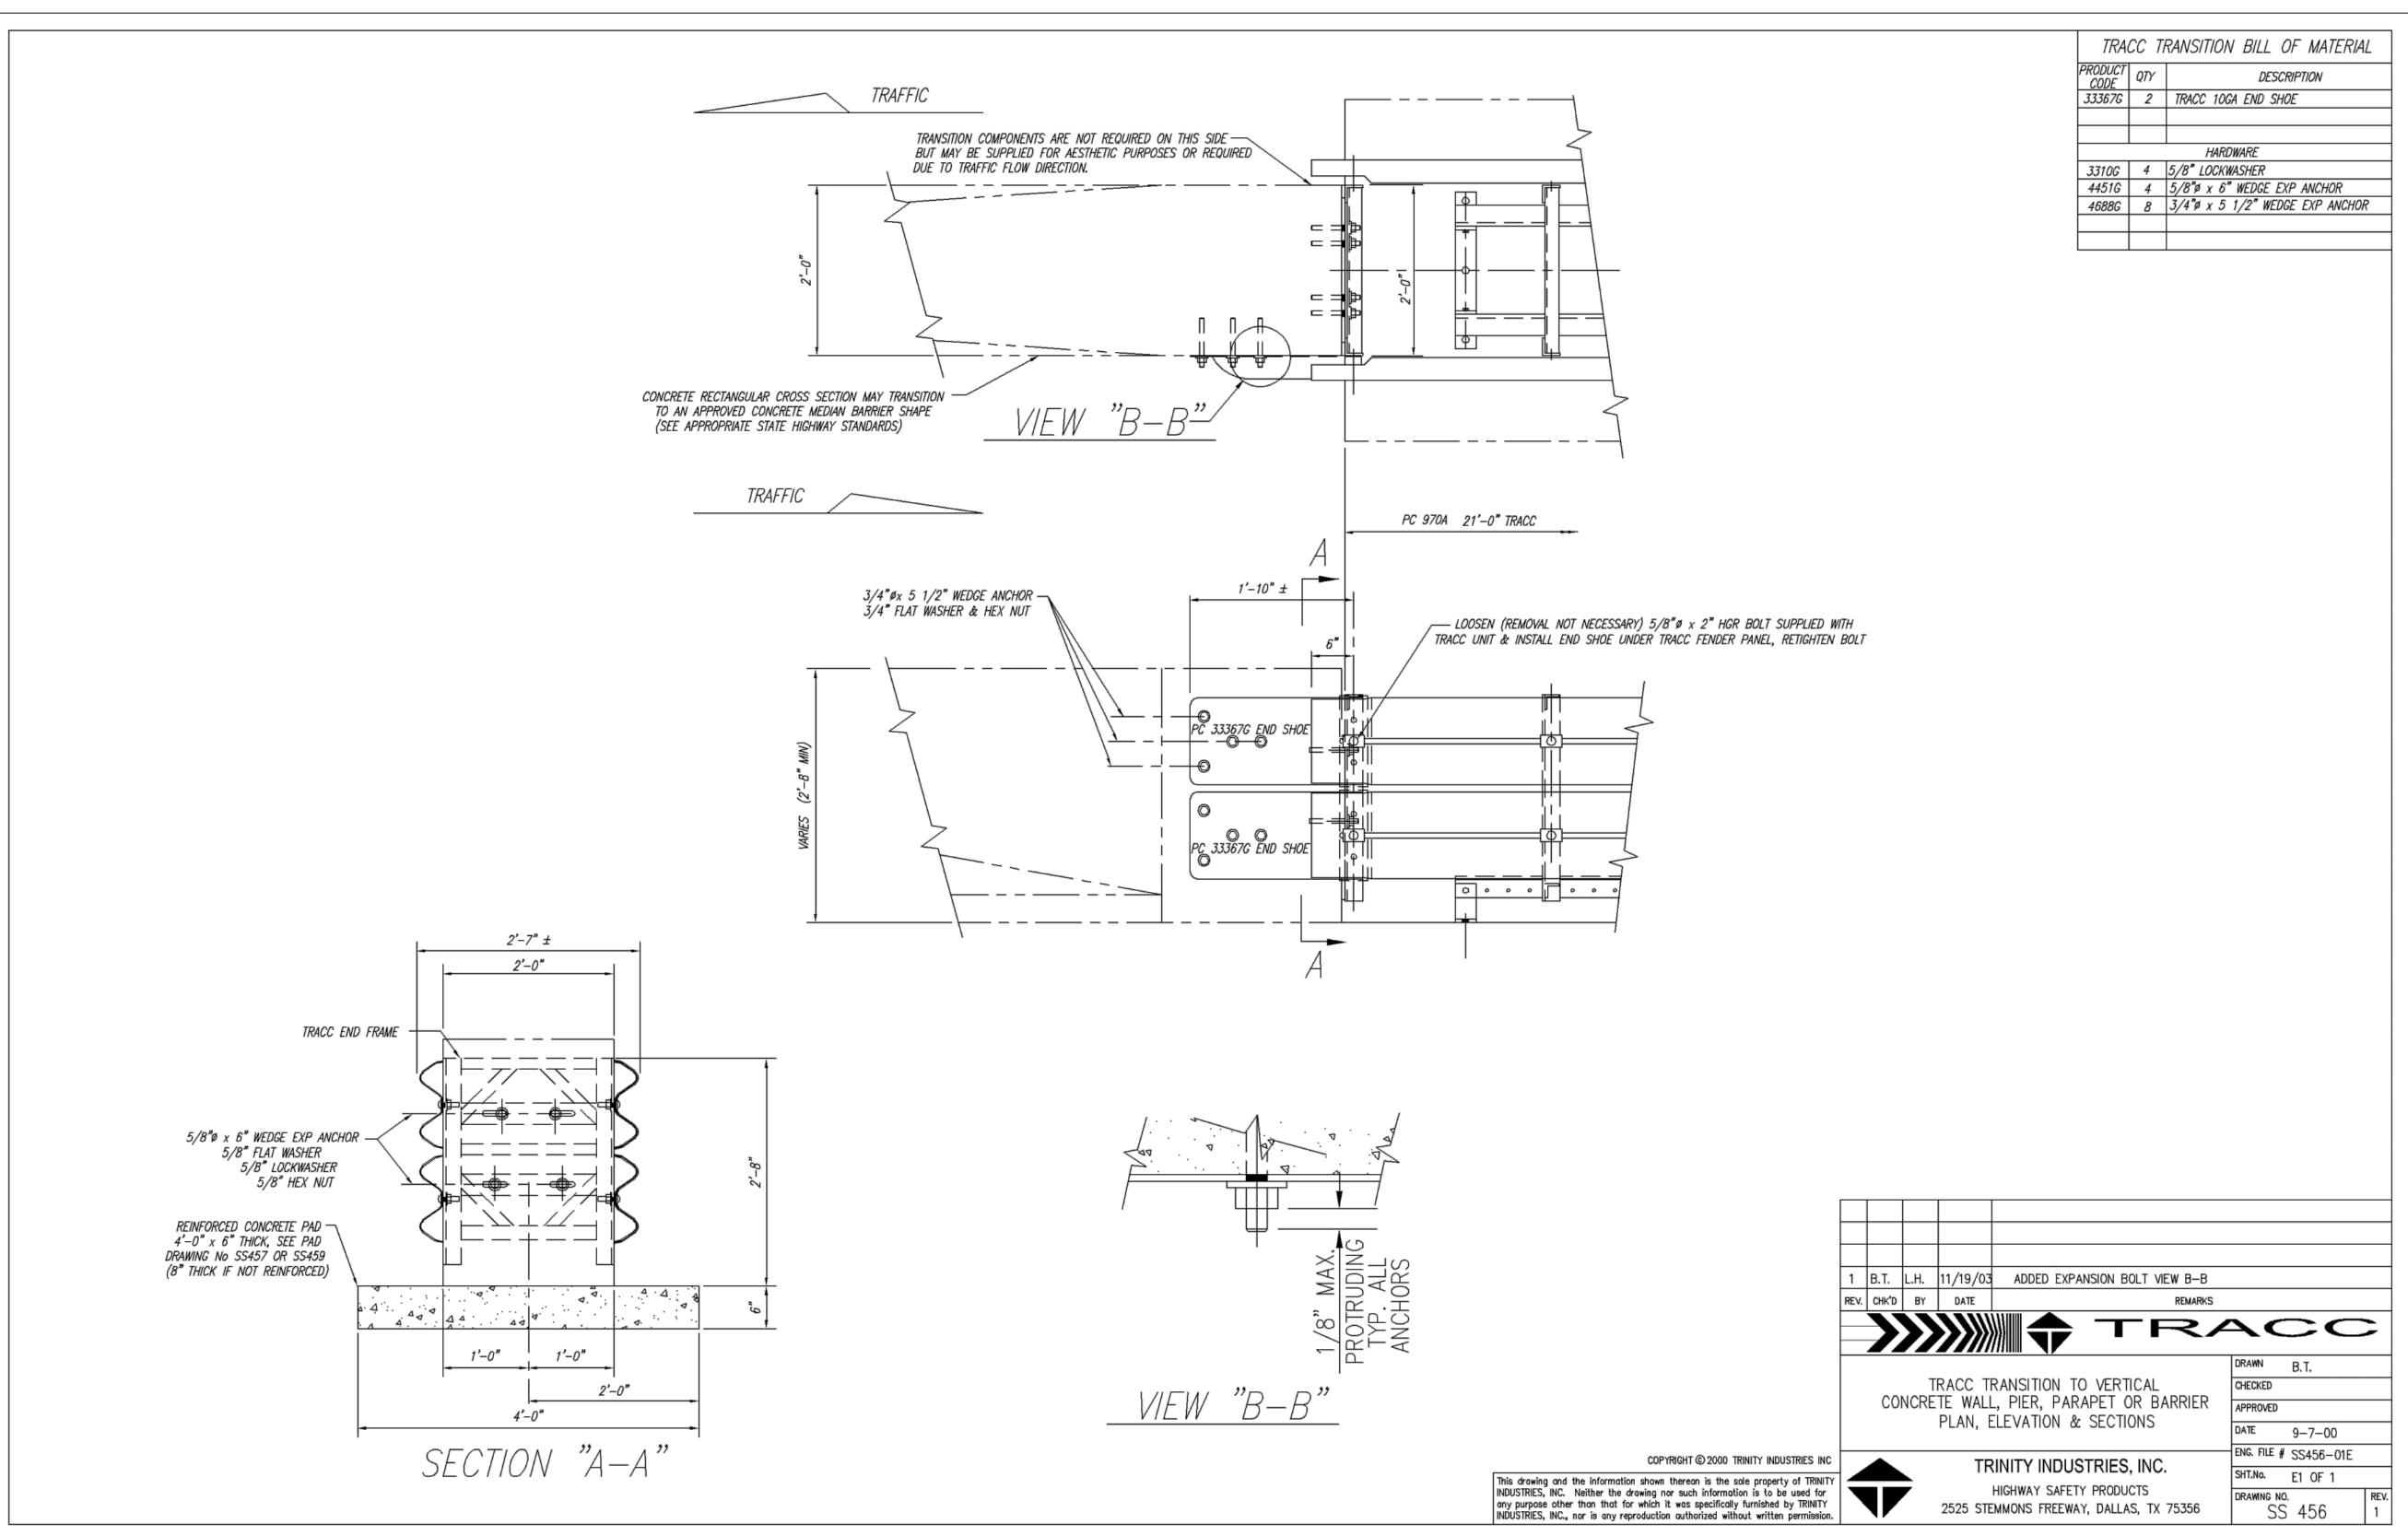DETAILS

CONSTRUCTION


JOB NO SAB048800 DATE <u>7/14/17</u> DR BY BW

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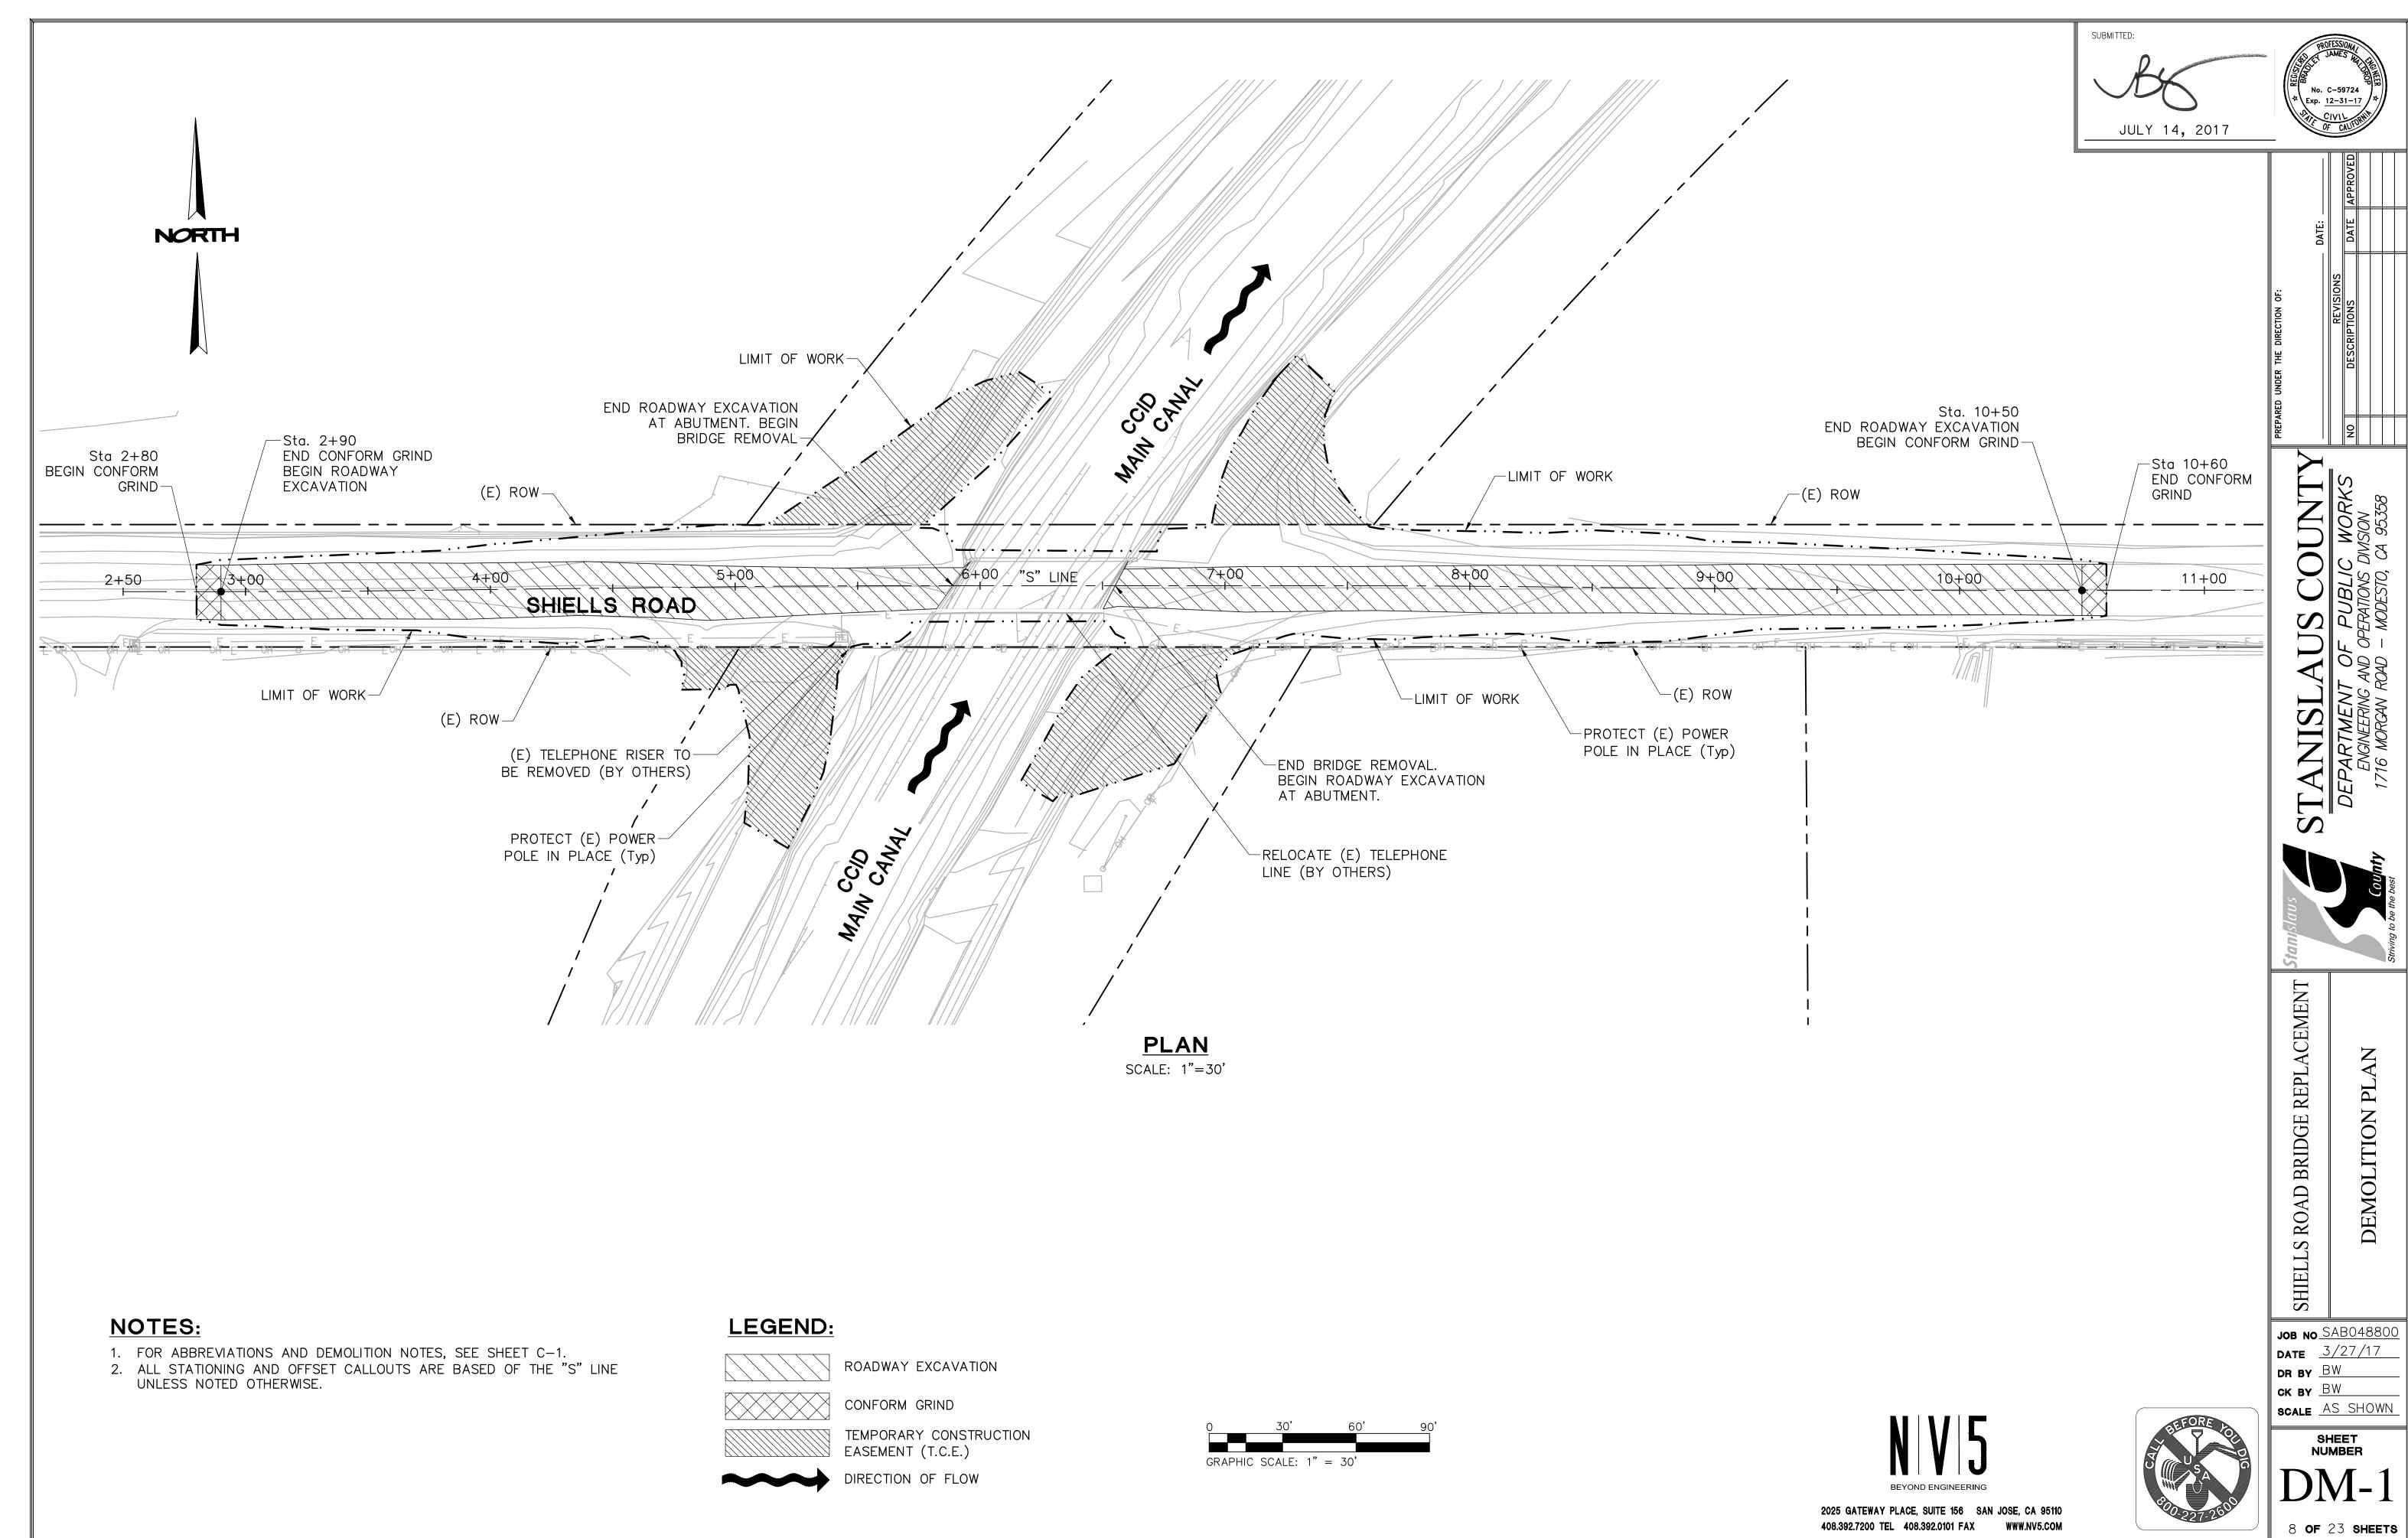
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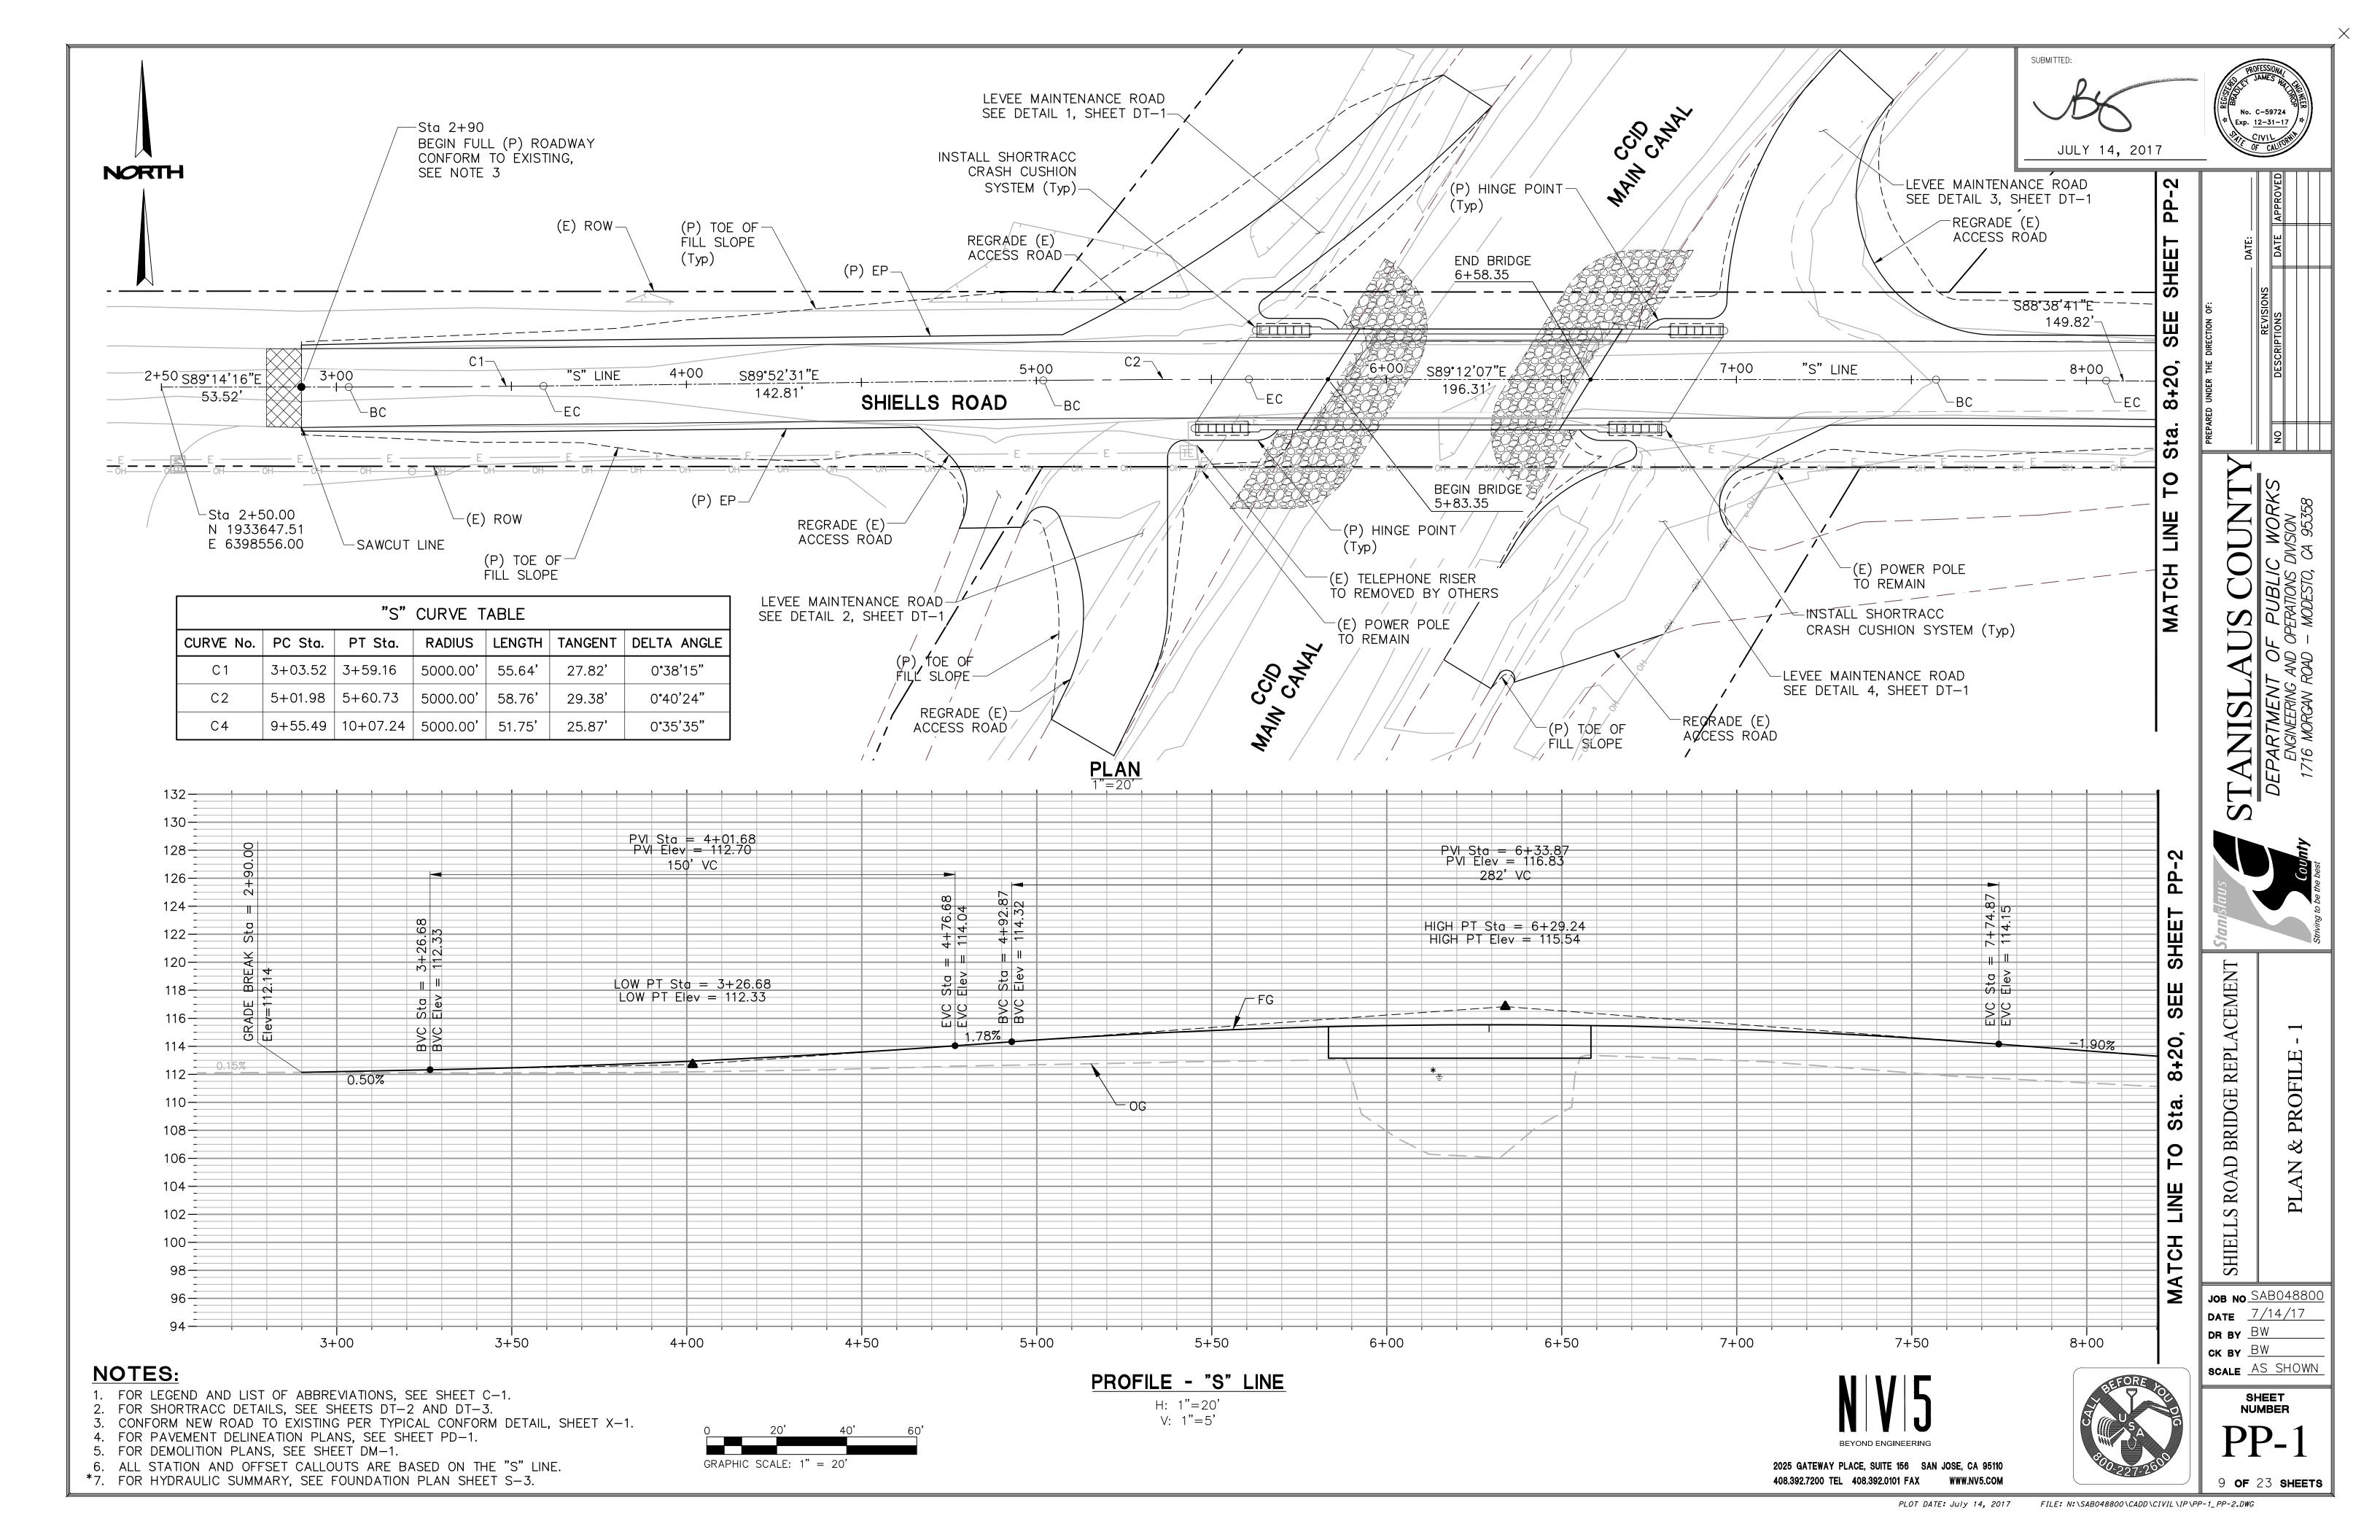
SHEET NUMBER

6 **OF** 23 **SHEETS**



PLOT DATE: July 14, 2017 FILE: N:\SAB048800\CADD\CIVIL\IP\DT-4.DWG

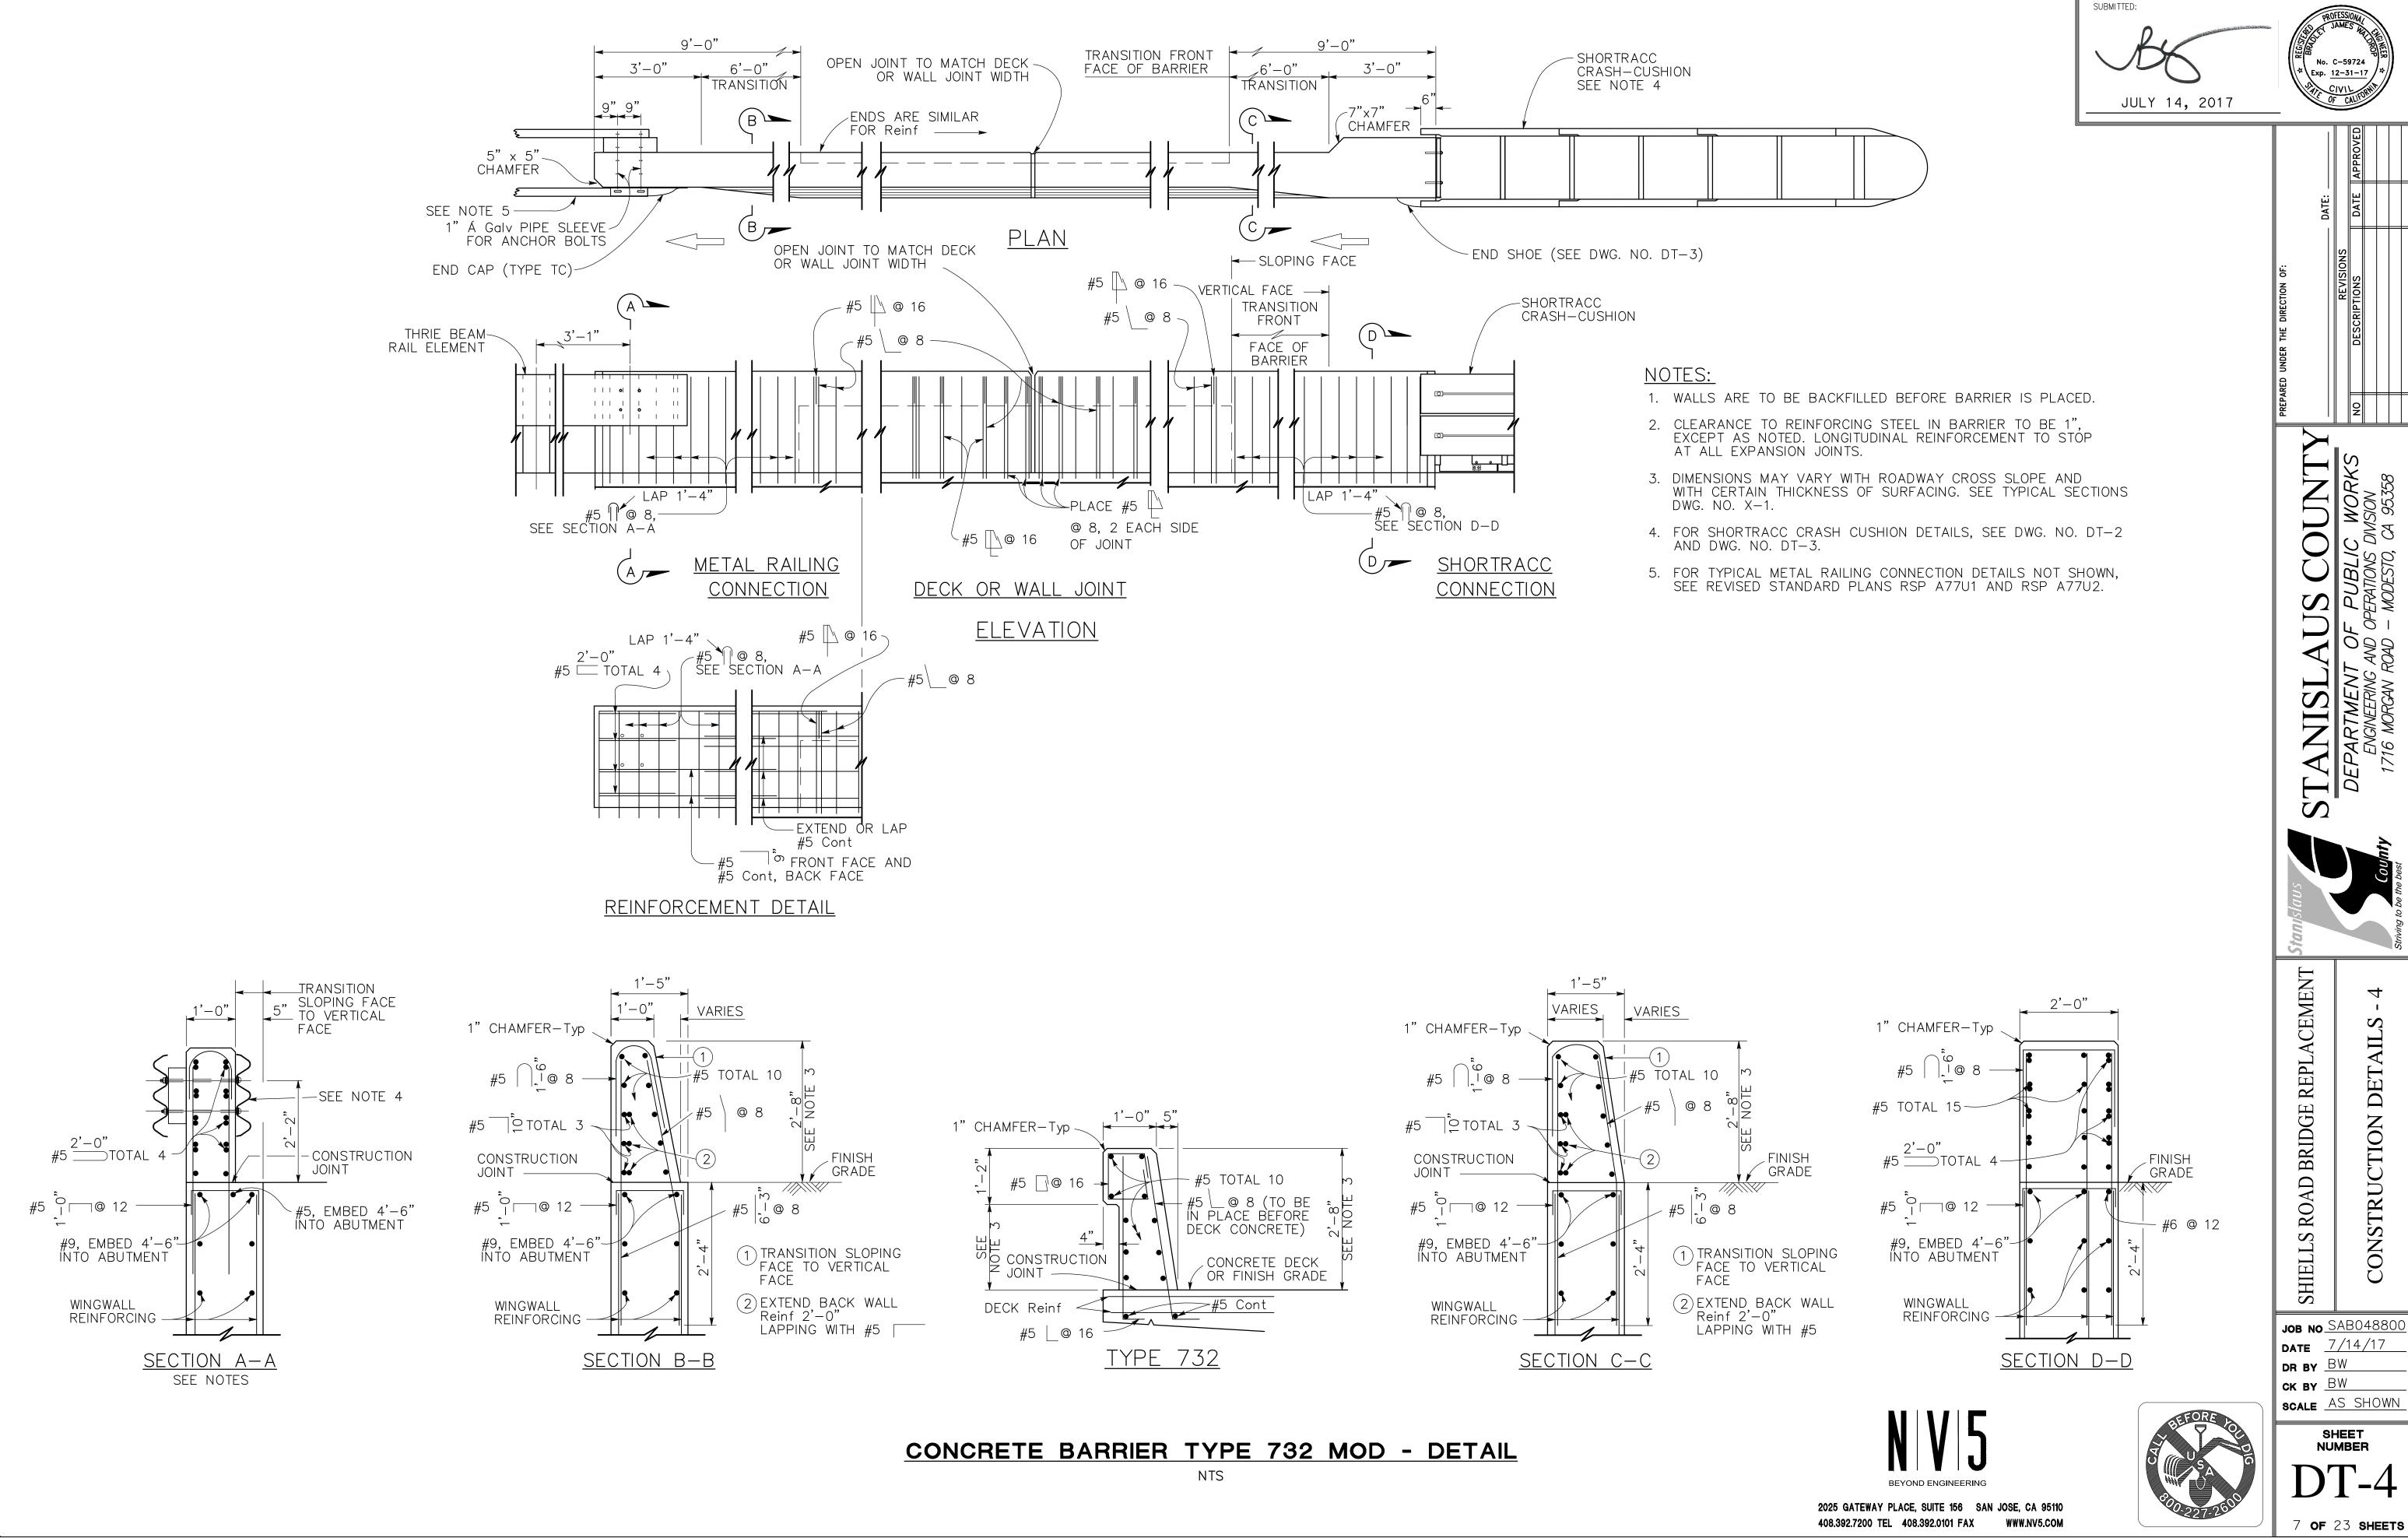



PP-1 NORTH —Sta 10+50 SHEET END FULL (P) ROADWAY −(E) ROW CONFORM TO EXISTING, SEE NOTE 3 (P) TOE OF FILL SLOPE _(P) EP SEE 8+20, 9+00 S88°38'41"E 10+00 "S" LINE S89°14'16"E 11+00 11+75.32 149.82 168.08 SHIELLS ROAD Sta —Sta 11+75.32— N 1933646.80 E 6398609.52 SAWCUT LINE __(E) ROW

—(P) TOE OF

FILL SLOPE (Typ)

	"S" CURVE TABLE							
CURVE No.	PC Sta.	PT Sta.	RADIUS	LENGTH	TANGENT	DELTA ANGLE		
C1	3+03.52	3+59.16	5000.00'	55.64'	27.82'	0°38'15"		
C2	5+01.98	5+60.73	5000.00'	58.76'	29.38'	0°40'24"		
C 4	9+55.49	10+07.24	5000.00'	51.75'	25.87'	0°35'35"		

PLAN 1"=20' -130 PVI Sta = 9+78.30 PVI Elev = 110.29 120' VC -124 SHEET -122 -120 SEE Sta LOW PT Sta = 10+38.30 LOW PT Elev = 109.66 +20, BVC BVC -114 _1.90% -112 Sta. -110 -1.05% 10 _ _106 IATCH -100 -98 8+50 9+50 10+00 10+50 11+50 11+75 9+00 11 + 00

GRAPHIC SCALE: 1" = 20'

NOTES:

1. FOR LEGEND AND LIST OF ABBREVIATIONS, SEE SHEET C-1. 2. CONFORM NEW ROAD TO EXISTING PER TYPICAL CONFORM DETAIL, SHEET X-1.

MATCH

3. FOR PAVEMENT DELINEATION PLANS, SEE SHEET PD-1. 4. FOR DEMOLITION PLANS, SEE SHEET DM-1.

5. ALL STATION AND OFFSET CALLOUTS ARE BASED ON THE "S" LINE.

PROFILE - "S" LINE

H: 1"=20' V: 1"=5'



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SHEET NUMBER 10 **of** 23 **SHEETS**

BRIDGE REPLACEMENT

SHIELLS

DR BY BW

ск ву <u>BW</u>

JOB NO SAB048800 DATE <u>7/14/17</u>

SCALE AS SHOWN

PROFILE

8

DETOUR SIGNS								
LOCATION NUMBER	SIGN CODE	PANEL SIZE	No. OF POSTS & SIZE	No. OF SIGNS	SIGN MESSAGE			
1	M4-10	48"×18"	2-4"x4"	10	DETOUR ARROW			
2	SC3 (CA)	48"x18"	2-4"x4"	4	DETOUR WITH ARROW			
3	M4-8a	24"x18"	1-4"x4"	2	END DETOUR			
4	R11-2	48"×30"		2	ROAD CLOSED			
5	W20-3	48"×48"	1-4"x4"	2	ROAD CLOSED AHEAD			
6	SPECIAL "A"	48"×48"	1-4"×4"	6	SHIELLS ROAD CLOSED BETWEEN EASTIN ROAD AND DRAPER ROAD USE DETOUR			
7)	SPECIAL "B"	60"×30"	2-4"×4"	2	ROAD CLOSED 1/2 MILE AHEAD			

NOTES:

HOYER ROAD

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(Lt) 1

- 1. DURING CONSTRUCTION OF BRIDGE, VEHICULAR TRAFFIC SHALL BE DIRECTED TO THE DETOUR AS SHOWN ON THE PLAN FOR THE DURATION OF THE PROJECT.
- 2. SIGN LOCATIONS ARE APPROXIMATE. EXACT LOCATIONS TO BE DETERMINED BY THE ENGINEER.

3. FOR TYPE III BARRICADE DETAILS, SEE CALTRANS STANDARD PLAN A73C.

SHIELLS ROAD CLOSED BETWEEN EASTIN ROAD AND DRAPER ROAD USE DETOUR

SPECIAL "A"

(BLACK LETTERS ON ORANGE BACKGROUND)

ROAD CLOSED 1/2 MILE AHEAD LOCAL TRAFFIC ONLY

SPECIAL "B"

(BLACK LETTERS ON ORANGE BACKGROUND)

2025 GATEWAY PLACE, SUITE 156 SAN JOSE, CA 95110



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SHIELLS ROAD BRIDGE REPLACEMENT

JOB NO <u>SAB048800</u> DATE 7/14/17

SHEET NUMBER

DE-1

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LOCAL TRAFFIC ONLY

11 **of** 23 **sheets** PLOT DATE: July 14, 2017 FILE: N:\SABO48800\CADD\CIVIL\IP\DE-1.DWG

CONSTRUCTION AREA: — ROADWAY PORTION TO BE CLOSED SHIELLS ROAD SHIELLS ROAD

TYPE III BARRICADE

<u>PLAN</u>


NOT TO SCALE

ORESTIMBA ROAD

NORTH

HOYER ROAD

(Lt)

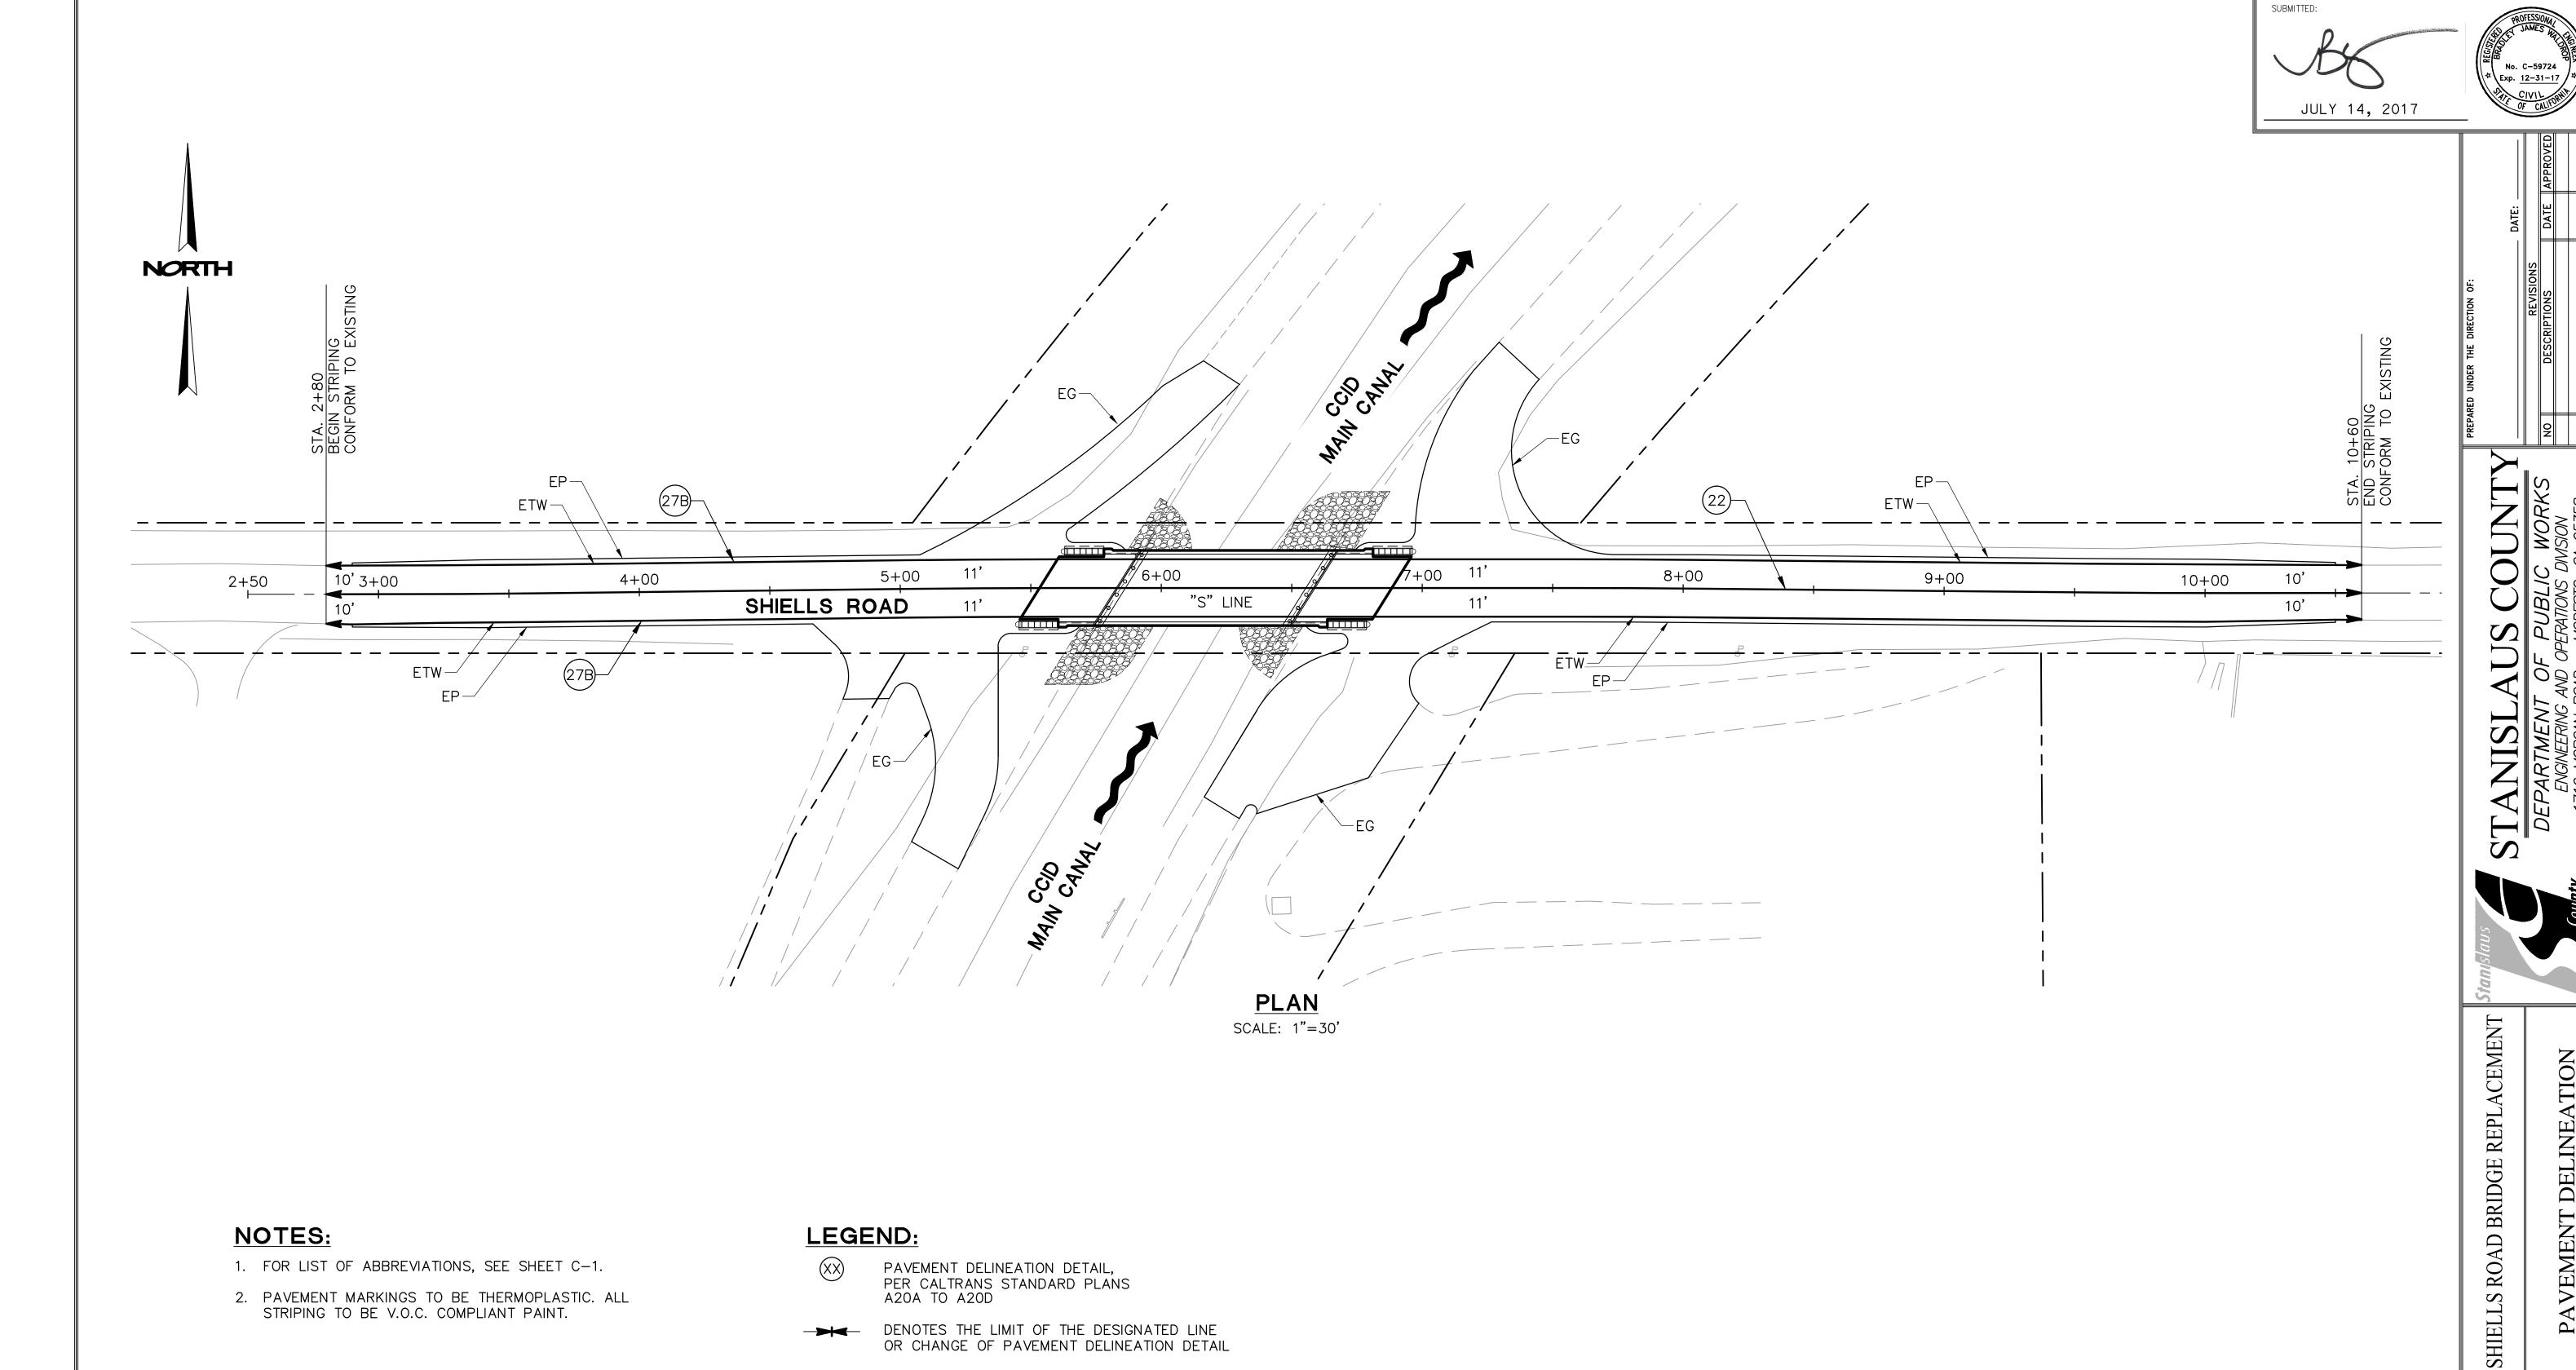


NOTES:

- 1. FOR LIST OF ABBREVIATIONS, SEE SHEET C-1.
- 2. PAVEMENT MARKINGS TO BE THERMOPLASTIC. ALL STRIPING TO BE V.O.C. COMPLIANT PAINT.

LEGEND:

- PAVEMENT DELINEATION DETAIL, PER CALTRANS STANDARD PLANS A20A TO A20D
- DENOTES THE LIMIT OF THE DESIGNATED LINE OR CHANGE OF PAVEMENT DELINEATION DETAIL

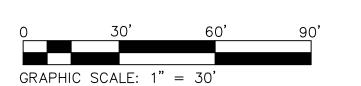





PAVEMENT

JOB NO SAB048800 DATE 3/10/16

SCALE AS SHOWN


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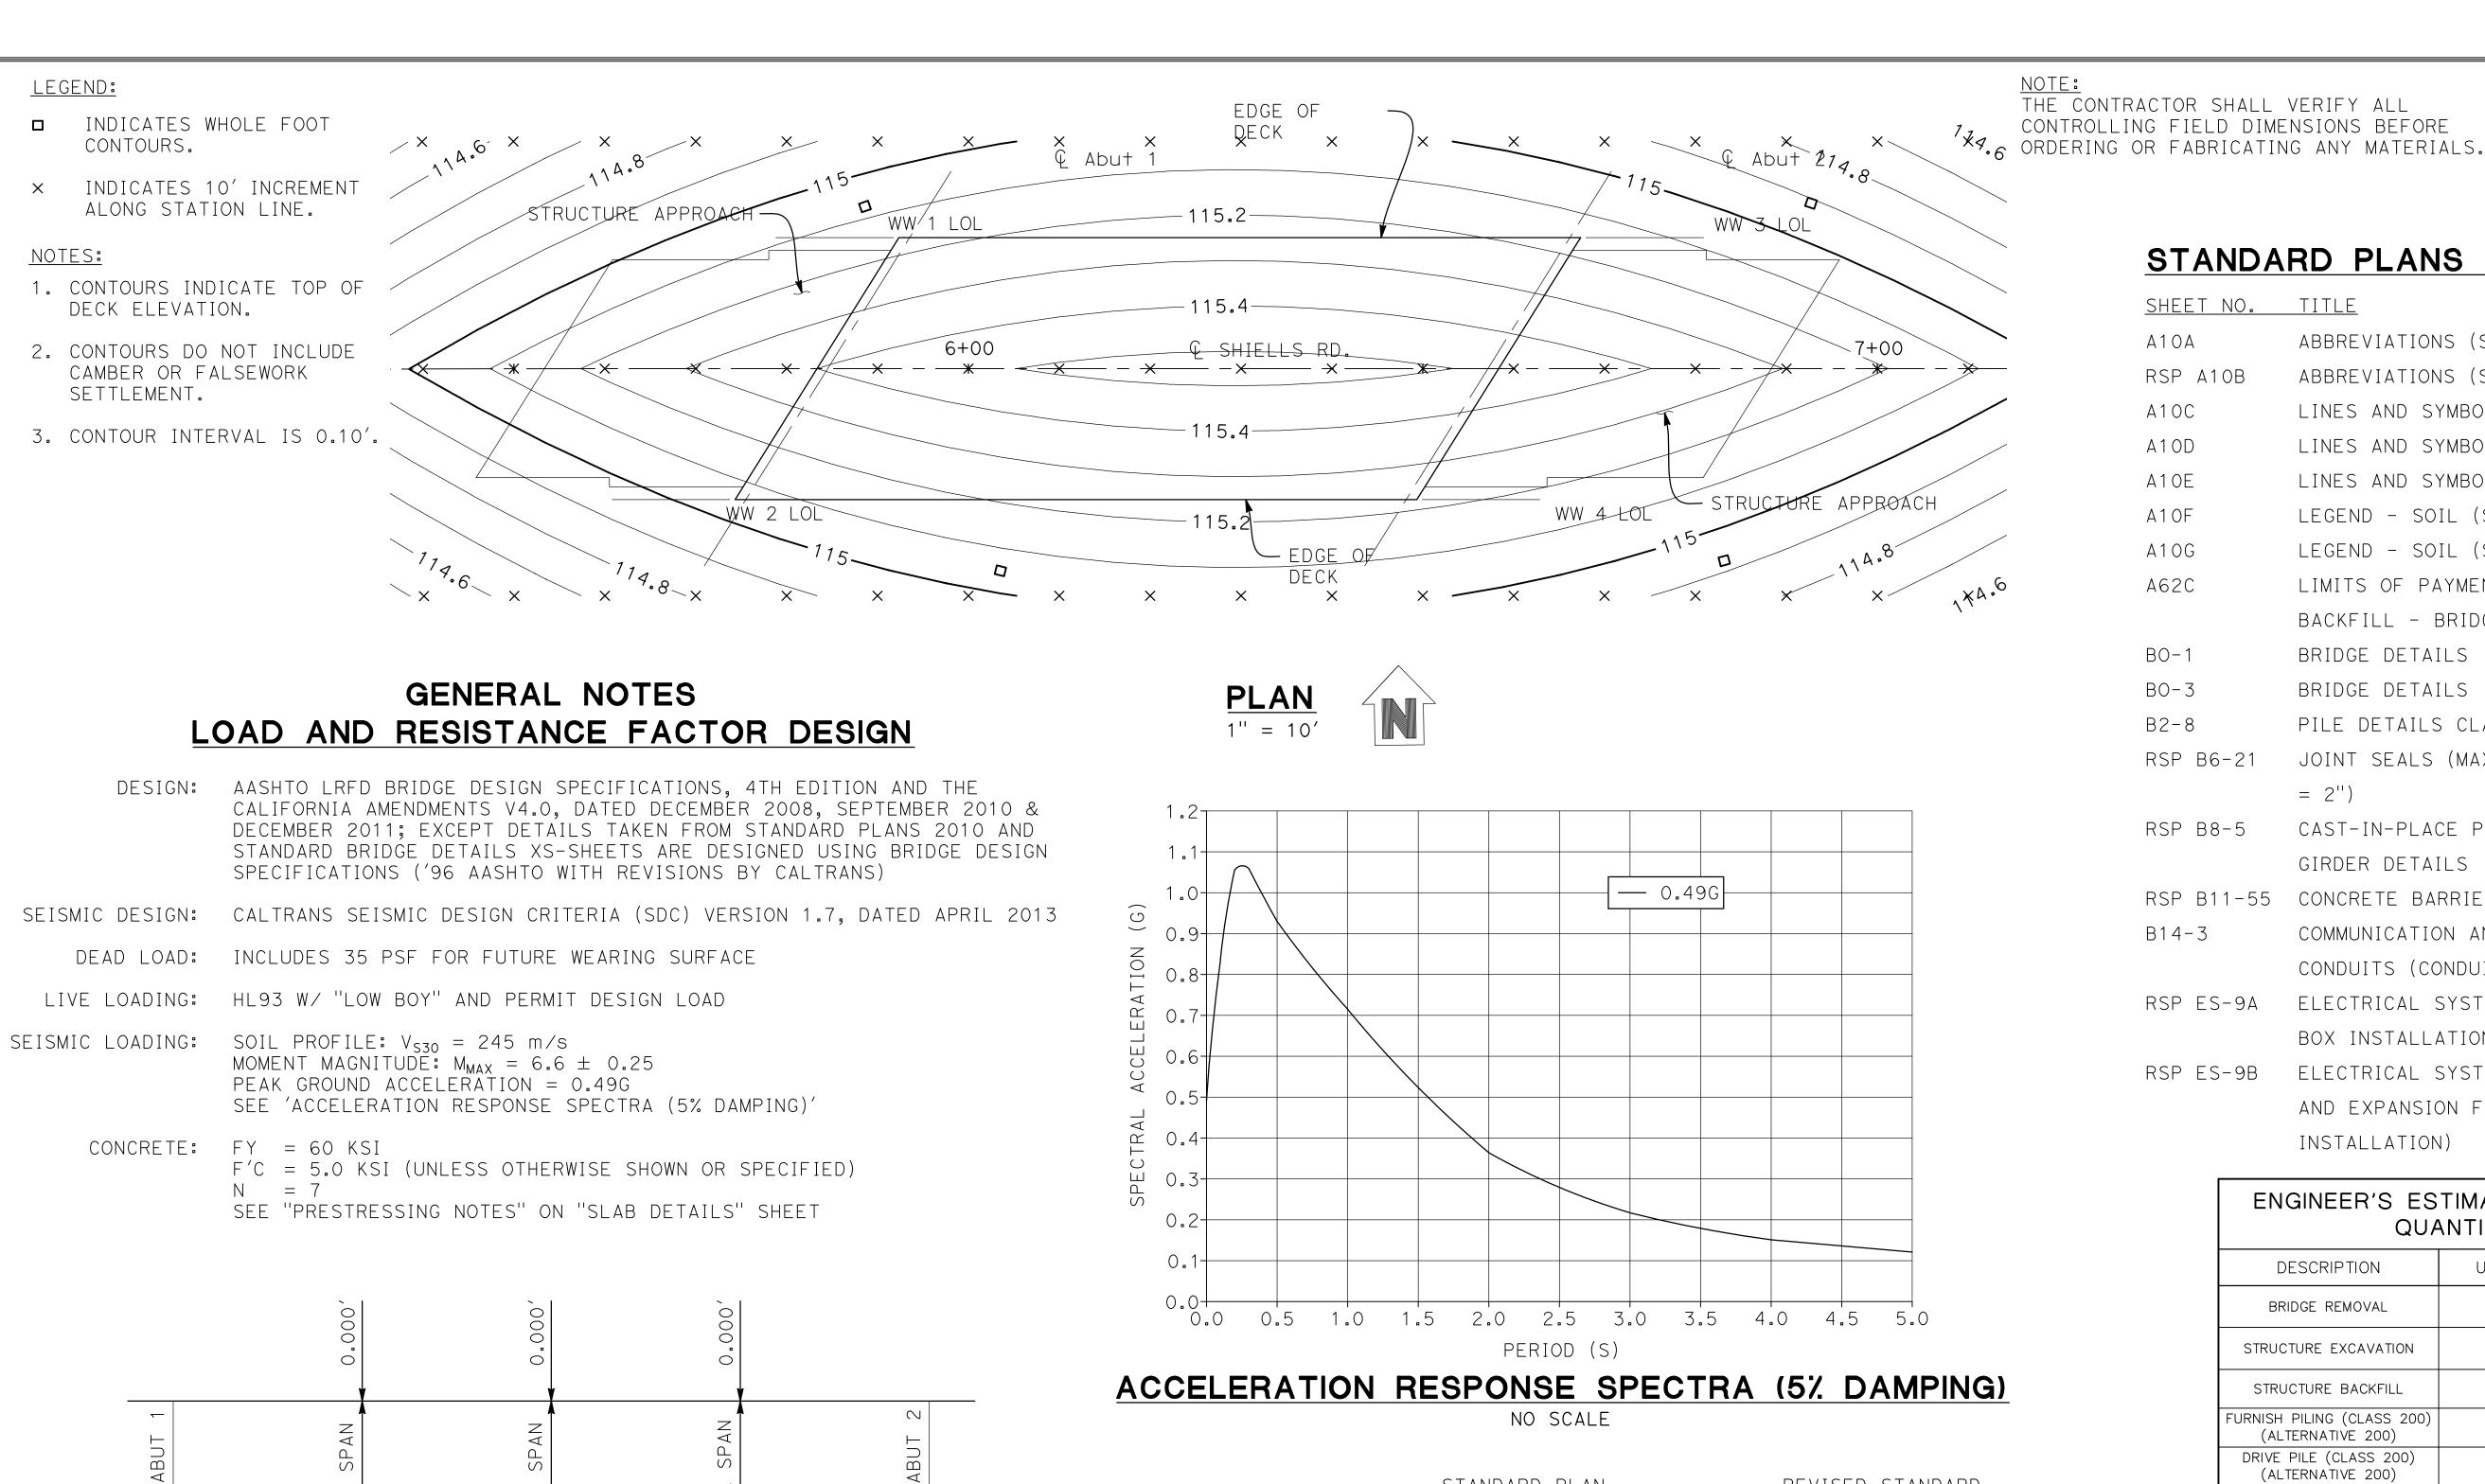
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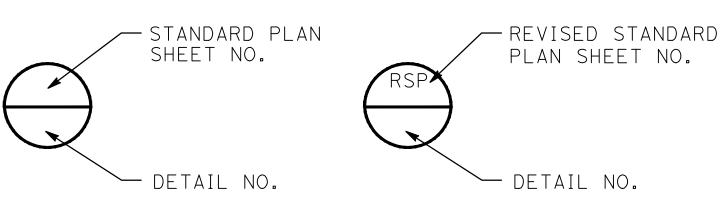


12 **OF** 23 **SHEETS**







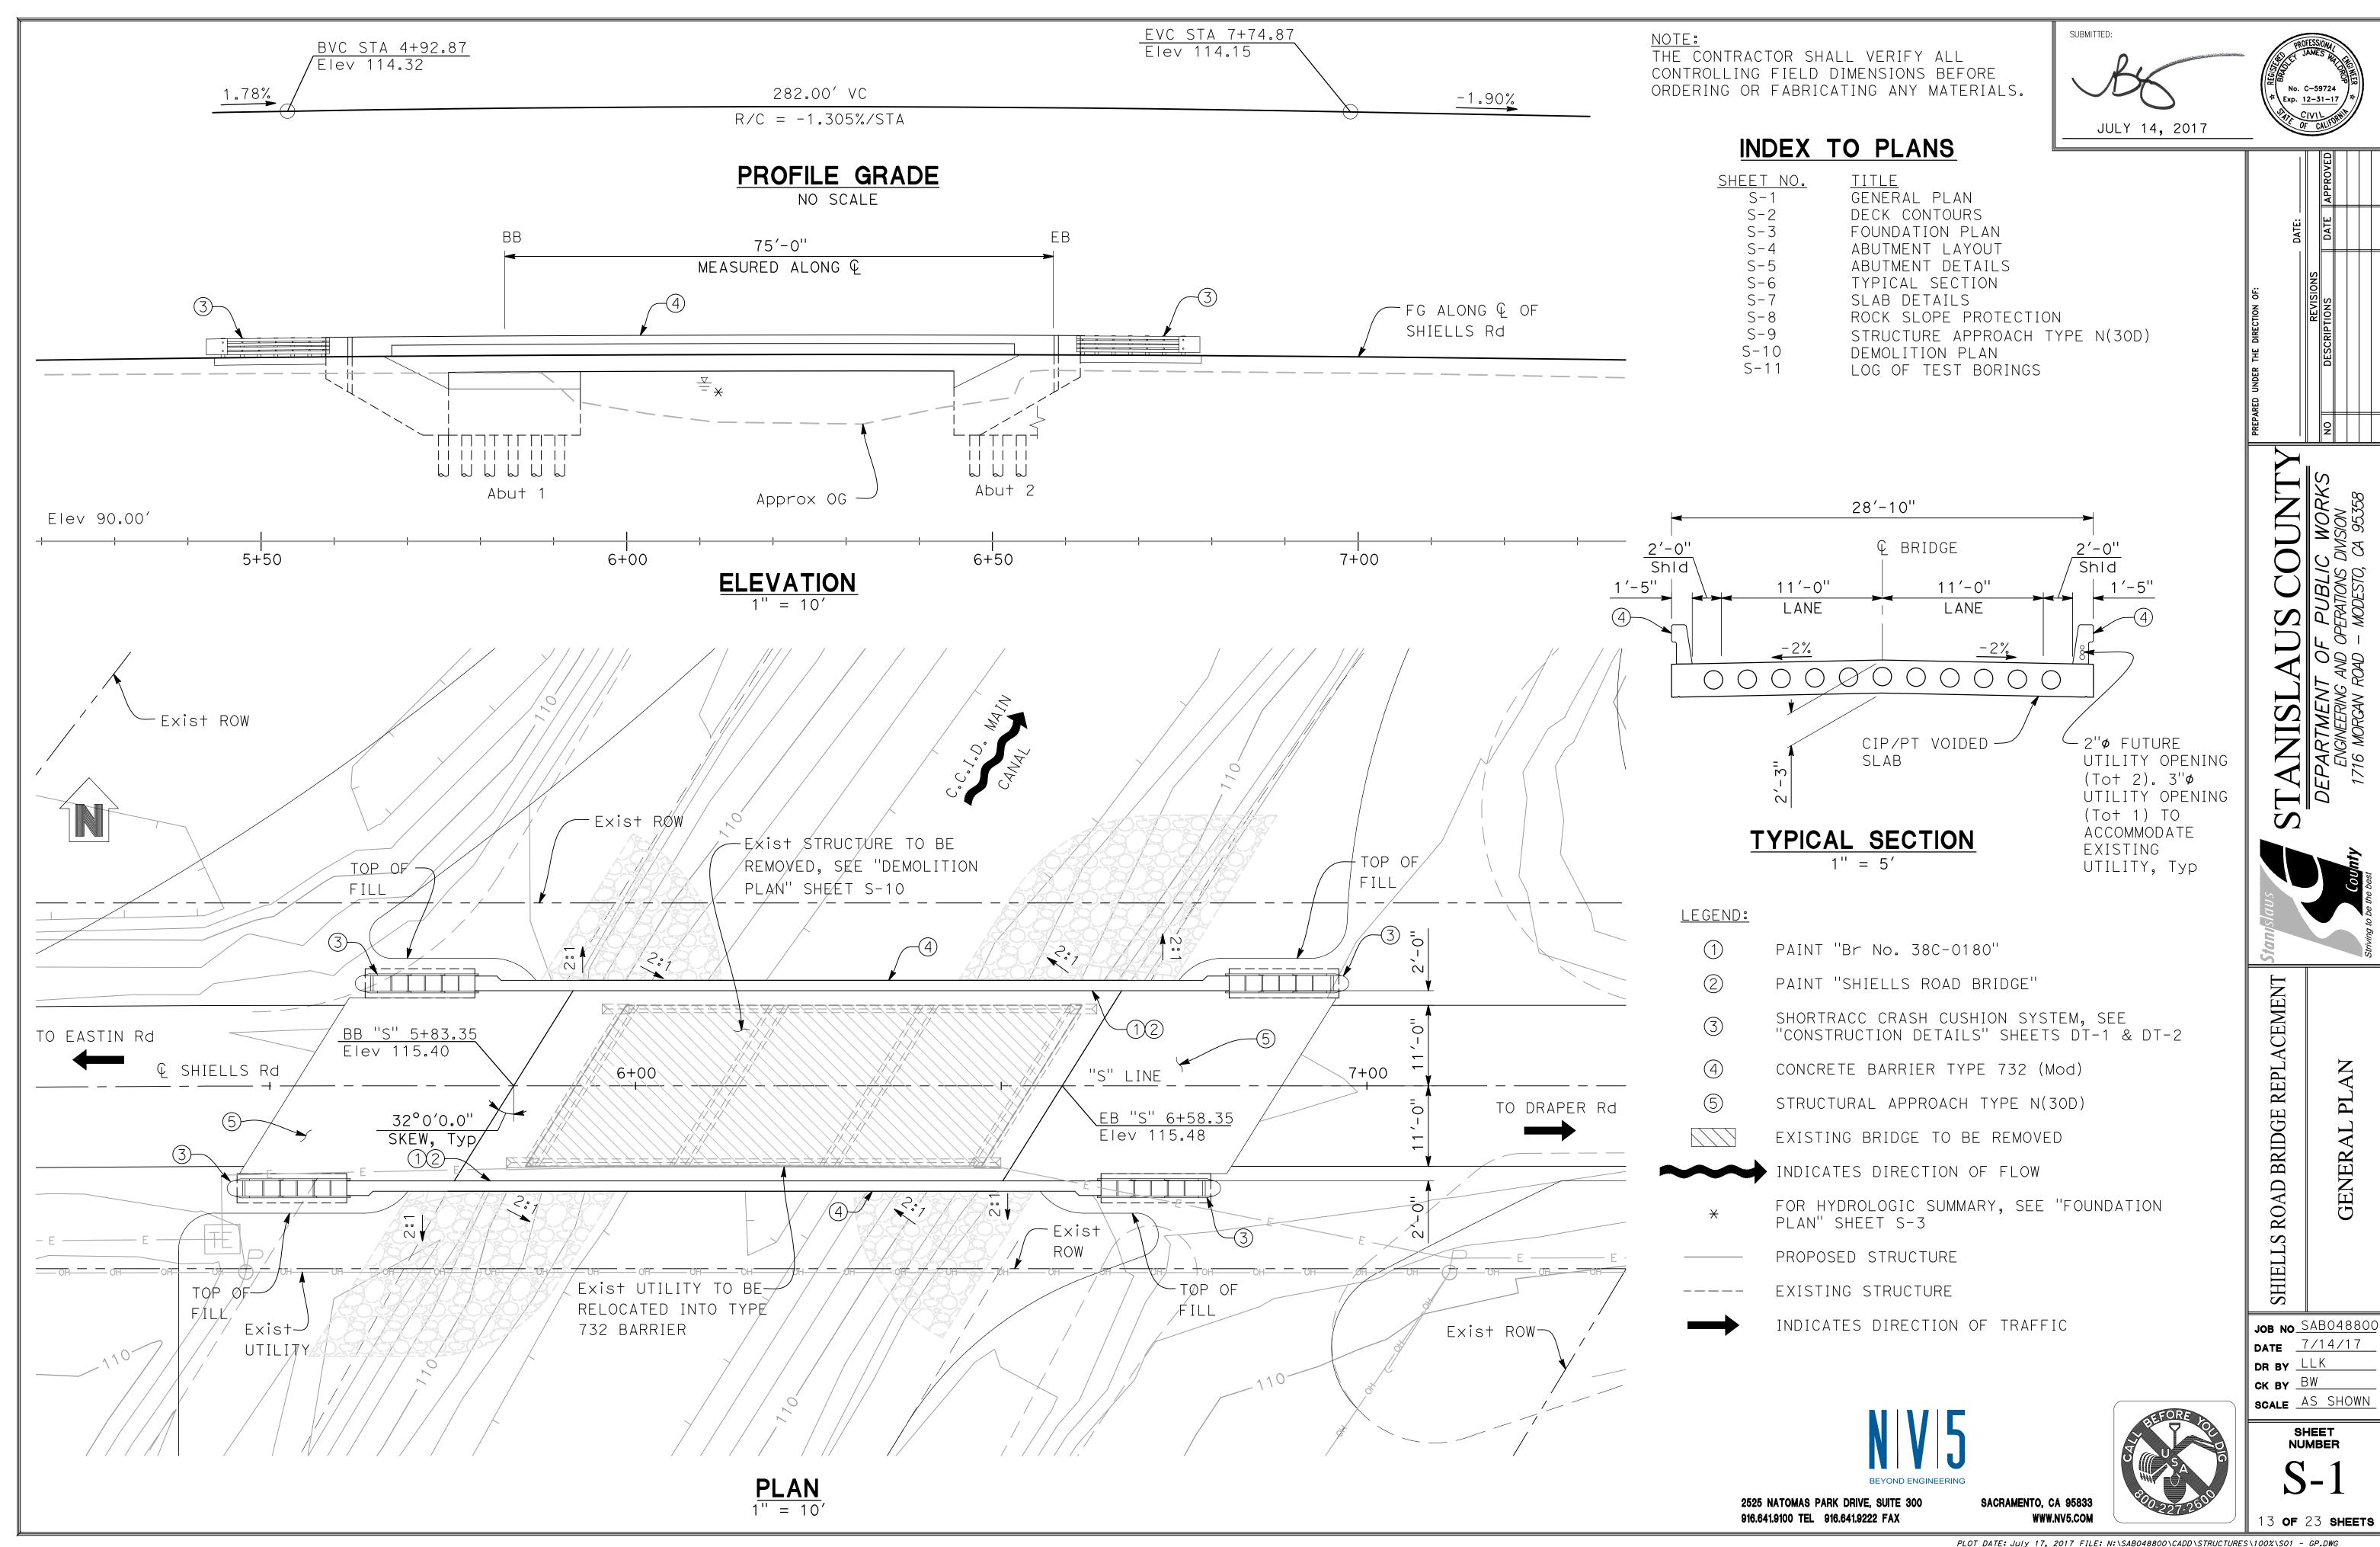

NOTE: DOES NOT INCLUDE ALLOWANCE FOR FALSEWORK SETTLEMENT **CAMBER DIAGRAM**

NO SCALE

STRUCTURAL CONCRETE, BRIDGE (F'C = 5.0 KSI @ 28 DAYS)

STRUCTURAL CONCRETE, APPROACH SLAB TYPE N(30D)

CONCRETE STRENGTH AND TYPE LIMITS

NO SCALE

2525 NATOMAS PARK DRIVE, SUITE 300 916.641.9100 TEL 916.641.9222 FAX

SACRAMENTO, CA 95833 WWW.NV5.COM





STANDARD PLANS 2010

SHEET NO.	TITLE_
A10A	ABBREVIATIONS (SHEET 1 OF 2)
RSP A10B	ABBREVIATIONS (SHEET 2 OF 2)
A1OC	LINES AND SYMBOLS (SHEET 1 OF 3)
A10D	LINES AND SYMBOLS (SHEET 2 OF 3)
A10E	LINES AND SYMBOLS (SHEET 3 OF 3)
A10F	LEGEND - SOIL (SHEET 1 OF 2)
A10G	LEGEND - SOIL (SHEET 2 OF 2)
A62C	LIMITS OF PAYMENT FOR EXCAVATION AND
	BACKFILL - BRIDGE
BO-1	BRIDGE DETAILS
BO-3	BRIDGE DETAILS
B2-8	PILE DETAILS CLASS 200
RSP B6-21	JOINT SEALS (MAXIMUM MOVEMENT RATING
	= 2")
RSP B8-5	CAST-IN-PLACE POST-TENSIONED
	GIRDER DETAILS
RSP B11-55	CONCRETE BARRIER TYPE 732
B14-3	COMMUNICATION AND SPRINKLER CONTROL
	CONDUITS (CONDUITS LESS THAN 4")
RSP ES-9A	ELECTRICAL SYSTEMS (STRUCTURE PULL
	BOX INSTALLATIONS)
RSP ES-9B	ELECTRICAL SYSTEMS (CONDUIT RISER
	AND EXPANSION FITTING, STRUCTURE

ENGINEER'S ES QU <i>A</i>	TIMATE (OF BRIDGE
DESCRIPTION	UNIT	TOTAL QUANTITY
BRIDGE REMOVAL	LS	1
STRUCTURE EXCAVATION	CY	101
STRUCTURE BACKFILL	CY	42
FURNISH PILING (CLASS 200) (ALTERNATIVE 200)	LF	764
DRIVE PILE (CLASS 200) (ALTERNATIVE 200)	EA	12
PRESTRESSING CAST-IN-PLACE CONCRETE	LS	1
STRUCTURAL CONCRETE (BRIDGE)	CY	248
STRUCTURAL CONCRETE (APPROACH SLAB)	CY	58
JOINT SEAL (MR 1/2")	LF	68
BAR REINFORCING STEEL	LB	50,772
ROCK SLOPE PROTECTION (NO. 3, METHOD B)	CY	189
CONCRETE BARRIER (TYPE 732 MODIFIED)	LF	207

INSTALLATION)






14 **OF** 23 **SHEETS**

JOB NO SAB048800 DATE <u>7/14/17</u>

DR BY LLK CK BY BW SCALE AS SHOWN

NUMBER

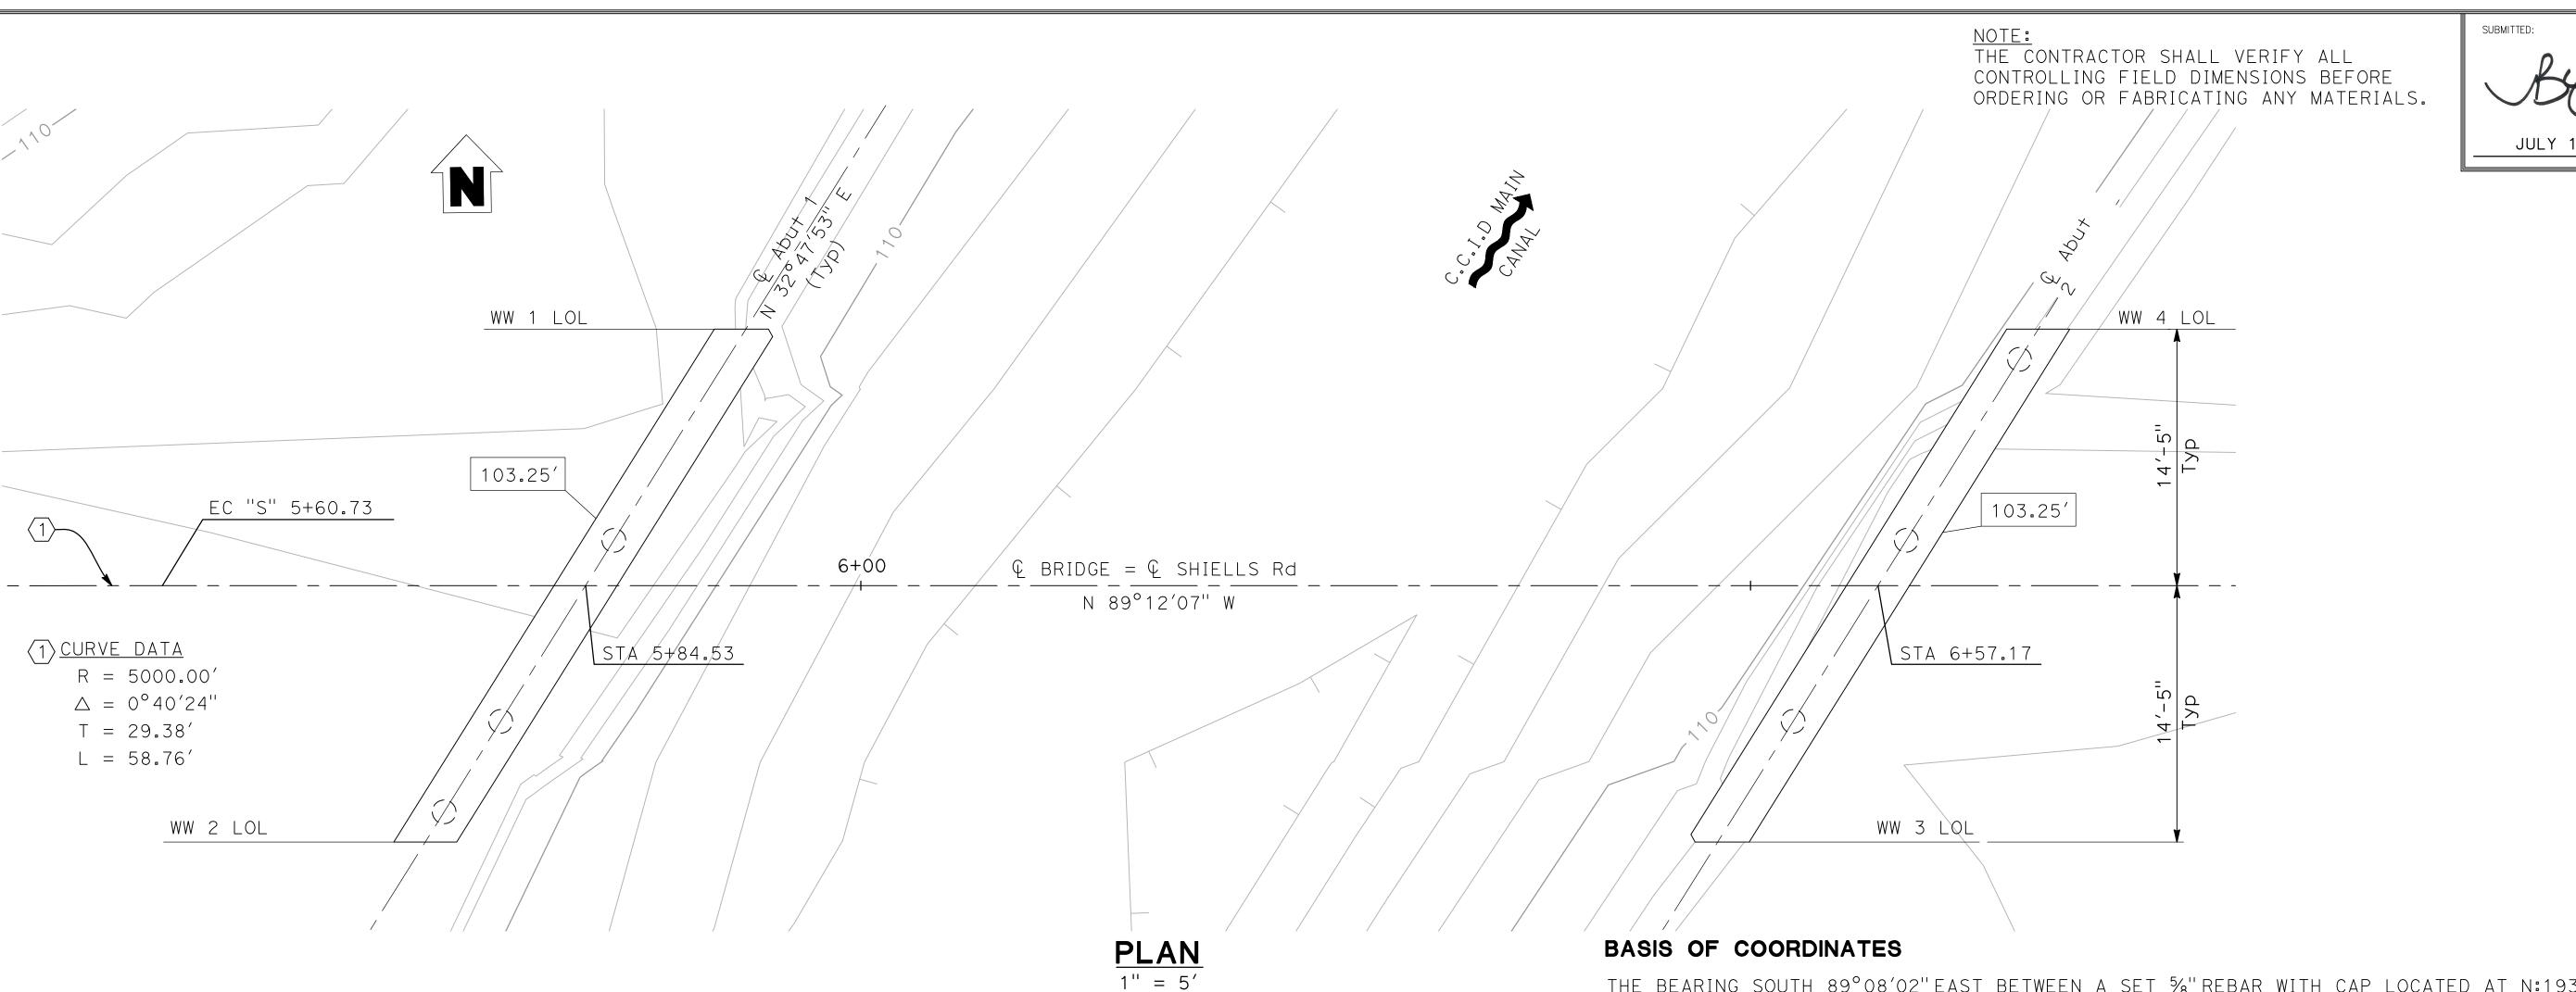

HYDROLOGIC SUMMARY

DRAINAGE AREA: NA						
	DESIGN	BASE	IRRIGATION			
	FLOOD	FLOOD	OPERATION			
FREQUENCY (YEARS)	50	100				
DISCHARGE (CUBIC FEET PER SECOND)	NA	300	300			
WATER SURFACE (ELEVATION AT BRIDGE)	NA	111.00 FT	111.82 FT			

FLOOD PLAIN DATA IS BASED UPON INFORMATION AVAILABLE WHEN THE PLANS WERE PREPARED AND ARE SHOWN TO MEET FEDERAL REQUIREMENTS. THE ACCURACY OF SAID INFORMATION IS NOT WARRANTED BY THE COUNTY OF STANISLAUS OR NV5 AND INTERESTED OR AFFECTED PARTIES SHOULD MAKE THEIR OWN INVESTIGATION.

- NOTES: 1. CONTOUR GRADING SHALL BE PERFORMED AFTER BRIDGE REMOVAL.
- 2. GROUND WATER ANTICIPATED BELOW Elev 97.

<u>LEGEND</u>:

DENOTES BOTTOM OF FOOTING ELEVATION

DENOTES CLASS 200 ALT "W" PILES (NOT ALL PILES SHOWN)



DENOTES DIRECTION OF FLOW

THE BEARING SOUTH 89°08'02" EAST BETWEEN A SET 5%" REBAR WITH CAP LOCATED AT N:1933672.37 (POSITIONS BASED ON THE OPUS SOLUTION USING CORS STATIONS; HS4826, DE6246, DN7571 AND DN7566) CALIFORNIA COORDINATE SYSTEM 1983 (CCS83) ZONE I (EPOCH 2002.0000) WAS TAKEN AS THE BASIS OF BEARINGS FOR THIS SURVEY.

THE HORIZONTAL DATUM IS BASED ON THE CALIFORNIA COORDINATE SYSTEM OF 1983 (NAD 83, ZONE 3, EPOCH 2010.00. IT IS BASED ON GLOBAL POSITIONING SYSTEM (GPS) TECHNIQUES AND DERIVED FROM THE FOLLOWING NGS CONTROL STATIONS:

<u>PID</u>	<u>DESIGNATION</u>	<u>latitude</u>	<u>LONGITUDE</u>	<u>DISTANCE(m)</u>
HS4826	newman municipal tank	N371851.259	W1210129.506	3552.0
DE6246	CMOD MODESTO COOP CORS ARP	N373828.800	W1205959.864	37845.2
DN7571	P259 PATTERSON_CN2005 CORS ARP	N372558.858	W1210602.035	14697.1
DN7566	P254 MTBOARDMANCN2007 CORS ARP	N372922.663	W1212809.051	41472.4

VERTICAL DATUM

THE VERTICAL DATUM IS BASED ON THE NORTH AMERICAN VERTICAL DATUM 88 (NAVD 88, GEOID12A). IT IS BASED ON GLOBAL POSITIONING SYSTEM (GPS) TECHNIQUES AND DERIVED FROM THE FOLLOWING NGS CONTROL STATIONS:

<u>PID</u>	<u>DESIGNATION</u>	<u>LATITUDE</u>	LONGITUDE	DISTANCE(m
HS4826	NEWMAN MUNICIPAL TANK	N371851.259	W1210129.506	3552.0
DE6246	CMOD MODESTO COOP CORS ARP	N373828.800	W1205959.864	37845.2
DN7571	P259 PATTERSON_CN2005 CORS ARP	N372558.858	W1210602.035	14697.1
DN7566	P254 MTBOARDMANCN2007 CORS ARP	N372922.663	W1212809.051	41472.4

SCOUR DATA TABLE

	33331 27117 171212	
	Long term (Degradation and	Short Term (Local)
Support No.	Contraction) Scour Elevation (ft)	Scour Depth (ft)
Abut 1	0.00	0.00
Abut 2	0.00	5.90

<u>NOTE</u>:

THE ABOVE SCOUR INFORMATION NEGLECTS ROCK SLOPE PROTECTION. THE CALCULATED SCOUR WITH THE ROCK SLOPE PROTECTION AS SHOWN IN THE PLANS IS 0.00 FEET.



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PLOT DATE: July 17, 2017 FILE: N:\SAB048800\CADD\STRUCTURES\100%\S03 - FP.DWG

PILE DATA TABLE								
PILE	LE PILE TYPE NOMINAL RESISTANCE DESIGN PIL				SPECIFIED PILE TIP ELEVATION	NOMINAL DRIVING RESISTANCE		
LOCATION	PILE TIPE	COMPRESSION	TENSION		(FT)	REQUIRED (KIPS)		
ABUT 1	CLASS 200 ALT "W"	230 KIPS	O KIPS	43.0' (A) 73.0' (B) 40.0' (C)	40.0′	350		
ABUT 2	CLASS 200 ALT "W"	230 KIPS	O KIPS	46.0' (A) 73.0' (B) 40.0' (C)	40.0′	350		

<u>NOTE</u>:

1. DESIGN TIP ELEVATION IS CONTROLLED BY THE FOLLOWING DEMANDS: (A) COMPRESSION, (B) LATERAL, AND (C) DOWNDRAG.

JULY 14, 2017

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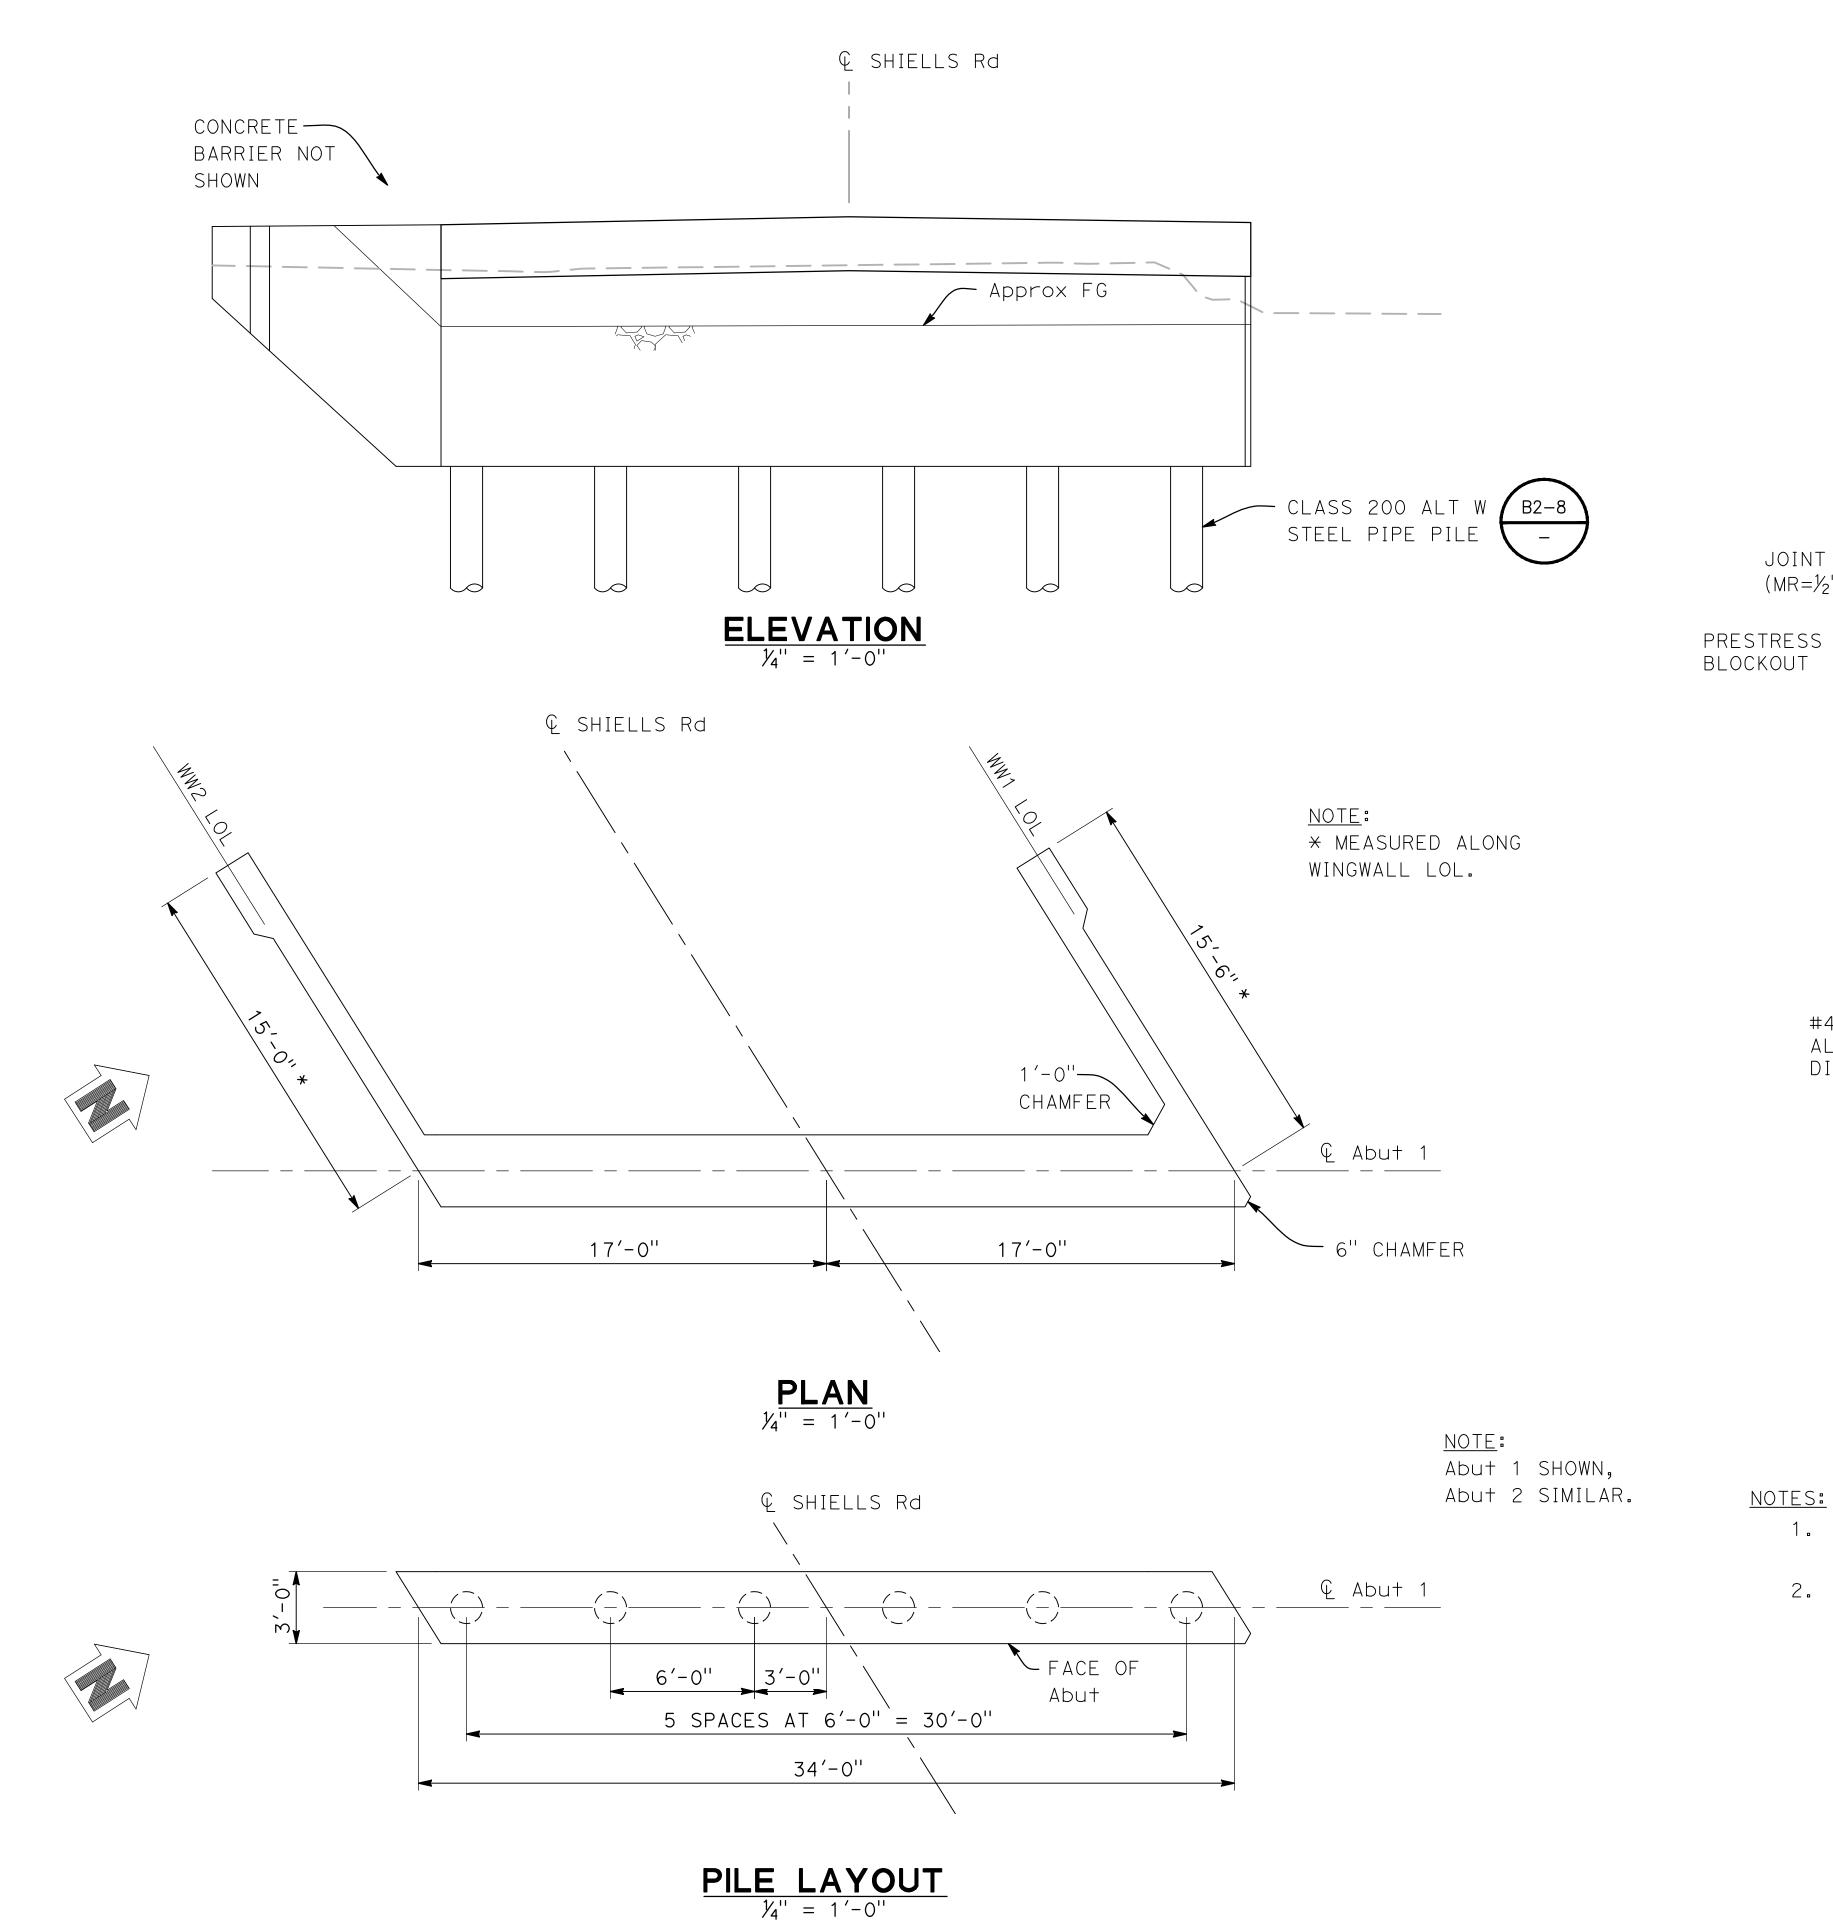


ск ву <u>В</u> SCALE AS SHOWN NUMBER

JOB NO SAB048800


DATE <u>7/14/17</u>

DR BY LLK



NOTE: The contractor shall verify all CONTROLLING FIELD DIMENSIONS BEFORE ORDERING OR FABRICATING ANY MATERIALS.



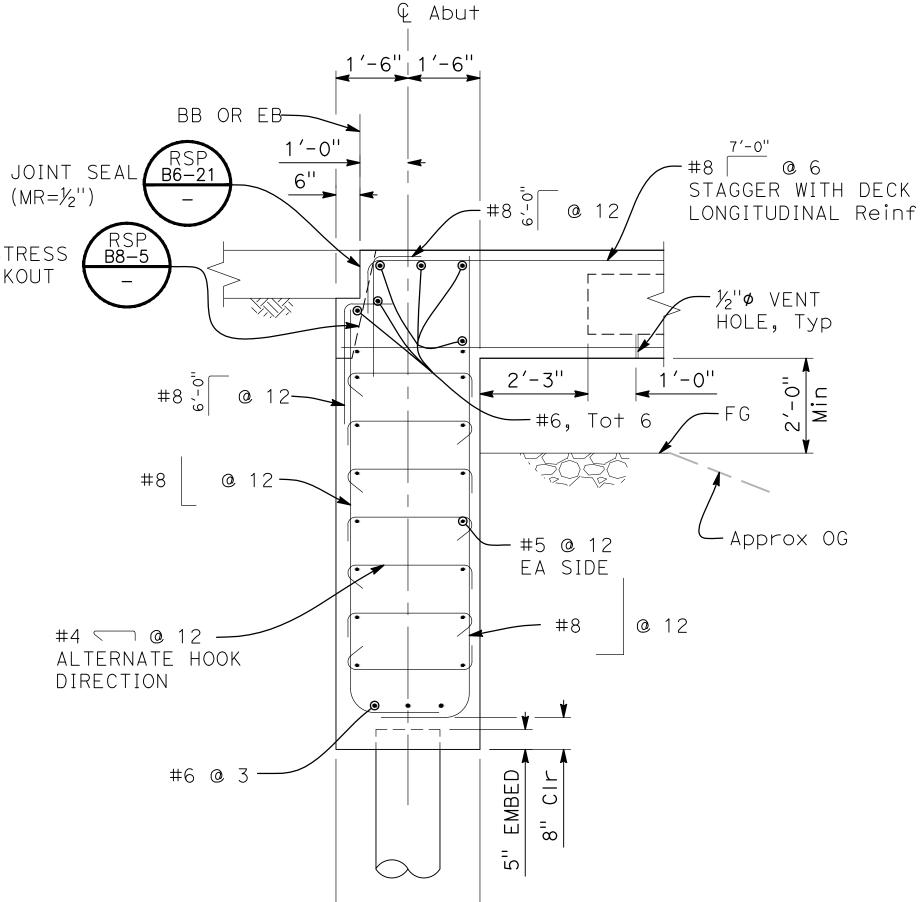

3'-0"

 $\frac{\text{TYPICAL SECTION}}{\frac{1}{2}} = \frac{1}{-0}$

- 1. FOR TYPICAL DECK REINFORCEMENT, SEE "DECK SLAB" SHEET S-7.
- 2. FOR WINGWALL DETAILS, SEE "ABUTMENT DETAILS" SHEET S-5.



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SCALE AS SHOWN

SHIELLS ROAD BRIDGE REPLACEMENT

JOB NO SAB048800


DATE 7/14/17

SHEET NUMBER


DR BY LLK

CK BY BW

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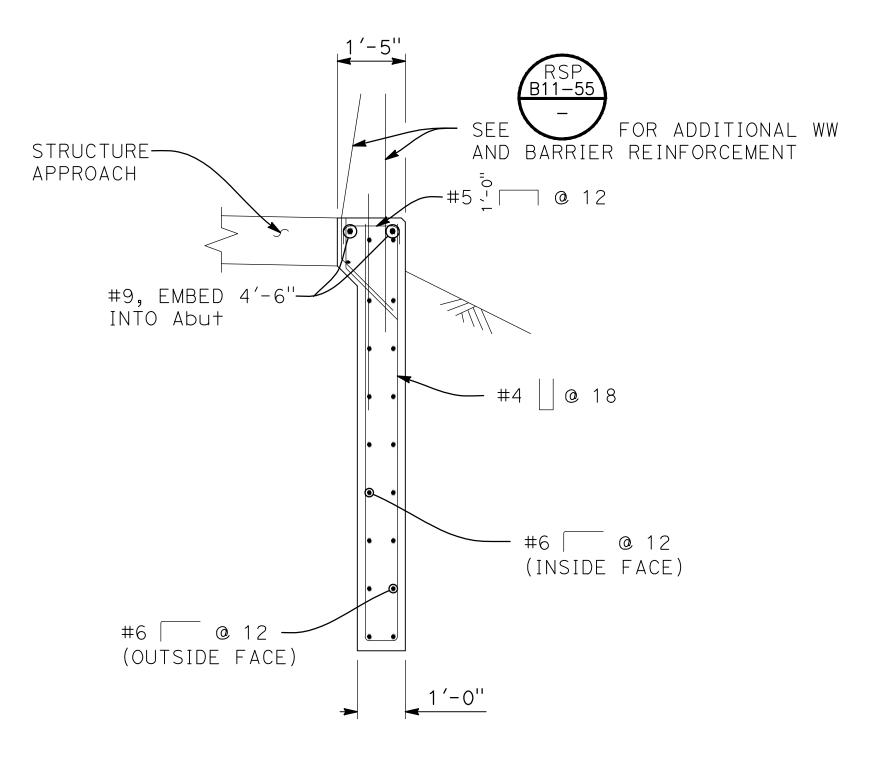
WINGWALL TYPICAL SECTION ½"=1'-0"

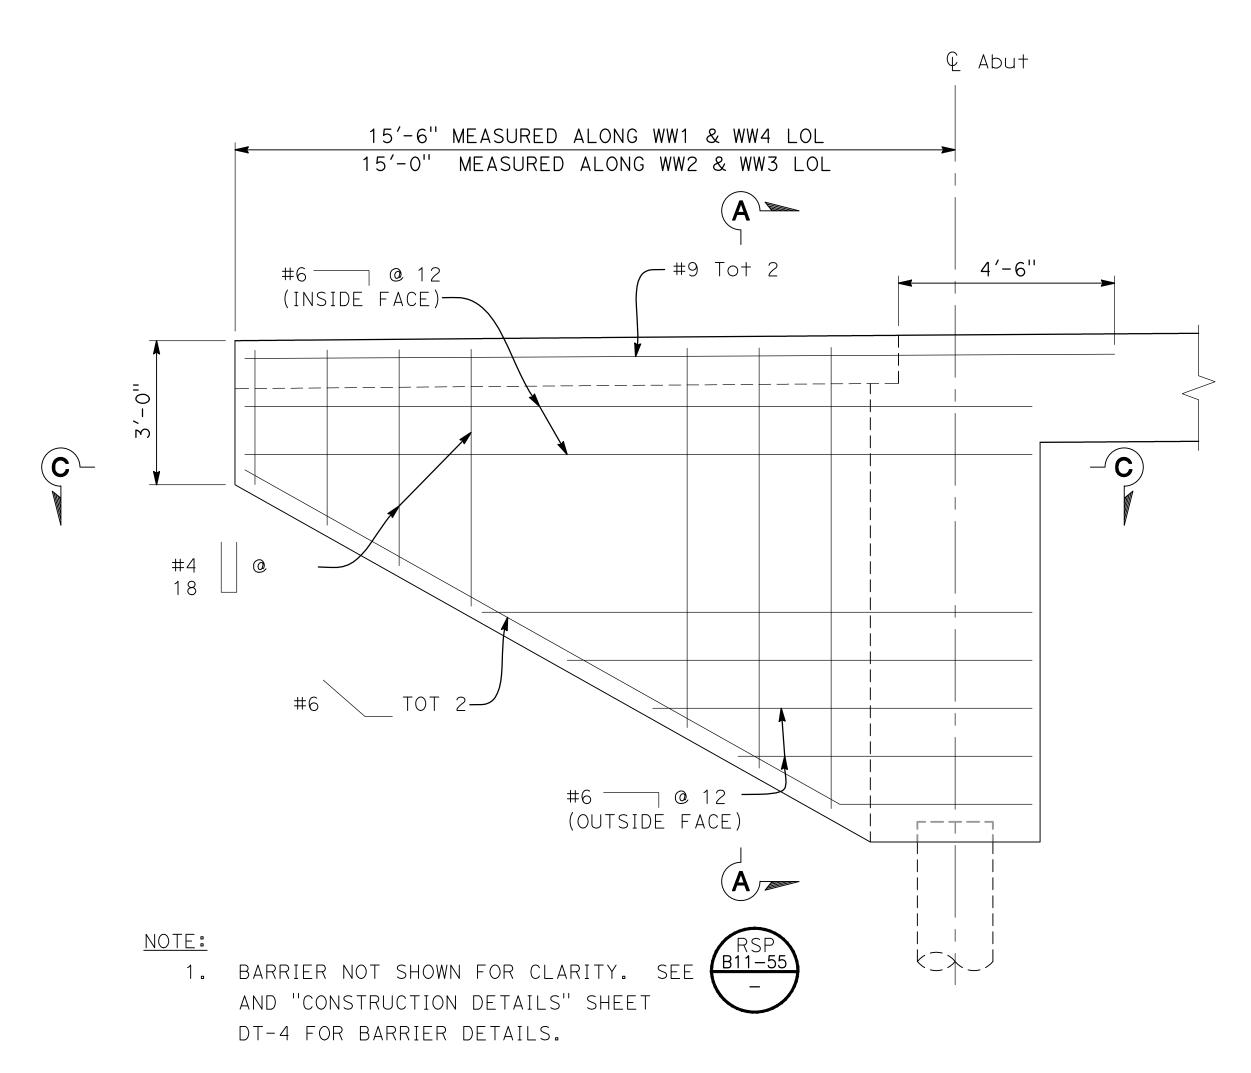

SECTION C-C1/2"=1'-0"

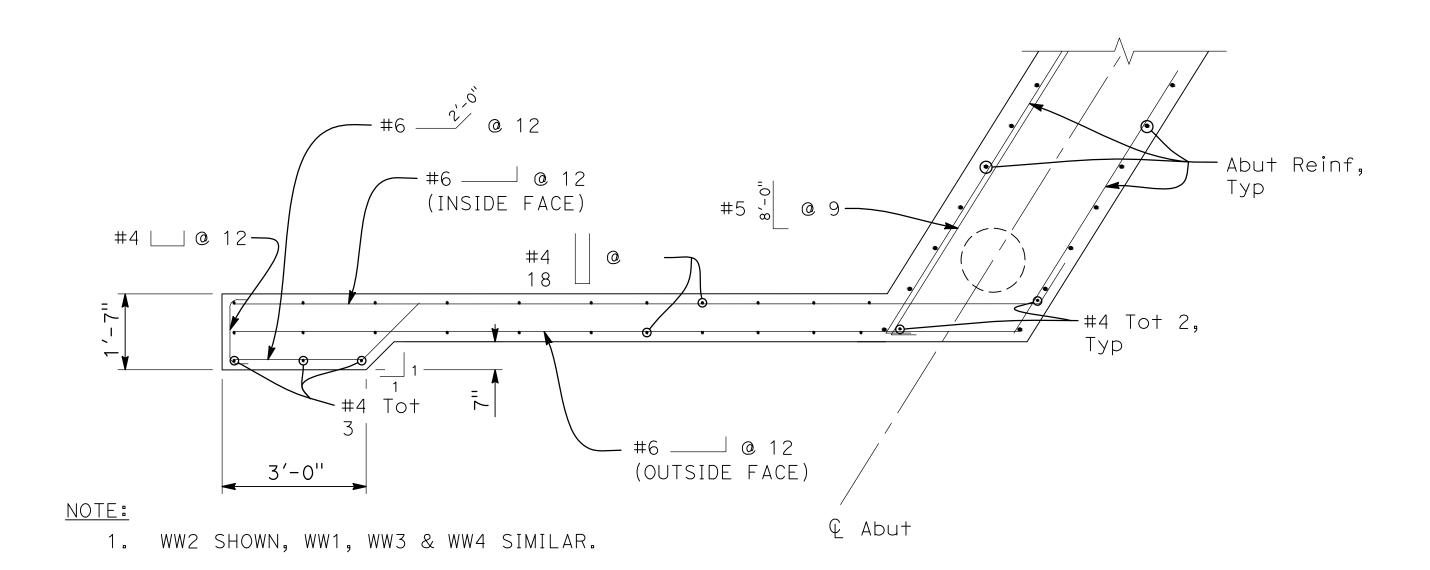NOTE: The contractor shall verify all CONTROLLING FIELD DIMENSIONS BEFORE ORDERING OR FABRICATING ANY MATERIALS.





SECTION A-A

SHIELLS ROAD BRIDGE REPLACEMENT

JOB NO SAB048800 DATE 7/17/17 DR BY LLK
CK BY BW

SCALE AS SHOWN

SHEET NUMBER


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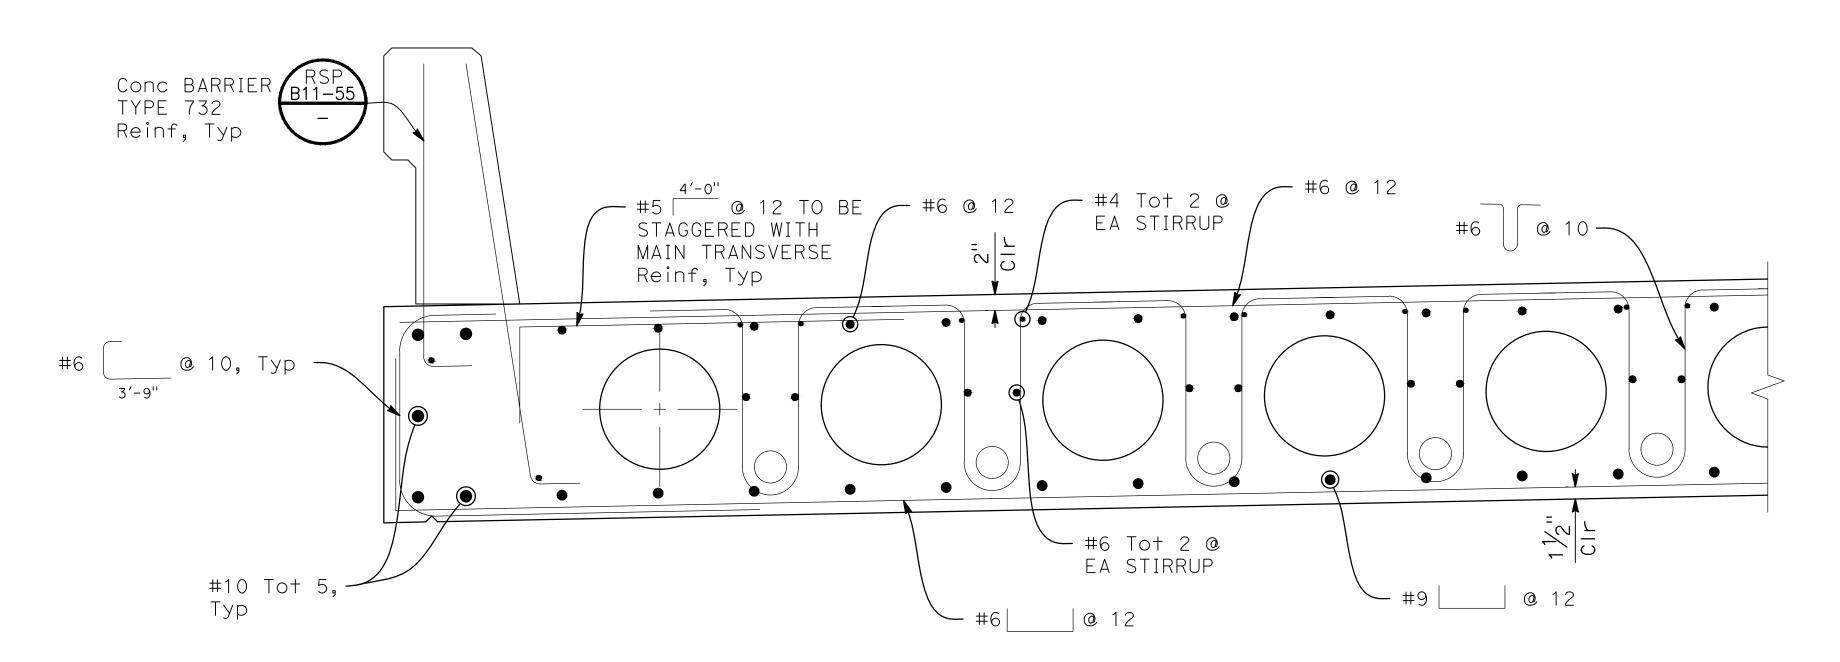




TYPICAL SECTION $\frac{1}{2}$ " = 1'-0"

1. FOR HYDROLOGIC SUMMARY, SEE "FOUNDATION PLAN" SHEET S-3.

2. FOR ADDITIONAL TYPE 732 BARRIER DETAILS, SEE "CONSTRUCTION DETAILS-4" SHEET DT-4.

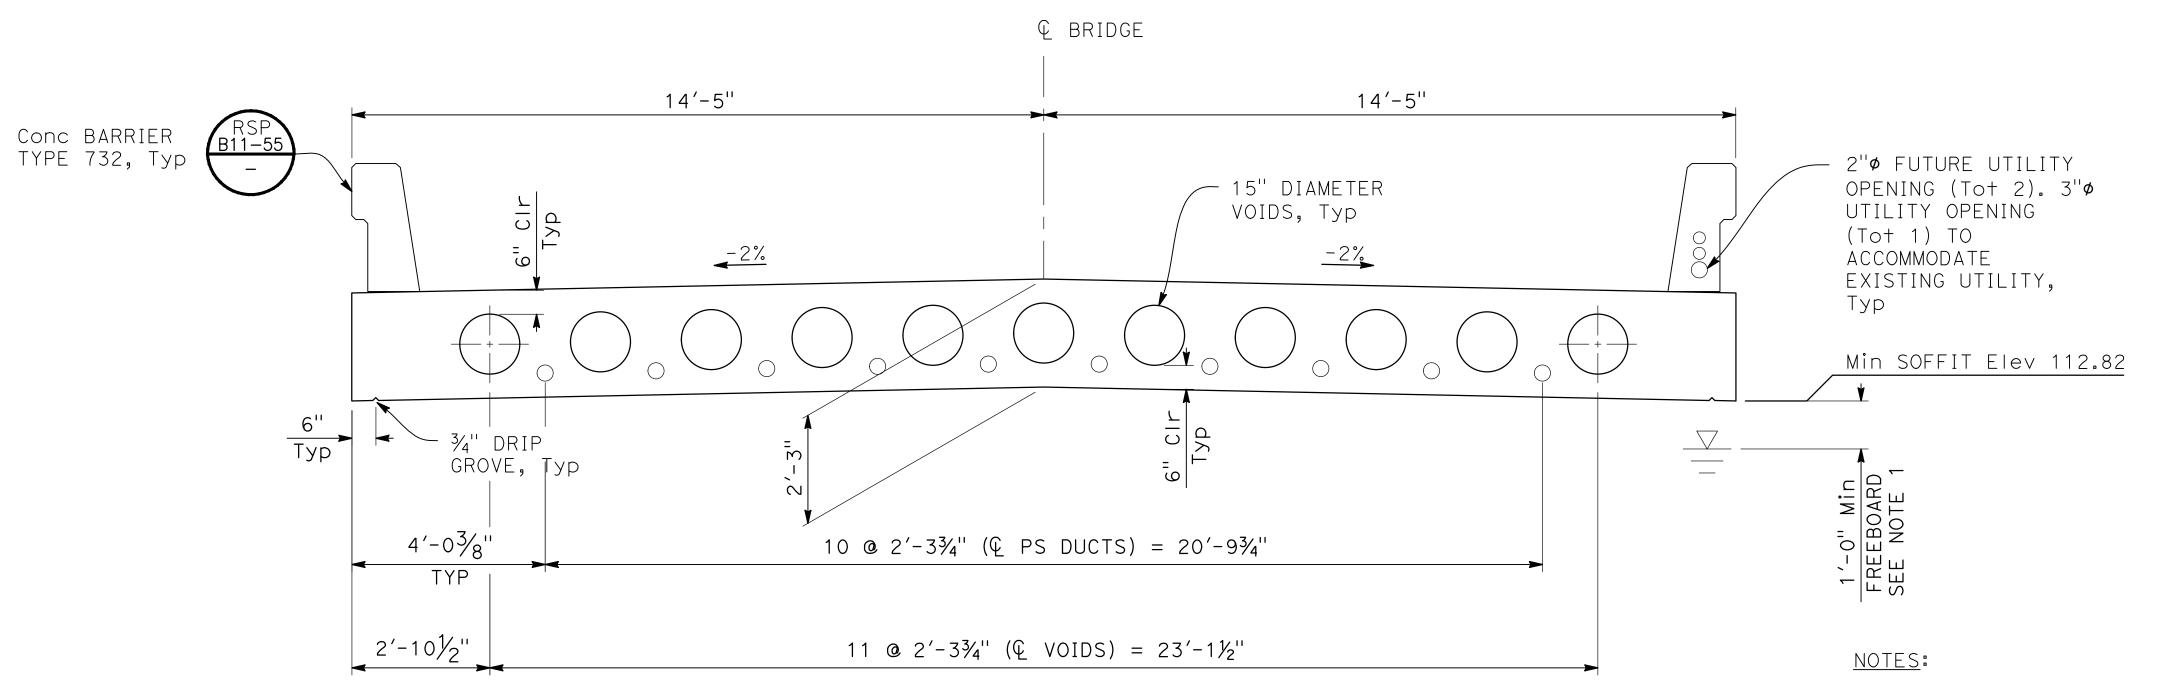

PARTIAL TYPICAL SECTION



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JOB NO SAB048800

DATE 7/14/17


SCALE AS SHOWN


SHEET NUMBER

DR BY LLK
CK BY BW

SHIELLS ROAD BRIDGE REPLACEMENT

LYPICAL SECTION

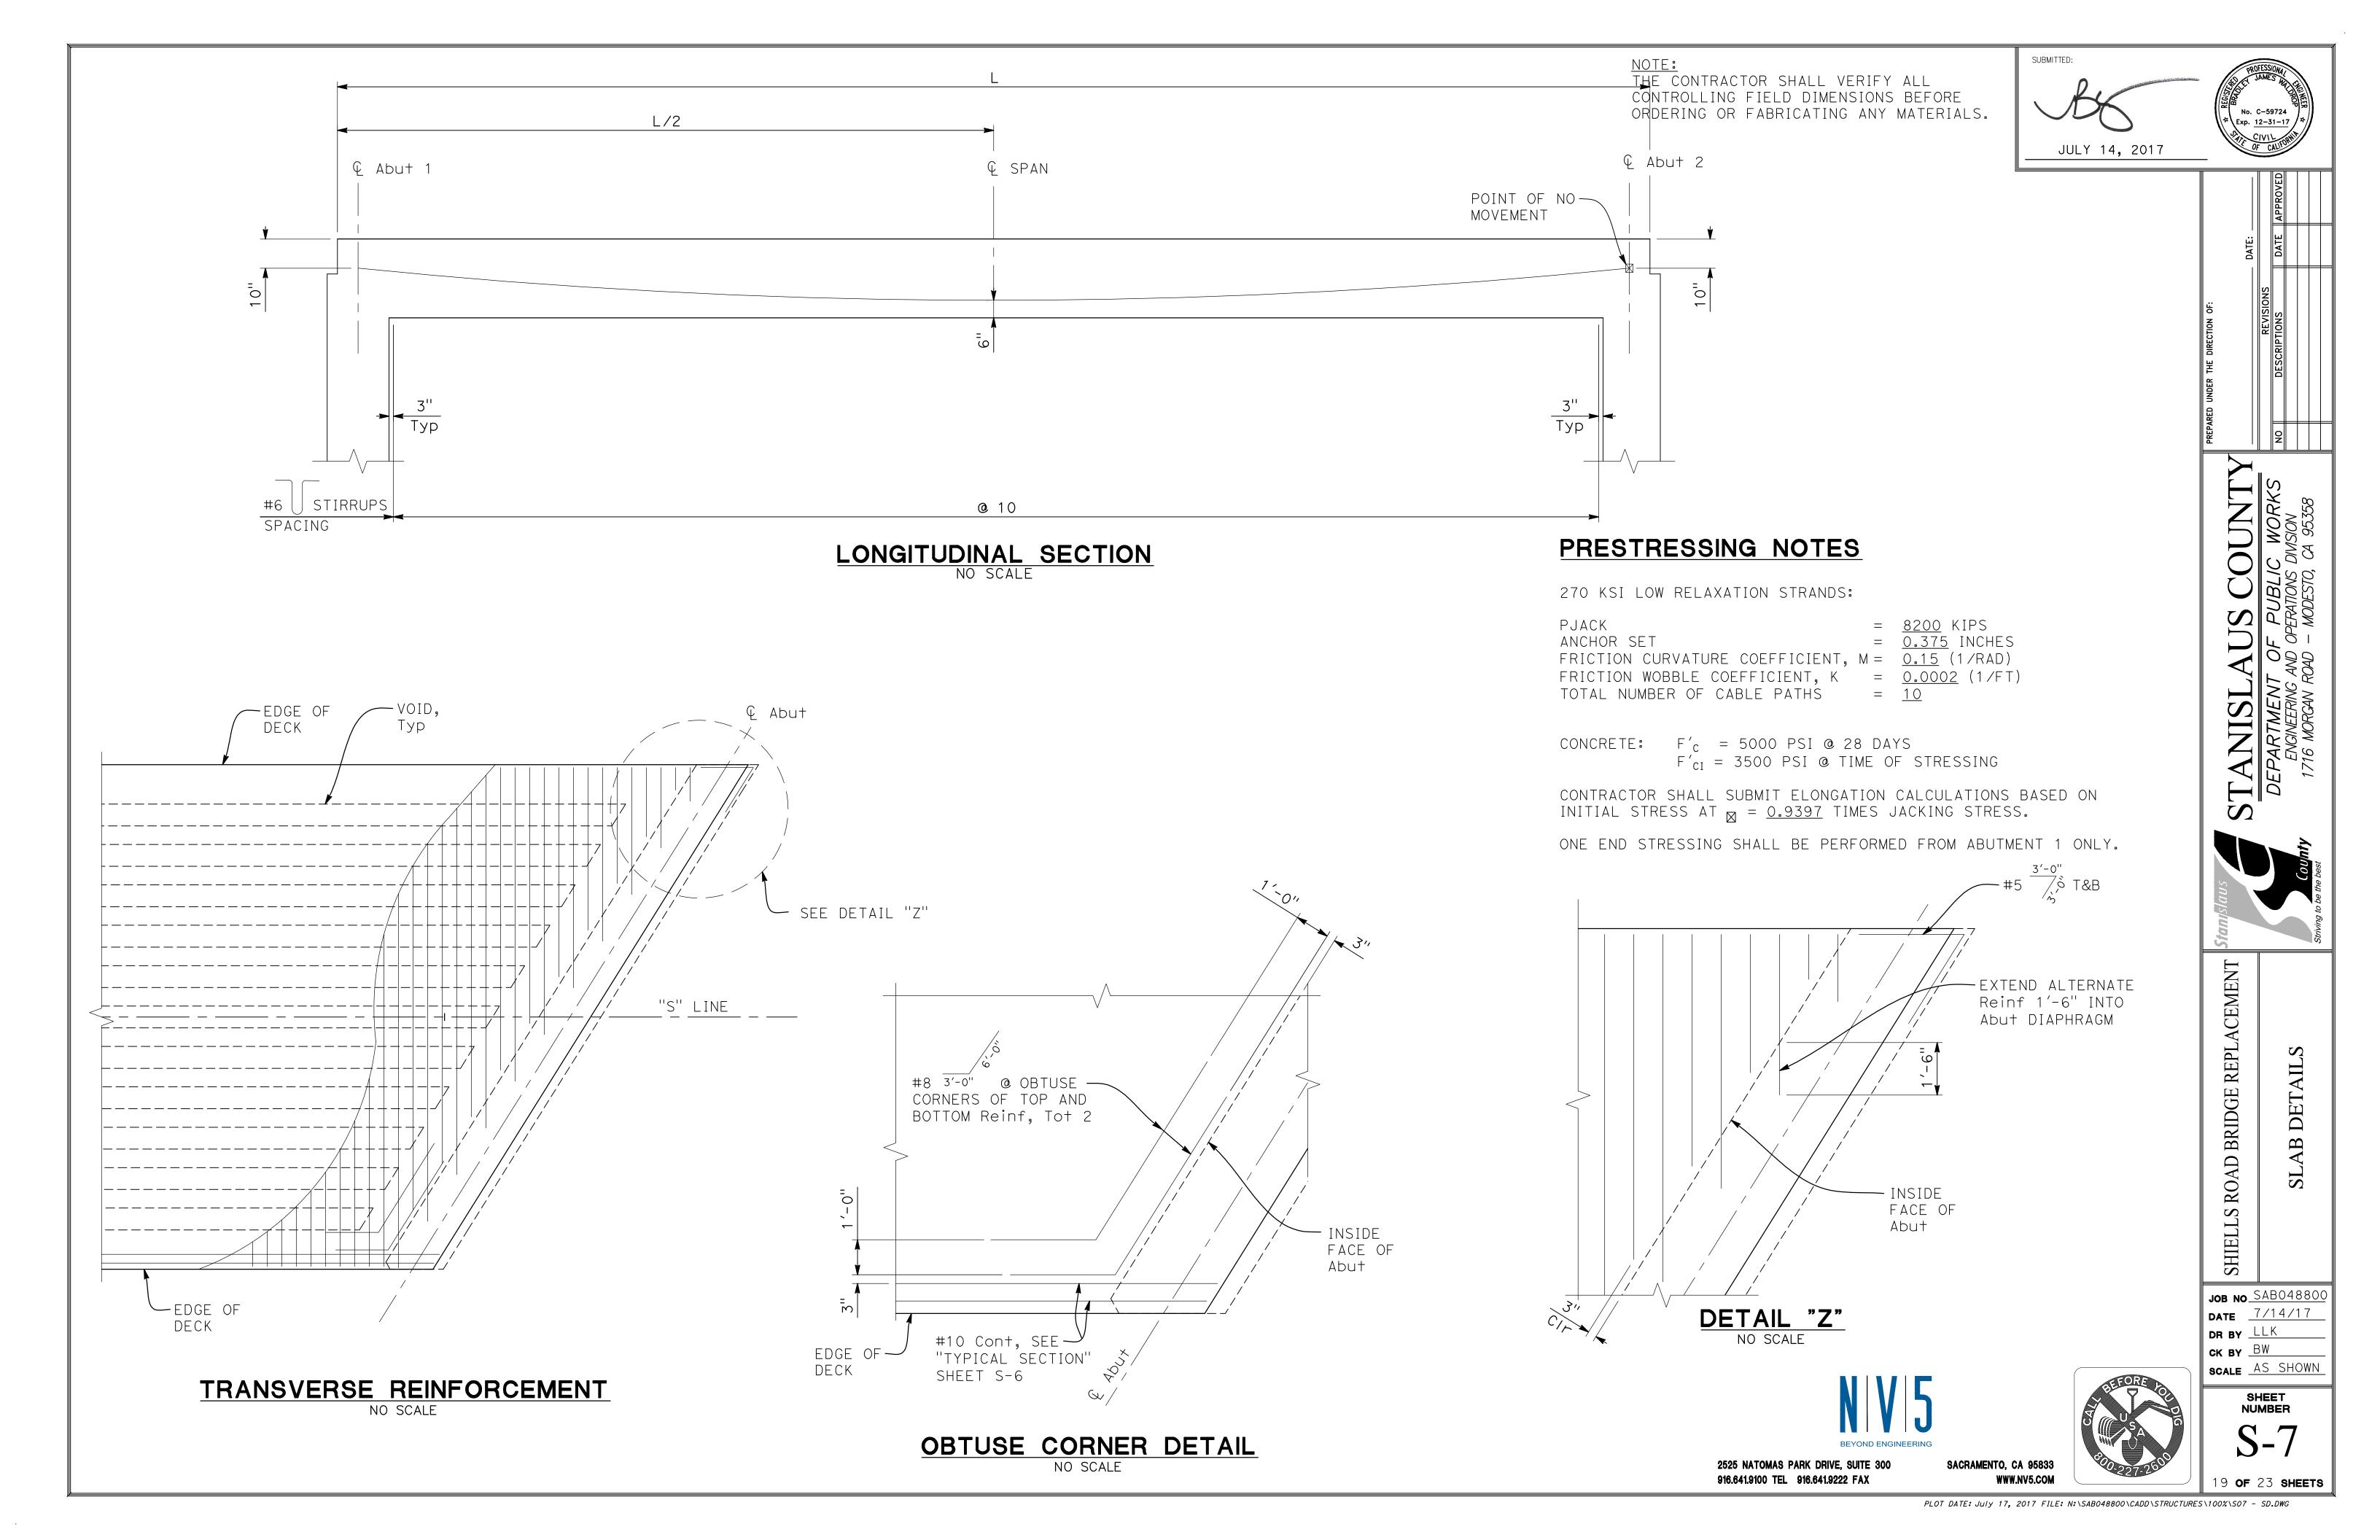

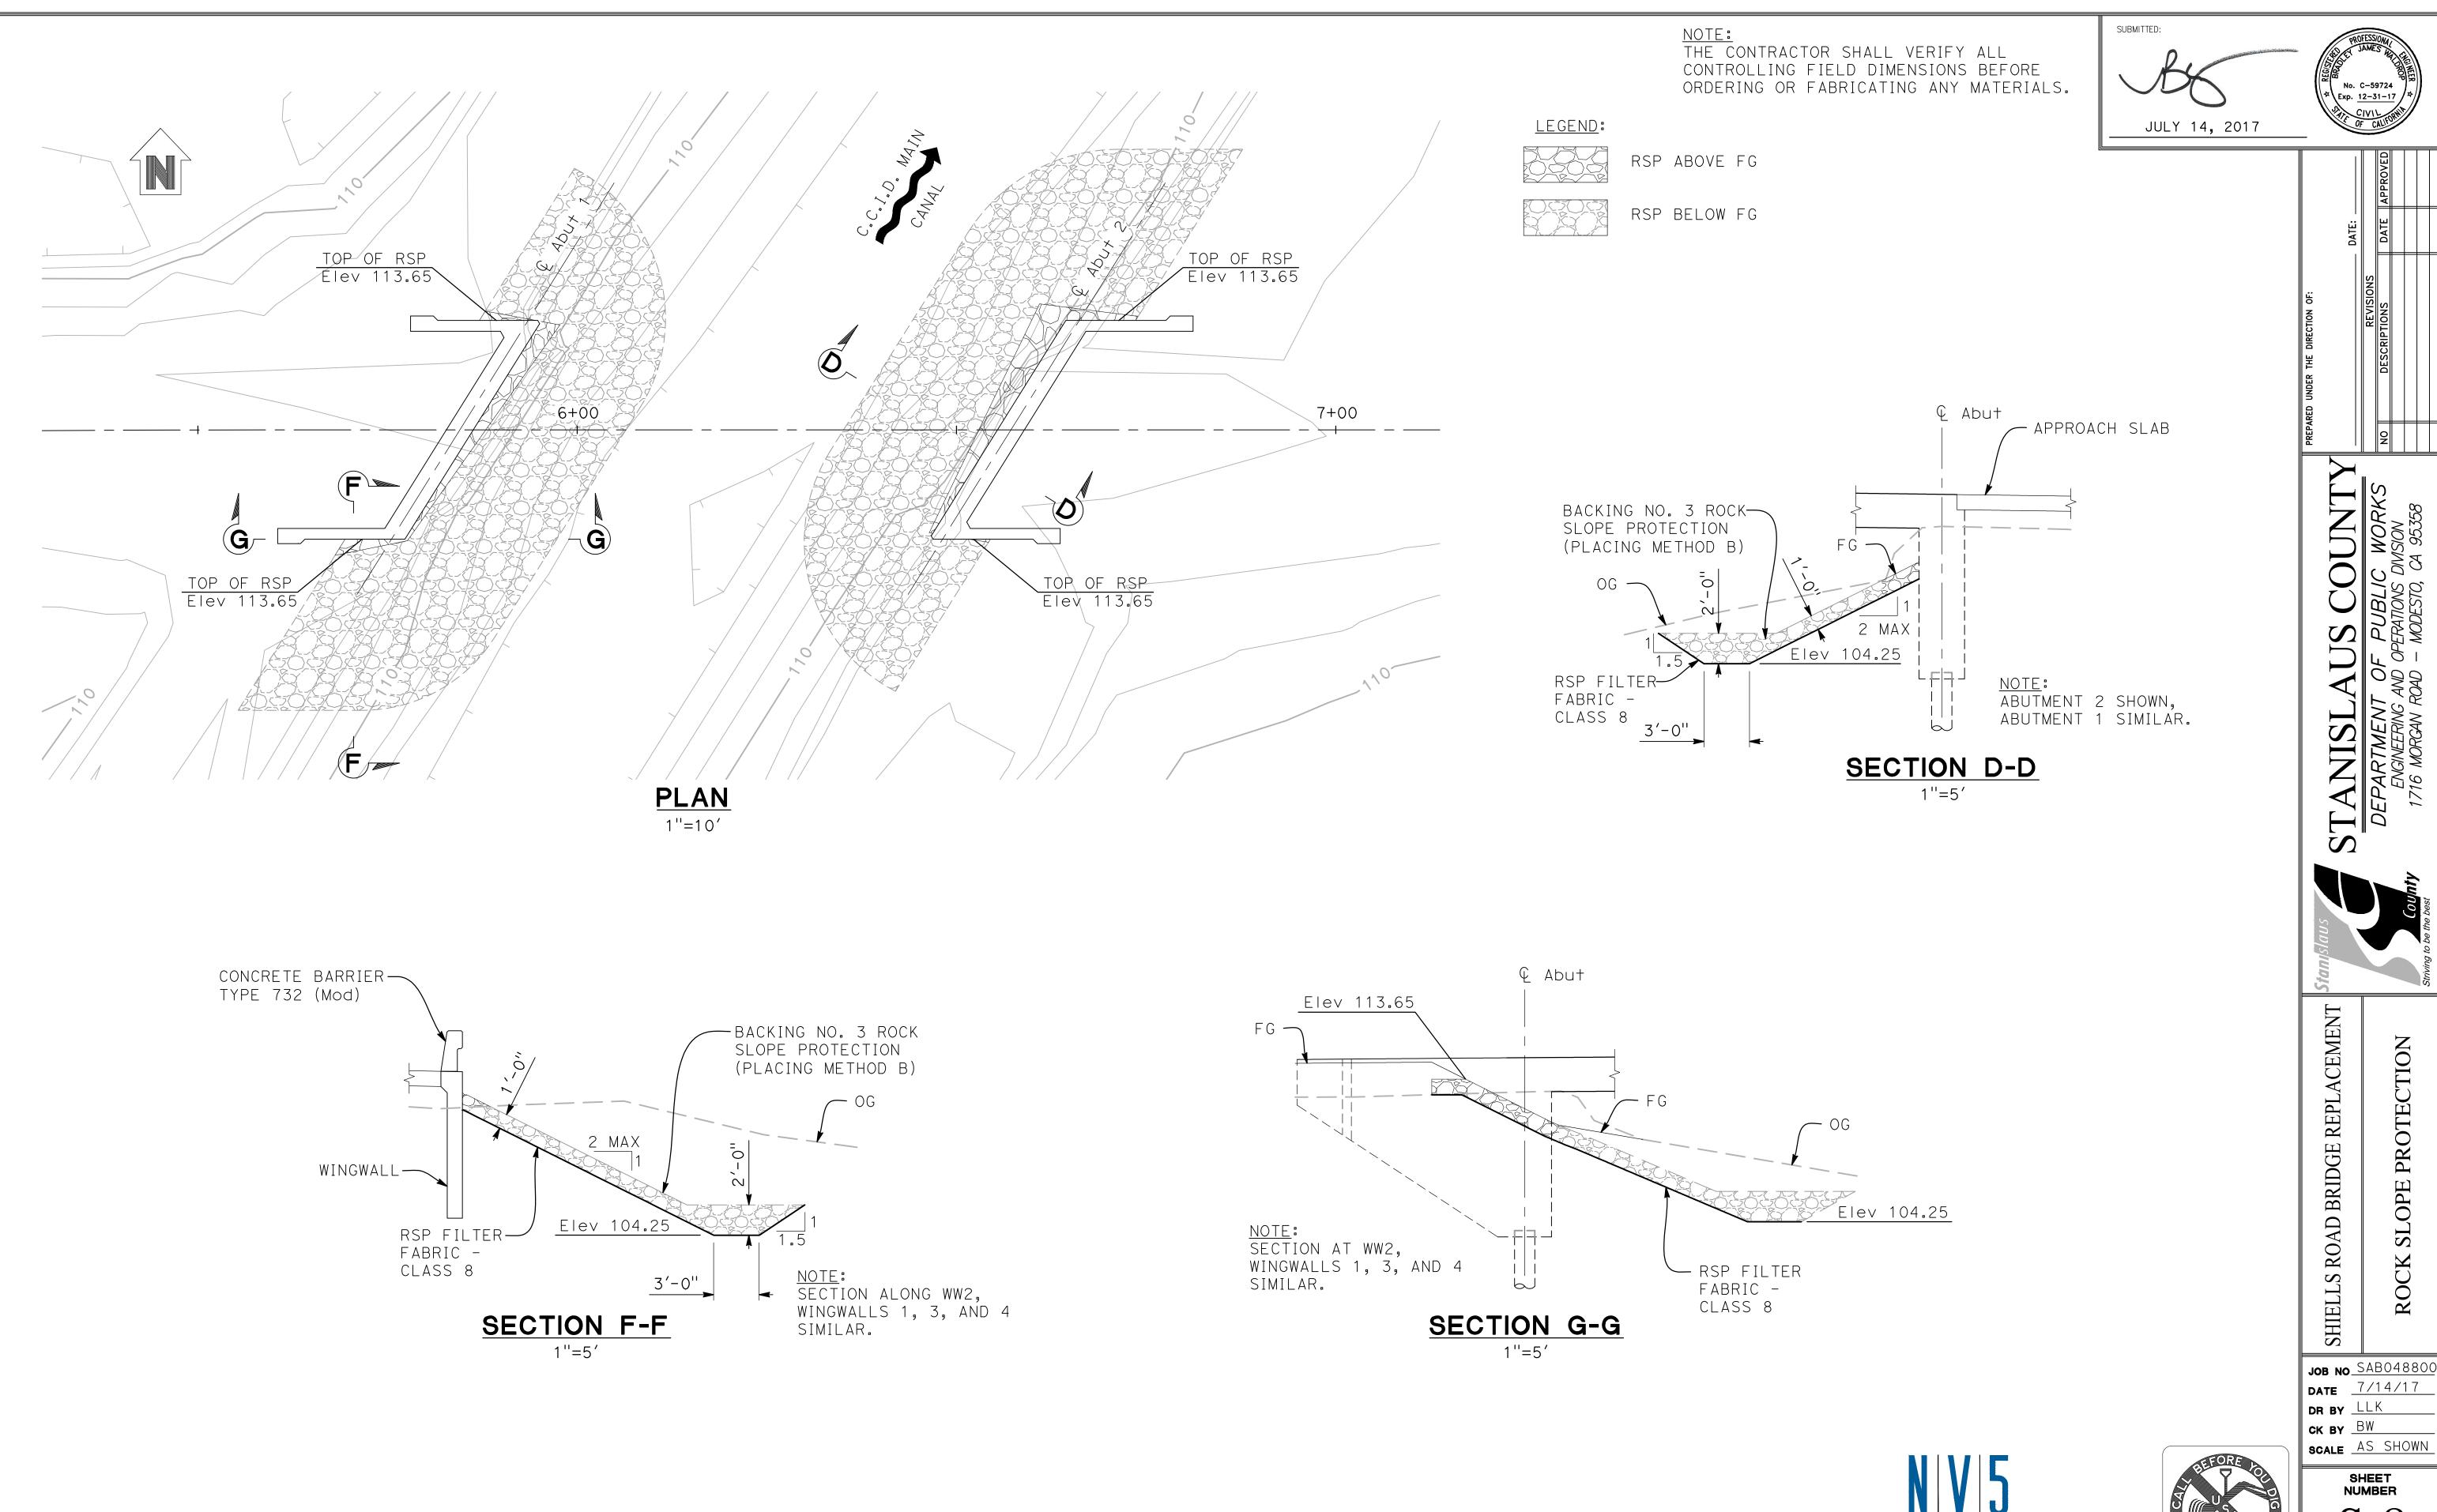


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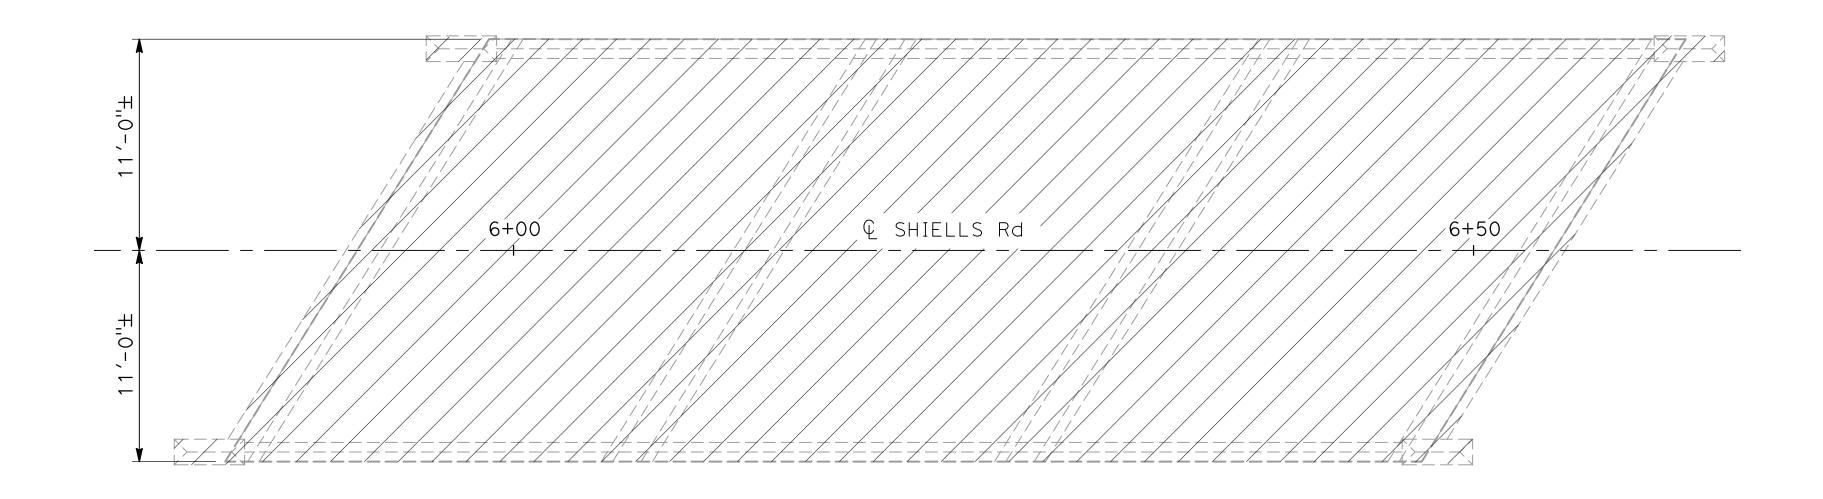
ROCK SLOPE PROTECTION



ELEVATION 1" = 5'

BRIDGE REMOVAL (SUPERSTRUCTURE, PIERS, WINGWALLS, BARRIERS AND PIER FOUNDATIONS)


BRIDGE REMOVAL (ABUTMENTS AND ABUTMENT FOUNDATIONS)

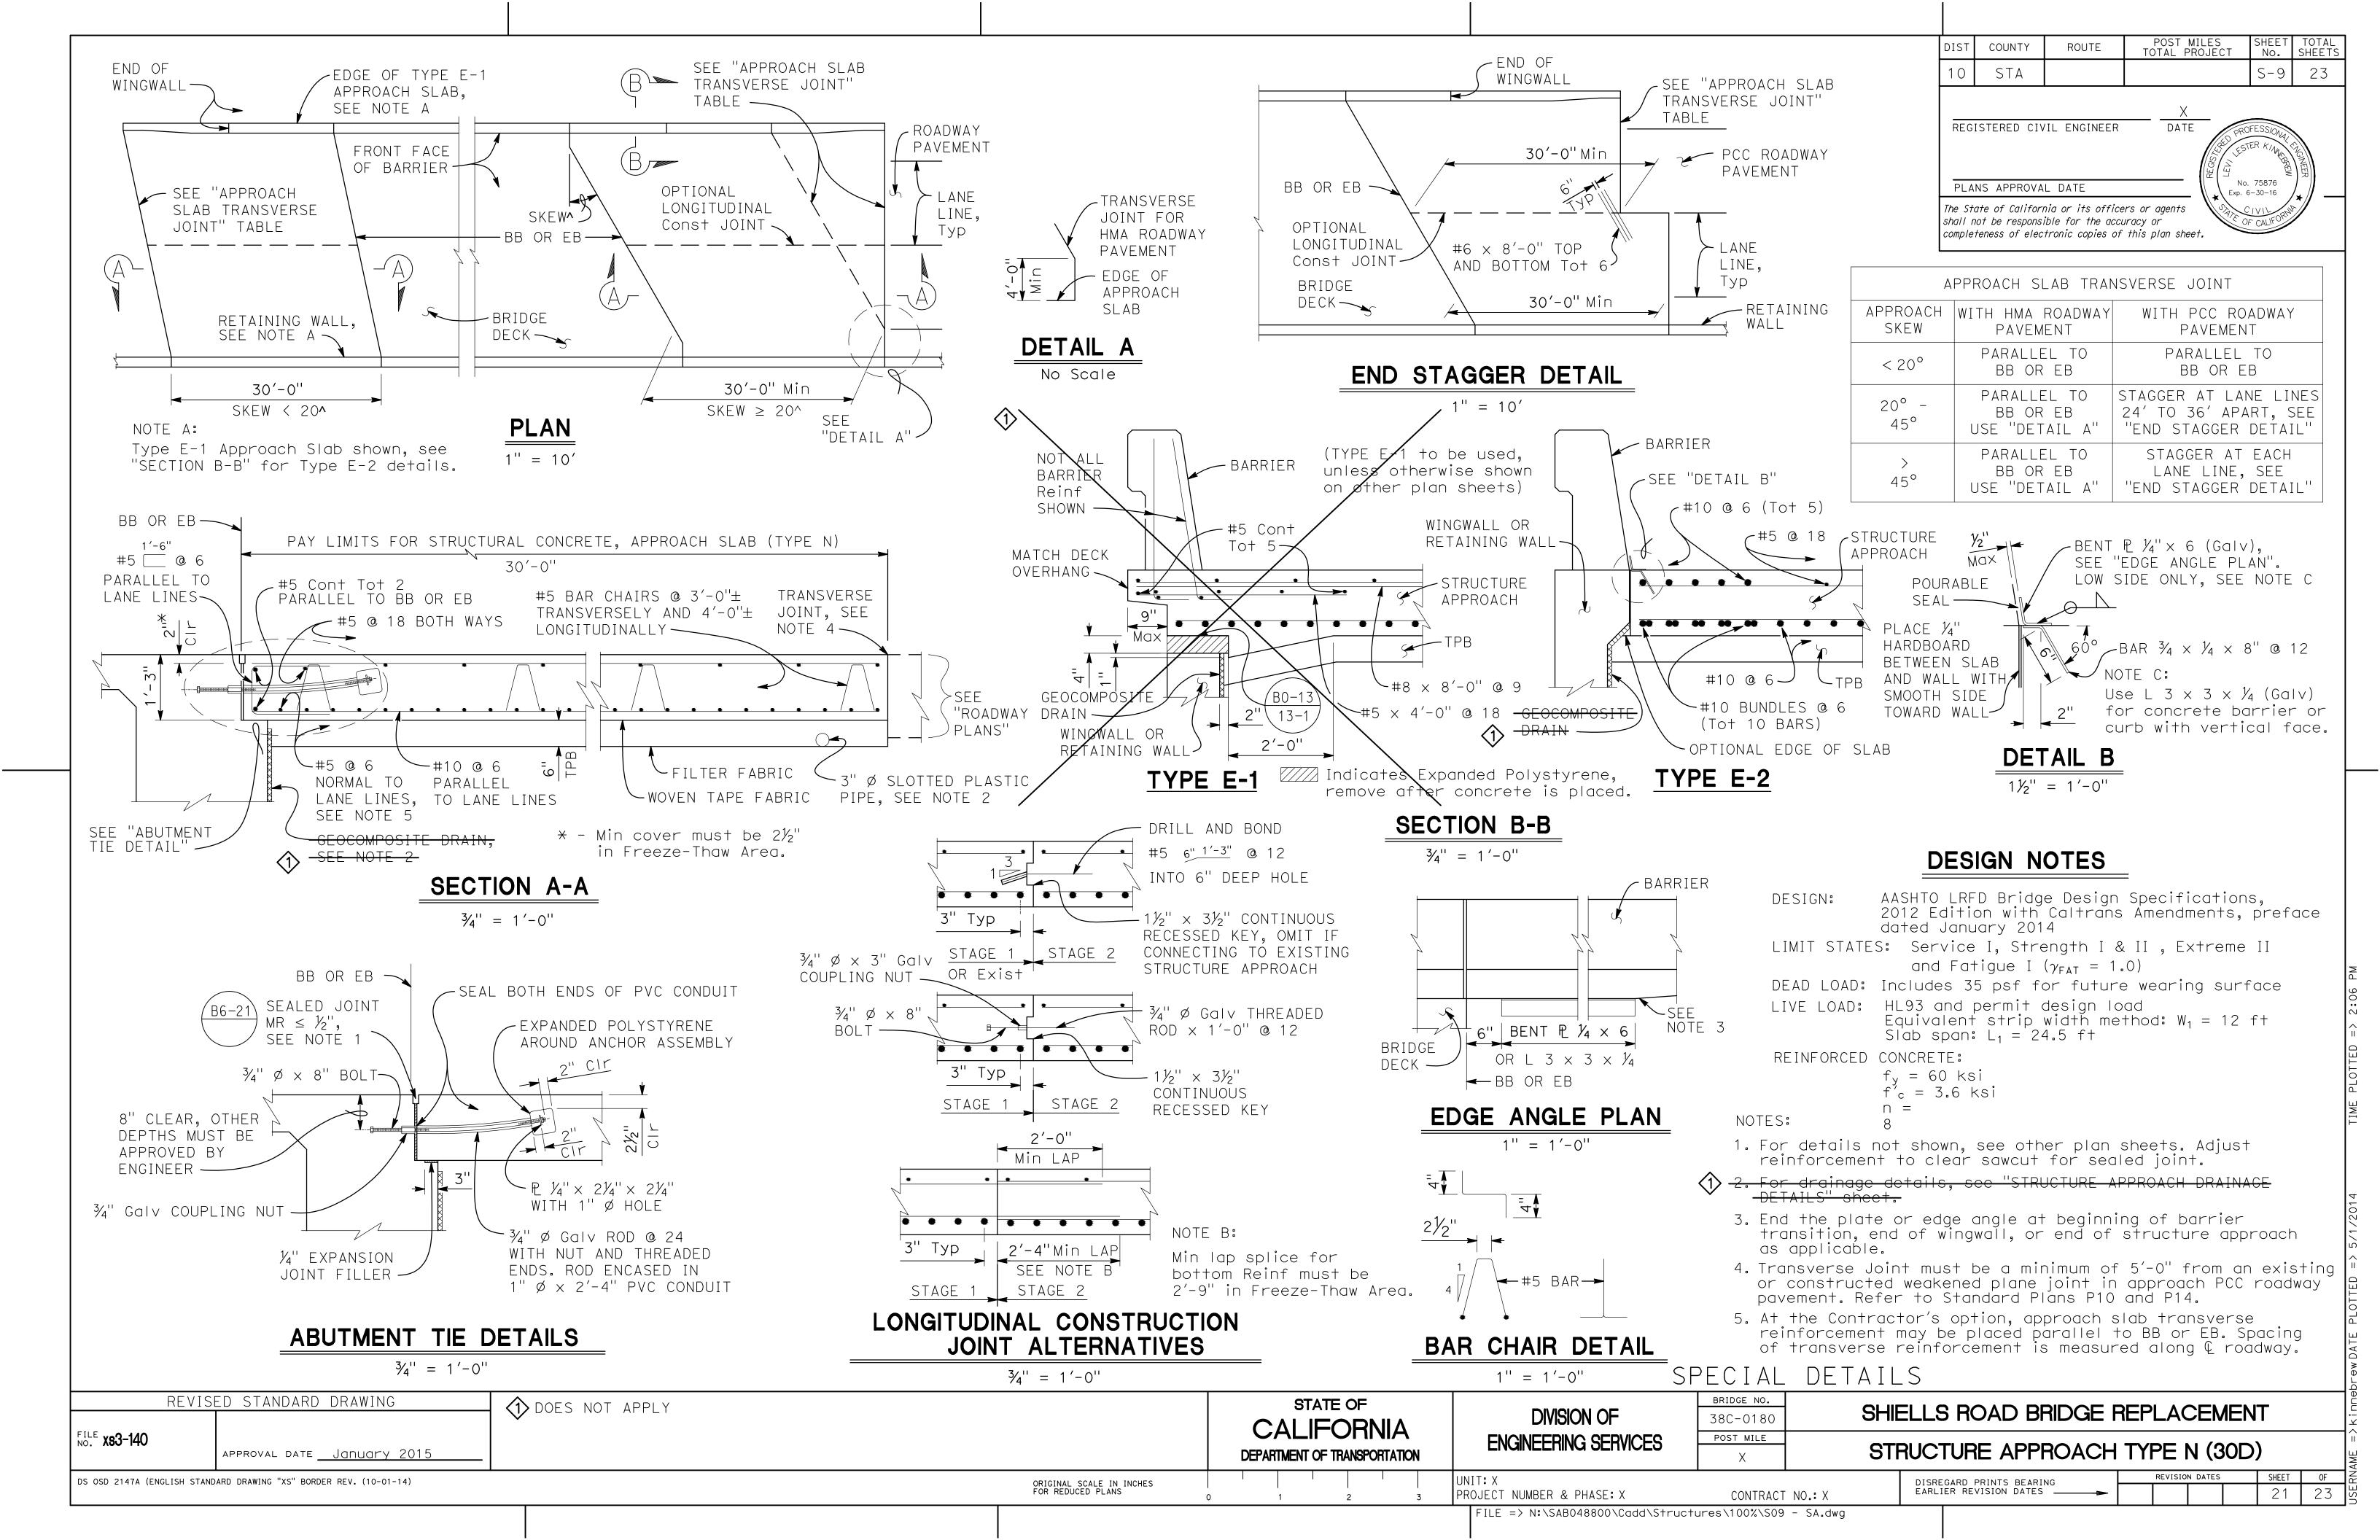

PLAN1'' = 5'

NOTE: The contractor shall verify all CONTROLLING FIELD DIMENSIONS BEFORE ORDERING OR FABRICATING ANY MATERIALS.



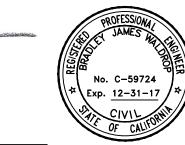

JULY 14, 2017

22'-0"± & EXISTING BRIDGE 10'-0"± 10'-0"± 1'-0"±

SHIELLS ROAD BRIDGE REPLACEMENT

JOB NO SAB048800 DATE 1/25/16

SCALE AS SHOWN

SHEET NUMBER

DR BY LLK

CK BY BW

1'-0"± <u>-2.5%</u>± -<u>2.5%</u>±

EXISTING TYPICAL SECTION

- NOTES: 1. EXISTING BRIDGE INFORMATION IS BASED ON FIELD DIMENSIONS. THE CONTRACTOR SHALL VERIFY EXISTING CONDITIONS AND DIMENSIONS PRIOR TO REMOVAL.
- 2. THE CONTRACTOR SHALL REMOVE THE EXISTING BRIDGE SUPERSTRUCTURE, PIER WALL, PIER FOUNDATIONS, WINGWALLS AND BARRIÉRS PRIOR TO STARTING BRIDGE CONSTRUCTION.
- 3. AFTER THE NEW ABUTMENTS HAVE BEEN CONSTRUCTED, THE EXISTING ABUTMENTS AND ABUTMENT FOUNDATIONS CAN BE DEMOLISHED.
- 4. IT SHALL BE THE CONTRACTOR'S RESPONSIBILITY TO PROPERLY DISPOSE OF ALL DEMOLITION MATERIALS IN ACCORDANCE WITH THE SPECIAL PROVISIONS AND THE CONTRACT REQUIREMENTS.



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